SHEET INDEX

<u>NO.</u>		
1	COVE	R SHEET - SHEET INDEX
	CIVIL	PLANS
2	TM.1	VESTING TENTATIVE MAP - EXISTING PROPERTY
3	TM.2	VESTING TENTATIVE MAP - SITE PLAN
4	TM.3	VESTING TENTATIVE MAP - GRADING PLAN
5	TM.4	VESTING TENTATIVE MAP - UTILITY PLAN
6	TM.5	VESTING TENTATIVE MAP - OPEN SPACE EXHIBIT

NO.	LANDSCAPE PLANS		
7	L-0	COVER SHEET	
8	L-1	LAYOUT AND PLANTING LEGEND	
9	L-2	TREE REMOVAL PLAN	
10	L-3	LANDSCAPE CONCEPT	
11	L-4	CONCEPTUAL ENLARGEMENT PLAN	
12	L-5	LANDSCAPE DETAILS	
13	L-6	LANDSCAPE DETAILS	
14	L-7	LANDSCAPE DETAILS	
15	L-8	IRRIGATION CONCEPT	
16	L-9	IRRIGATION NOTES AND LEGEND	
17	L-10	IRRIGATION DETAILS	
18	L-11	IRRIGATION DETAILS	

<u>NO.</u>	ARCI	ARCHITECTURAL PLANS		
19	A01	STREET SCENE		
20	A02	PLAN 1 FRONT ELEVATIONS AND ROOF PLANS		
21	A03	PLAN 1 'A' ELEVATIONS AT INTERIOR LOTS		
22	A04	PLAN 1 'B' ELEVATIONS AT INTERIOR LOTS		
23	A05	PLAN 1 'C' ELEVATIONS AT INTERIOR LOTS		
24	A06	PLAN 1 'B' ENHANCED ELEVATIONS		
25	A07	PLAN 1 FLOOR PLANS		
26	A08	PLAN 2 FRONT ELEVATIONS AND ROOF PLANS		
27	A09	PLAN 2 'A' ELEVATIONS AT INTERIOR LOTS		
28	A10	PLAN 2 'B' ELEVATIONS AT INTERIOR LOTS		
29	A11	PLAN 2 'C' ELEVATIONS AT INTERIOR LOTS		
30	A12	PLAN 2 'A' ENHANCED ELEVATIONS		
31	A13	PLAN 2 FLOOR PLANS		
32	A14	PLAN 3 FRONT ELEVATIONS AND ROOF PLANS		

<u>NO.</u>	ARCHITECTURAL PLANS		
33	A15	PLAN 3 'A' ELEVATIONS AT INTERIOR LOTS	
34	A16	PLAN 3 'B' ELEVATIONS AT INTERIOR LOTS	
35	A17	PLAN 3 'C' ELEVATIONS AT INTERIOR LOTS	
36	A18	PLAN 3 'C' ENHANCED ELEVATIONS	
37	A19	PLAN 3 FLOOR PLANS	
38	A20	MULTI-FAMILY DUET FRONT ELEVATIONS	
39	A21	MULTI-FAMILY DUET ELEVATIONS 'A' AT INTERIOR LOTS	
40	A22	MULTI-FAMILY DUET ELEVATIONS 'B' AT INTERIOR LOTS	
41	A23	MULTI-FAMILY DUET ELEVATIONS 'C' AT INTERIOR LOTS	
42	A24	MULTI-FAMILY DUET 'A' ENHANCED ELEVATIONS	
43	A25	MULTI-FAMILY DUET 'C' ENHANCED ELEVATIONS	
44	A26	MULTI-FAMILY DUET ROOF PLANS	
45	A27	MULTI-FAMILY DUET FIRST AND SECOND FLOOR PLANS	
46	A28	MULTI-FAMILY DUET THIRD FLOOR PLAN	

DEVELOPER

KB HOME SOUTH BAY, INC, 5000 EXECUTIVE PARKWAY, SUITE 125 SAN RAMON, CA 94583 (925) 983-4527 CONTACT: RAY PANEK

CIVIL ENGINEER

CARLSON, BARBEE & GIBSON, INC. 2633 CAMINO RAMON, SUITE 350 SAN RAMON, CA 94583 (925) 866-0322 CONTACT: LEE ROSENBLATT

LANDSCAPE ARCHITECT

GATES + ASSOCIATES
2671 CROW CANYON RD.
SAN RAMON,CA 94583
(925) 736-8176
CONTACT: MELONIE O' SULLIVAN

ARCHITECT

SDG ARCHITECTS, INC.
3361 WALNUT BLVD. SUIT 120
BRENTWOOD, CA 94513
(925) 634-7000
CONTACT: RALPH STRAUSS



MARCH 7, 2016









AMARAL PROPERTIES-TRACT 8266 PLANNED DEVELOPMENT


HAYWARD, CALIFORNIA




2633 CAMINO RAMON, SUITE 350 SAN RAMON, CALIFORNIA 94583 (925) 866-0322 www.cbandg.com

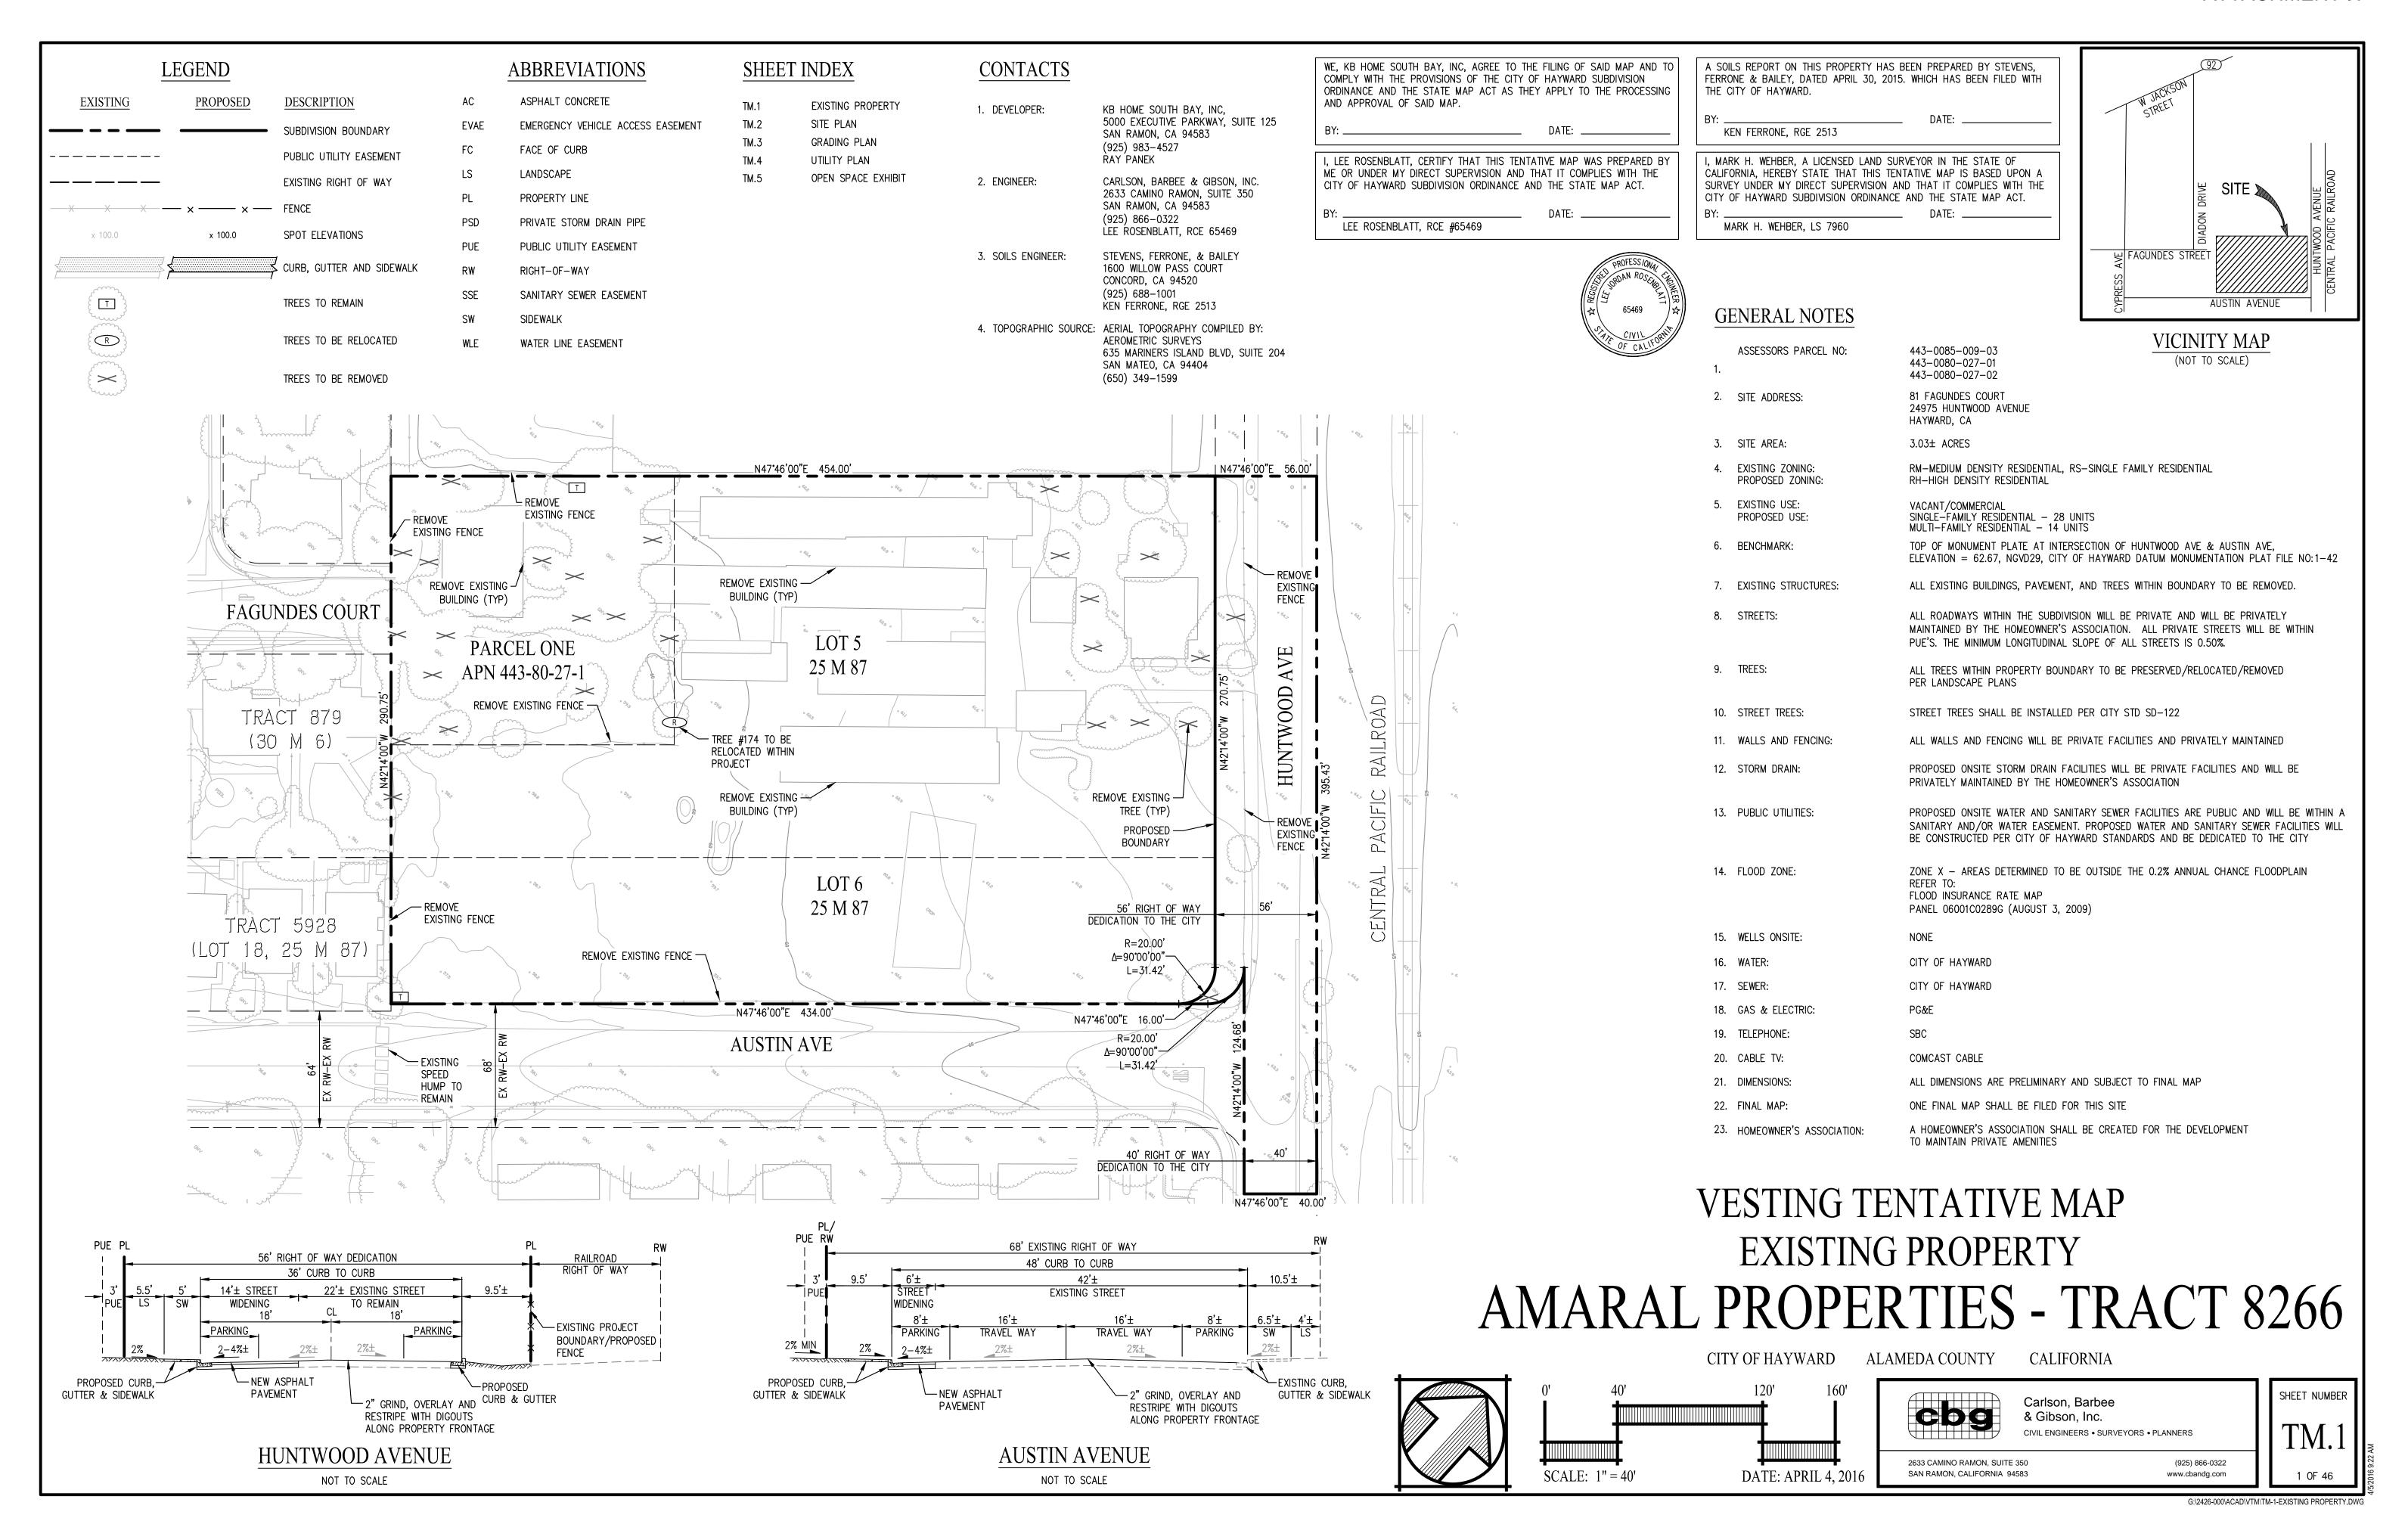

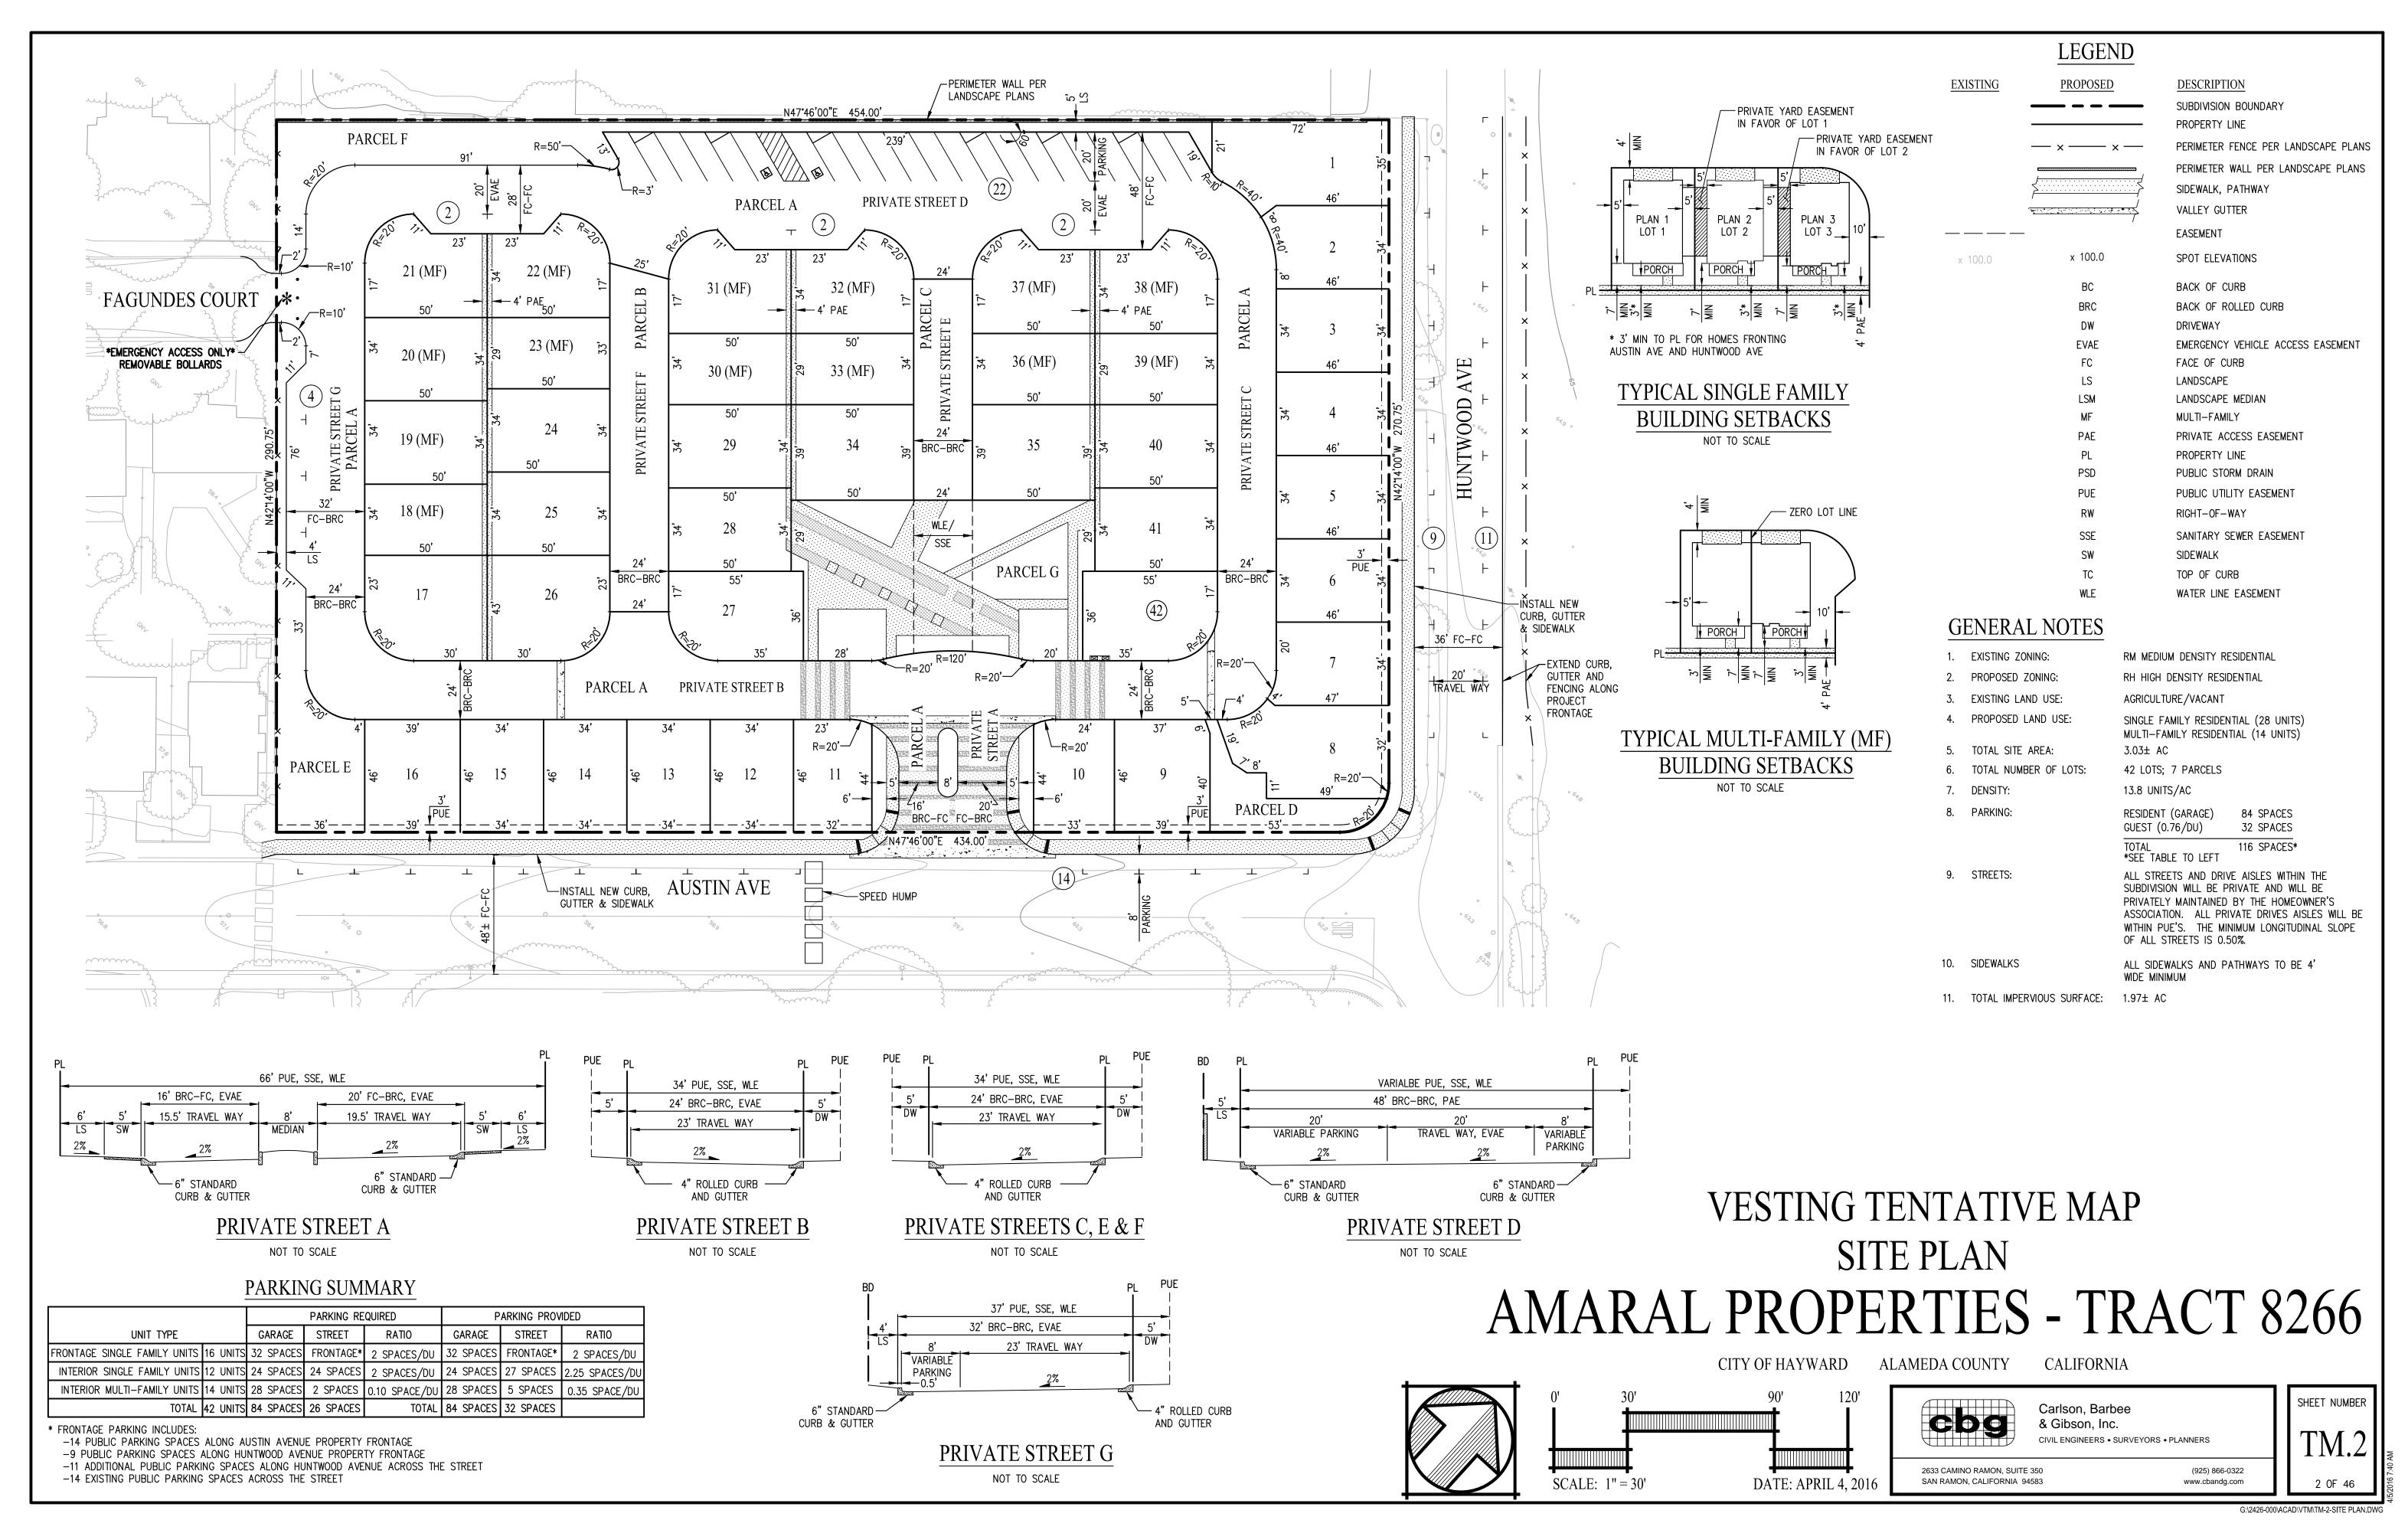

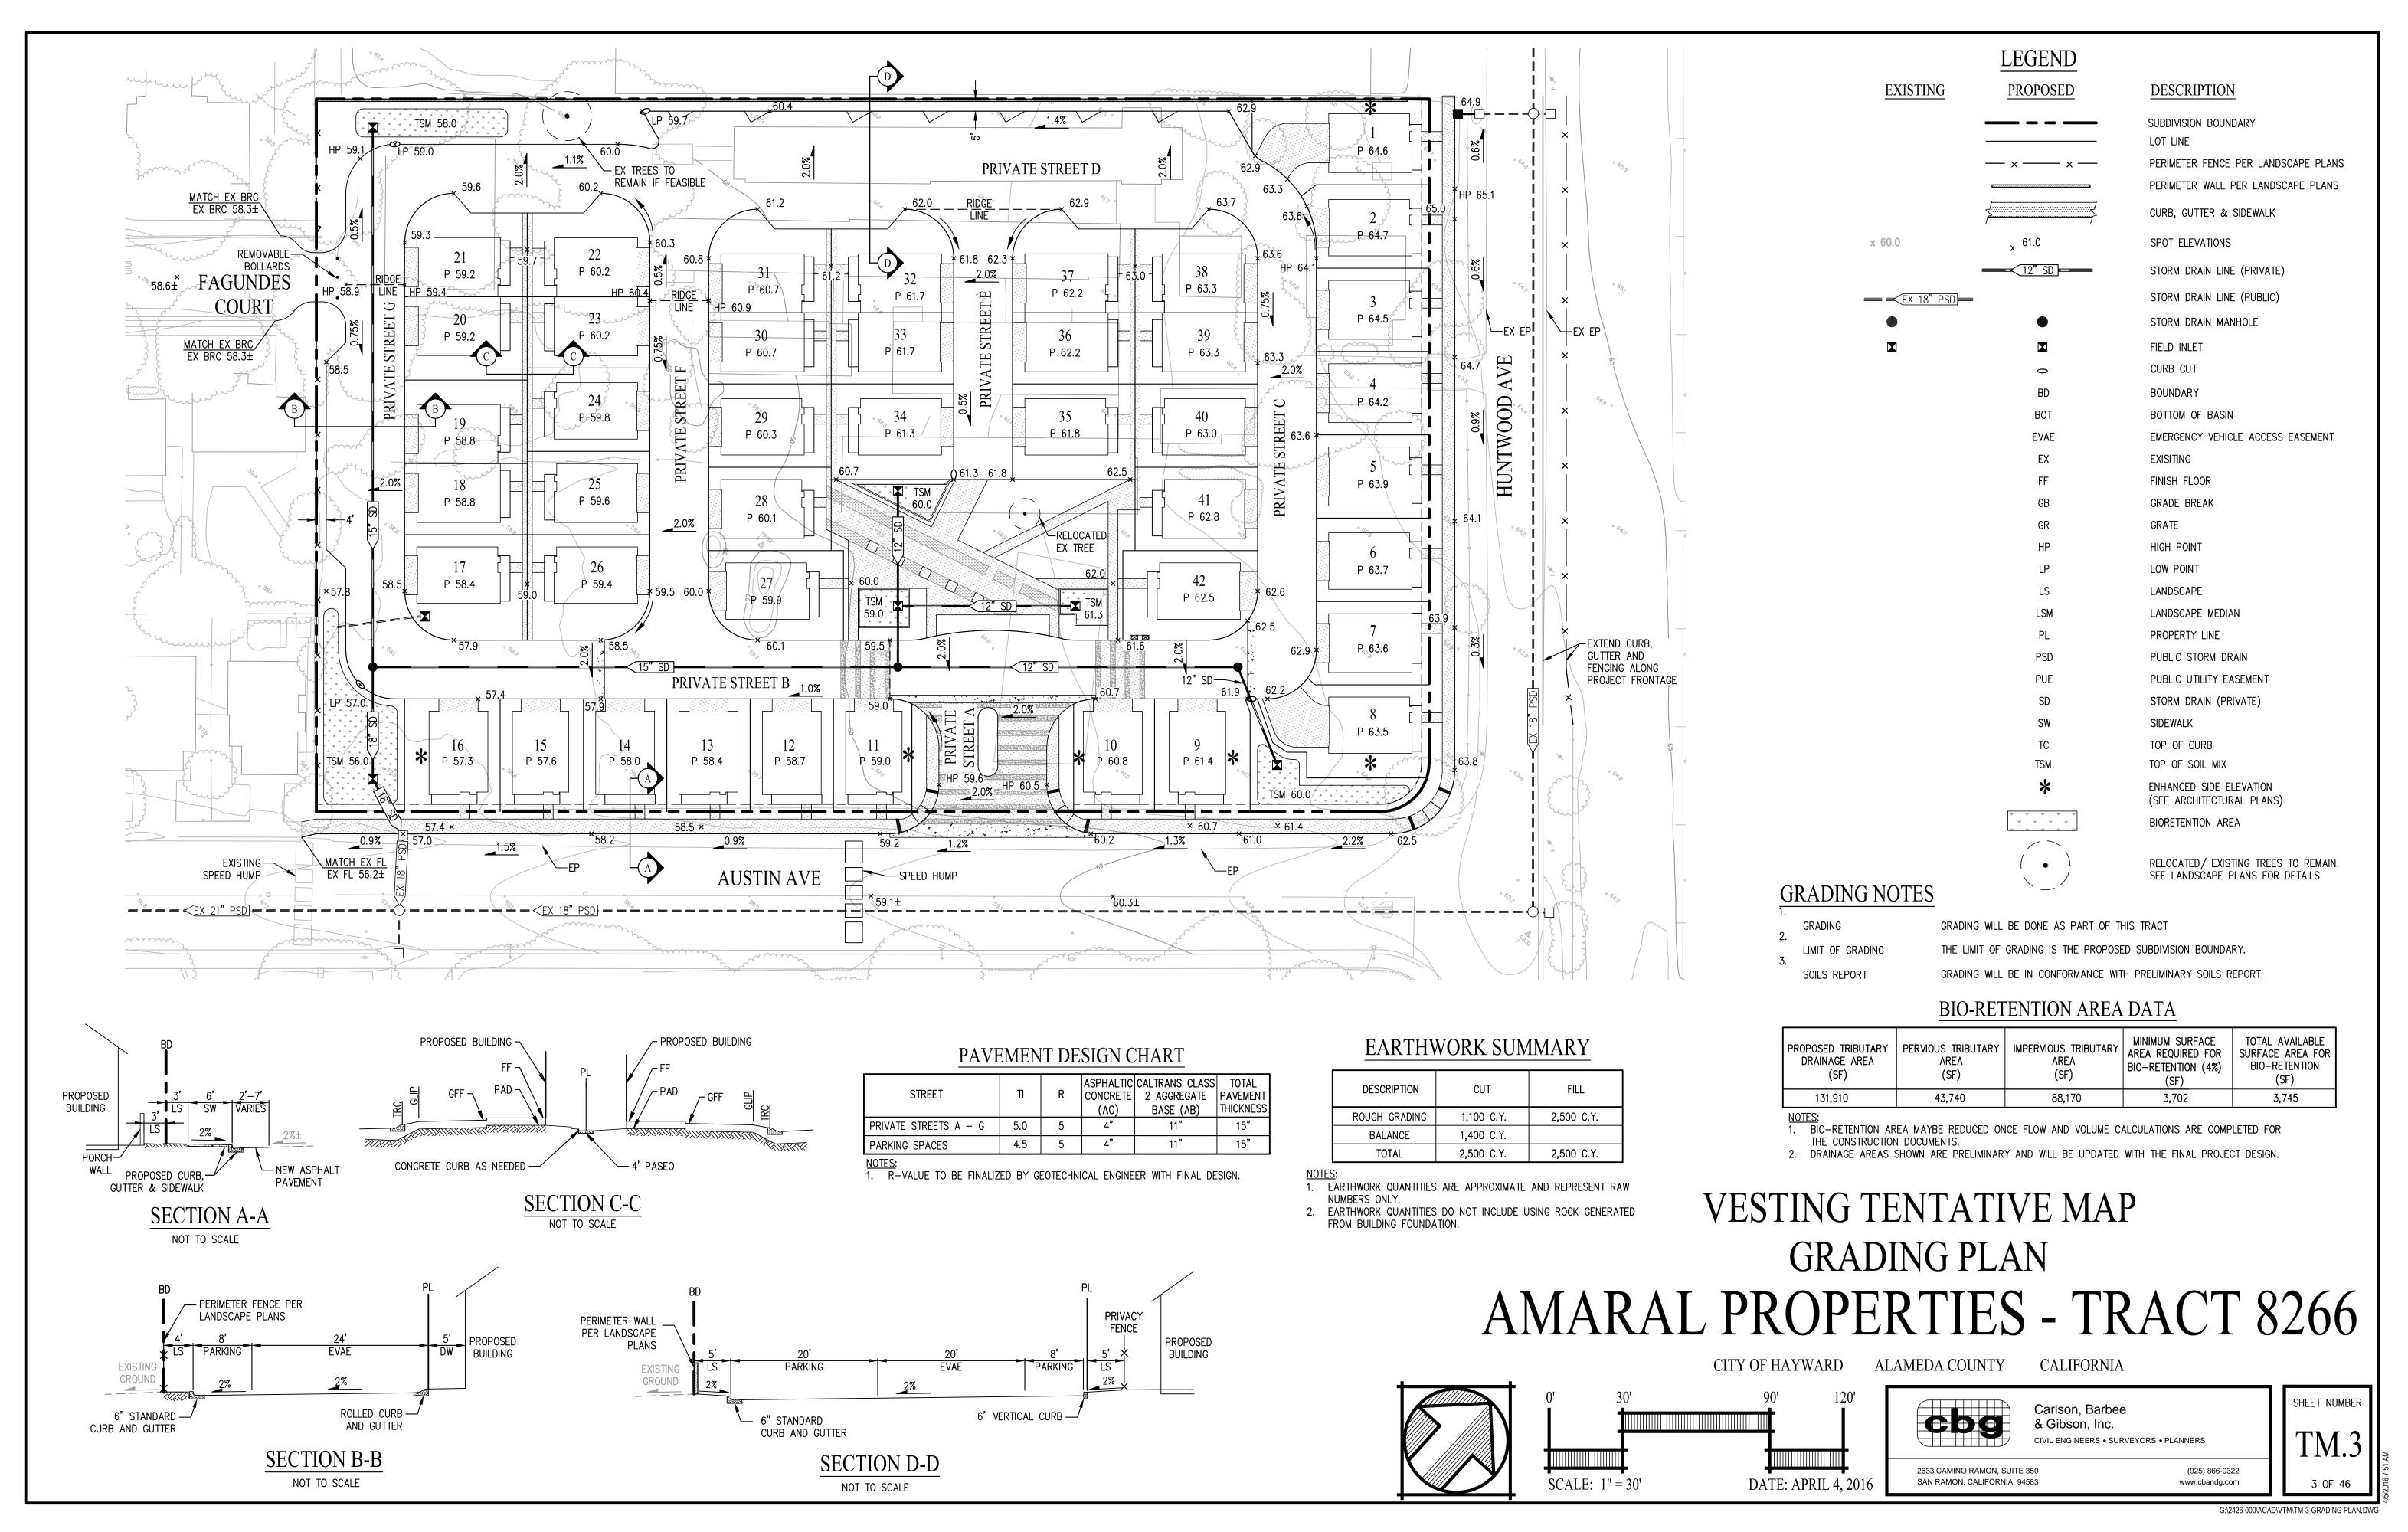

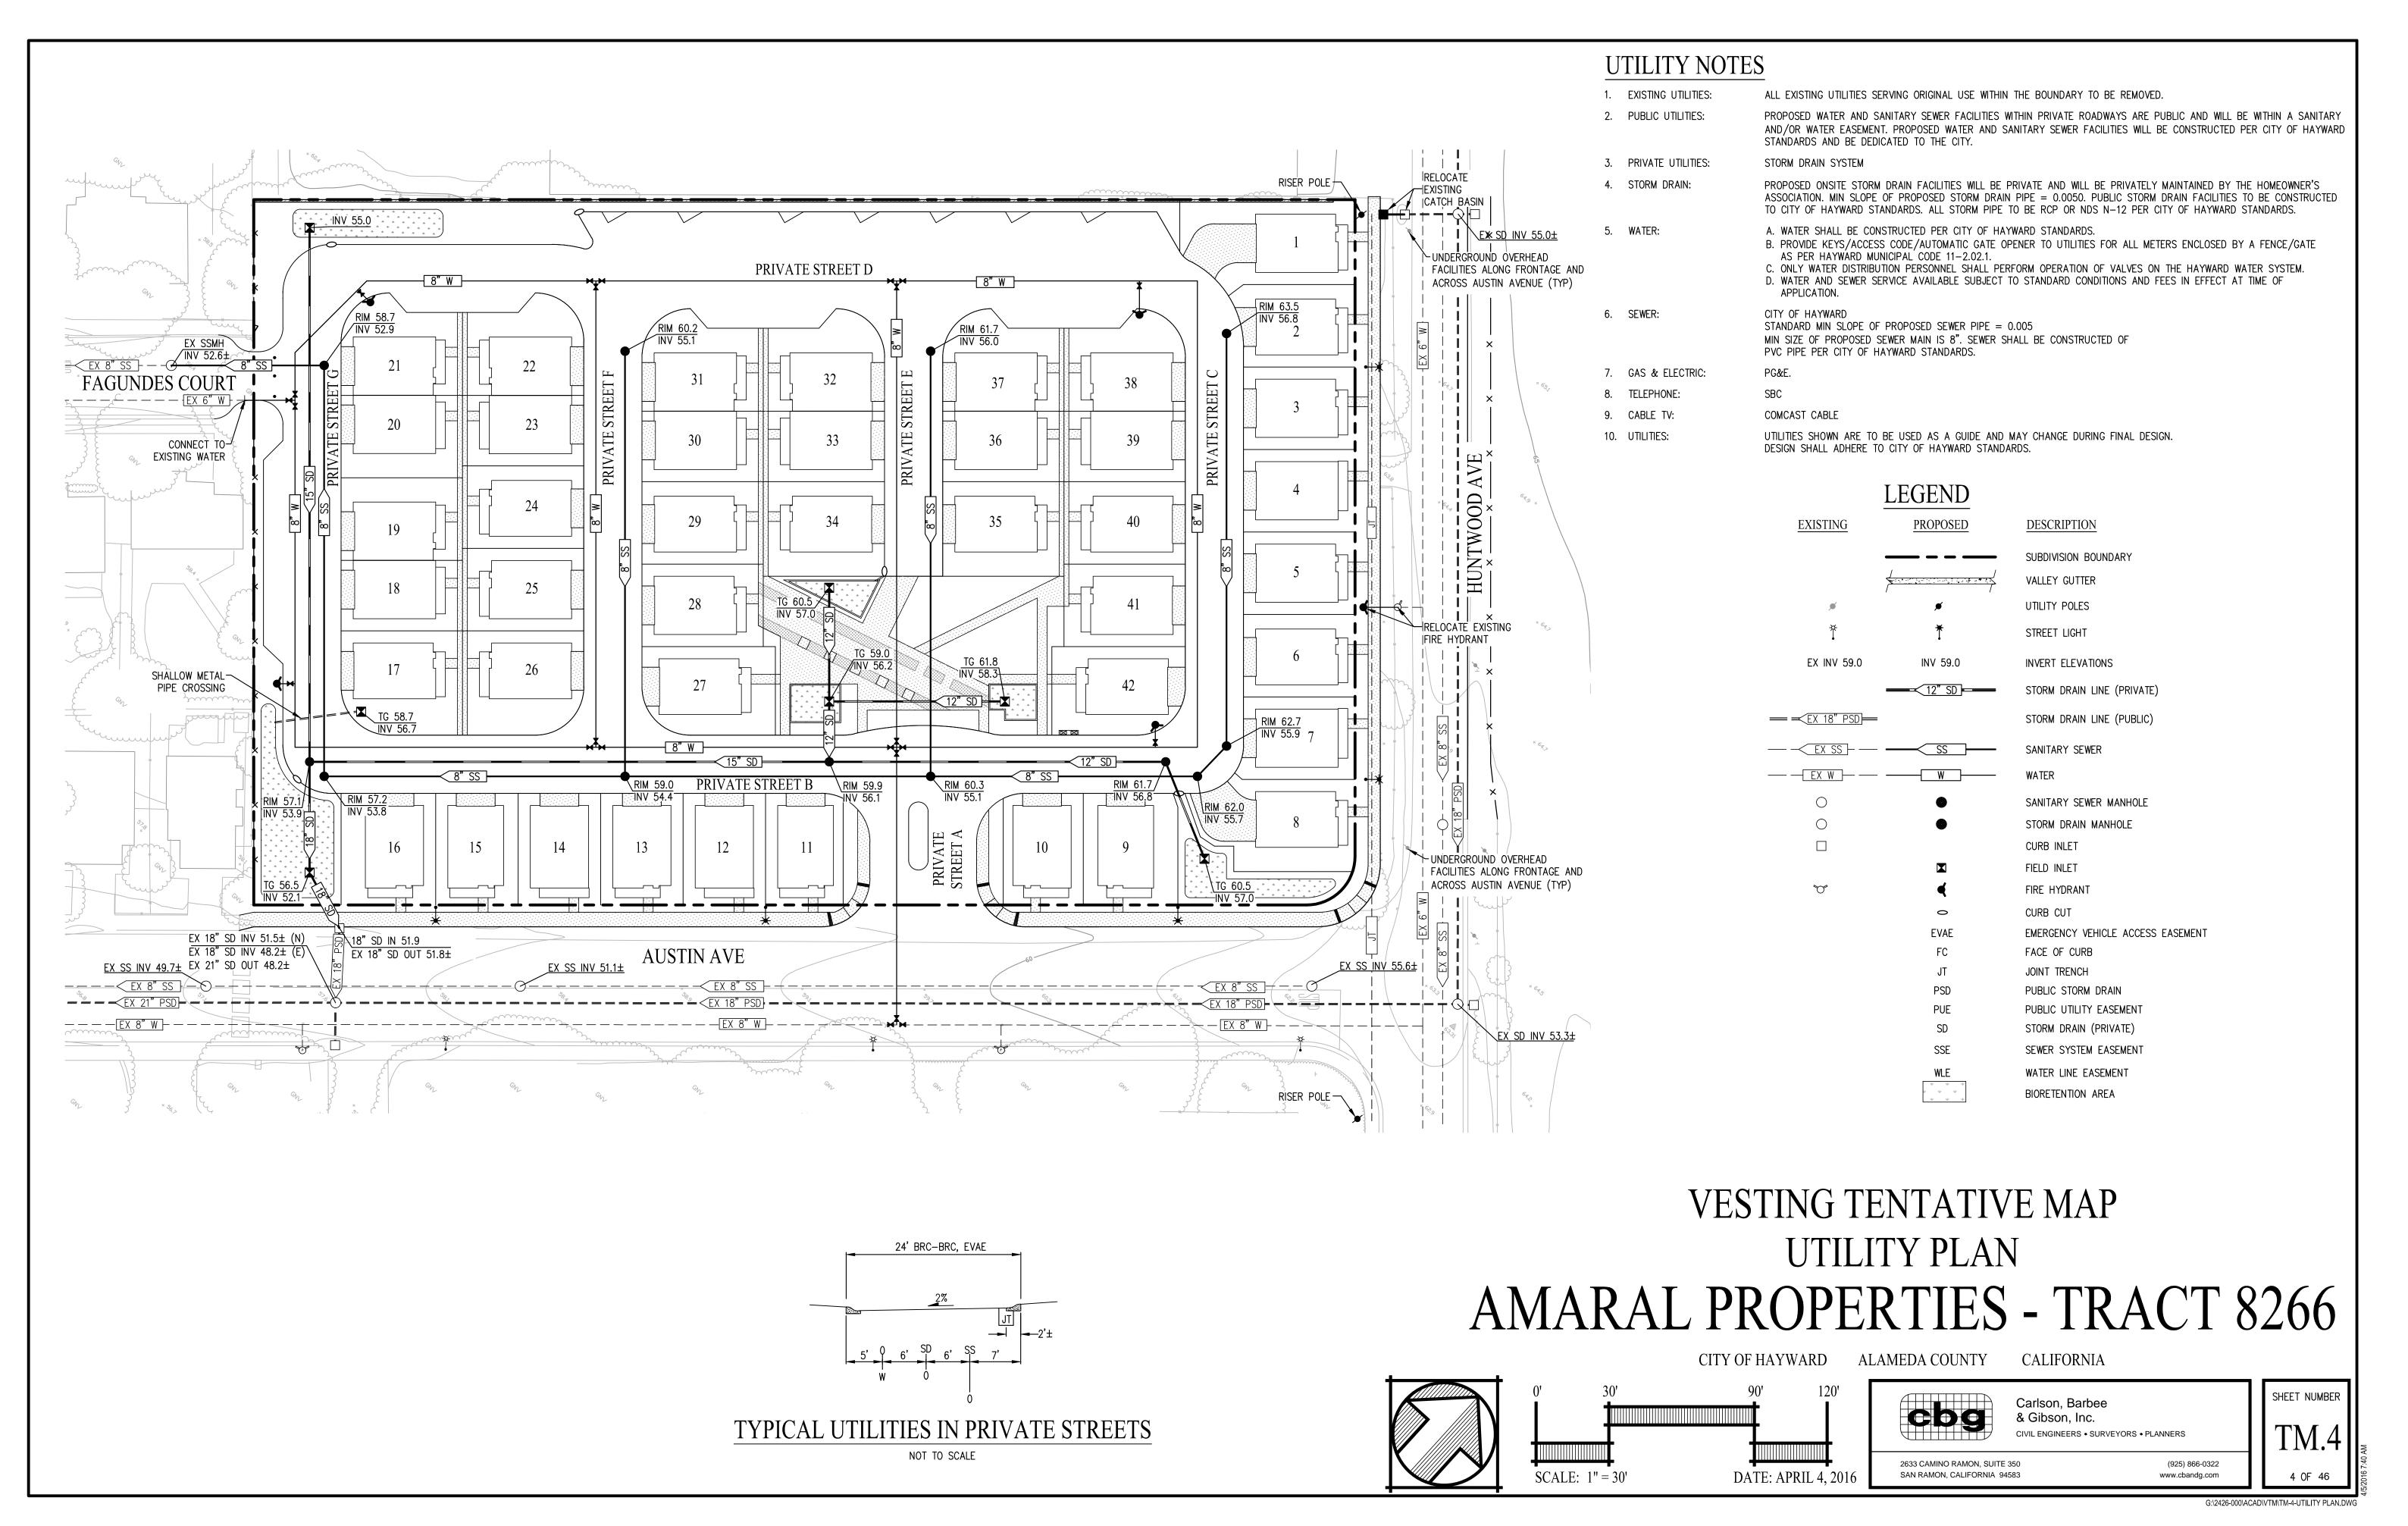



<u>LEGEND</u>	
PROPOSED	DESCRIPTION
	BOUNDARY
///////////////////////////////////////	PERIMETER WALL
— × — — × —	PERIMETER FENCE
	SPOT ELEVATIONS
* * * * * * *	BIORETENTION AREA
	COMMON OPEN SPACE
	PRIVATE OPEN SPACE
LSM	LANDSCAPE MEDIAN
	PROPOSED

COMMON OPEN SPACE SUMMARY					
UNIT TYPE	REQUIRED COMMO				
ONIT TIFE	RATIO	AREA (SF)	PROVIDED COMMON		
SINGLE FAMILY (28 UNITS)	0 SF/UNIT	0 SF	OPEN SPACE		
MULTI-FAMILY (14 UNITS)	100 SF/UNIT*	1,400 SF			
TOTAL (42 UNITS)	BLENDED	1,400 SF	5,800 SF		


PRIVATE OPEN SPACE SUMMARY						
UNIT TYPE	REQUIRED PRIVATE OPEN SPACE		PROVIDED PRIVATE OPEN SPACE			
	RATIO	AREA (SF)	AREA (SF)			
SINGLE FAMILY (28 UNITS)	0 SF/UNIT	0 SF	6,700 SF			
MULTI-FAMILY (14 UNITS)	250 SF/UNIT*	3,500 SF	6,400 SF**			
TOTAL (42 UNITS)	BLENDED	3,500 SF	13,100 SF			

* MULTI-FAMILY OPEN SPACE REQUIRES 350 SF OF USABLE OPEN SPACE PER UNIT WITH A MINIMUM OF 100 SF/UNIT TO BE PROVIDED IN THE COMMON OPEN SPACE.

** MULTI-FAMILY UNITS WITH A MINIMUM 10'X10' PRIVATE OPEN SPACE MAY DOUBLE COUNT THE AREA PER SECTION 10-1.500 HIGH DENSITY RESIDENTIAL DISTRICT (RH). ALL 14 MULTI-FAMILY UNITS HAVE AT LEAST A PRIVATE 10' X 10' AREA.

VESTING TENTATIVE MAP OPEN SPACE EXHIBIT

AMARAL PROPERTIES - TRACT 8266

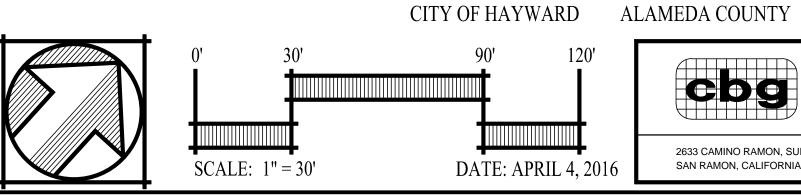

2633 CAMINO RAMON, SUITE 350 SAN RAMON, CALIFORNIA 94583

Carlson, Barbee & Gibson, Inc. (925) 866-0322 www.cbandg.com

CALIFORNIA

SHEET NUMBER

AMARAL PROPERTY

PLANNED DEVELOPMENT SUBMITTAL

HAYWARD, CALIFORNIA

13. ALL STREET TREES TO BE INSTALLED IN ACCORDANCE WITH THE

14. ALL TREES WITHIN 5' OF PAVING AREAS SHALL HAVE DEEP ROOT

15. THE LANDSCAPE CONTRACTOR SHALL AS A PART OF THIS BID

(ONE THOUSAND FIVE HUNDRED DOLLARS), TO BE USED FOR

SUPPLYING AND INSTALLING ADDITIONAL PLANT MATERIAL AS

DIRECTED BY THE LANDSCAPE ARCHITECT AND APPROVED BY THE OWNER IN WRITING. THE UNUSED PORTION OF THE ALLOWANCE

16. CONTRACTOR SHALL EXCAVATE ALL LIME-TREATED SOILS FROM

OF PLANTINGS HALF THE DISTANCE OF THE ON-CENTER SPACING.

18. THE LANDSCAPE CONTRACTOR IS TO PROVIDE AN AGRICULTURAL

RECOMMENDATIONS FOR AMENDMENTS AND DRAINAGE SOLUTIONS

PLANTING OCCURS IF DRAINAGE IS FOUND TO NOT AT A PROPER RATE.

SUITABILITIES ANALYSIS AND PERCOLATION TEST VERIFYING 3" PER

HOUR DRAIN RATE FOR ON-SITE AND IMPORTED TOPSOIL.

CONTAINED IN THIS ANALYSIS, SHALL BE CARRIED OUT BEFORE

SHALL BE RETURNED TO THE OWNER AT THE BEGINNING OF THE

PROVIDE FOR A PLANTING ALLOWANCE FOR THE AMOUNT OF \$1,500.00

STANDARDS AND SPECIFICATIONS OF THE CITY.

MAINTENANCE PERIOD.

ALL PLANTING AREAS.

PROJECT DIRECTORY

CLIENT KB HOMES

5000 EXECUTIVE PARKWAY, SUITE 125 SAN RAMON, CA 94583 PH: (925) 983-4521 CONTACT: JOHN COMPAGLIA

LANDSCAPE ARCHITECT

GATES + ASSOCIATES 271 CROW CANYON ROAD SAN RAMON, CA 94583 PH: (925) 736-8176 CONTACT: LINDA GATES

ARCHITECT

SDG ARCHITECTURE+ ENGINEERING 3361 WALNUT BOULEVARD, SUITE 120 BRENTWOOD, CA 94513 PH: (925) 634-7000 CONTACT: RALPH STRAUSS

CIVIL ENGINEER


CARLSON, BARBEE & GIBSON 2633 CAMINO RAMON, SUITE 350 SAN RAMON, CA 94583 PH: (925) 866-0322 CONTACT: LEE ROSENBLATT

SHEET INDEX

- **COVER SHEET**
- NOTES AND LEGENDS
- TREE REMOVAL AND PRESERVATION PLAN
- CONCEPTUAL LANDSCAPE PLAN
- CONCEPTUAL ENLARGEMENT PLAN
- **DETAILS** L-5
- **DETAILS**
- L-7 **DETAILS**
- CONCEPTUAL IRRIGATION PLAN
- CONCEPTUAL IRRIGATION NOTES AND LEGEND
- CONCEPTUAL IRRIGATION DETAILS

CONCEPTUAL IRRIGATION DETAILS

LOCATION MAP

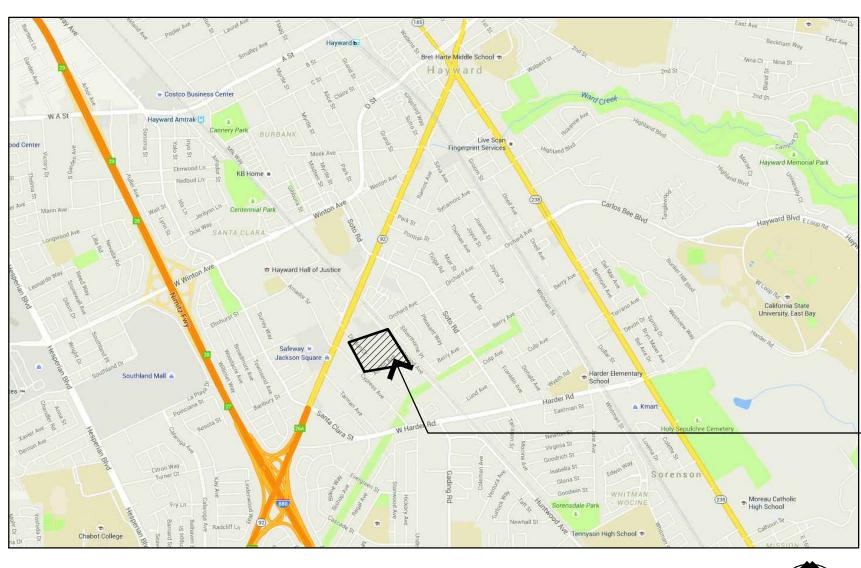

PROJECT SITE



PLANTING NOTES

1. ALL WORK SHALL BE PERFORMED BY PERSONS FAMILIAR WITH PLANTING WORK AND UNDER THE SUPERVISION OF A QUALIFIED PLANTING FOREMAN.

2. PLANT MATERIAL LOCATIONS SHOWN ARE DIAGRAMMATIC AND MAY BARRIERS INSTALLED. DEEP ROOT BARRIER MODEL NO. UB-36.2. (415) BE SUBJECT TO CHANGE IN THE FIELD BY THE LANDSCAPE ARCHITECT. 344.1464.

3. ALL TREES ARE TO BE STAKED AS SHOWN ON THE TREE STAKING/GUYING DETAIL.

4. PLANT COUNT IS FOR THE CONVENIENCE OF THE CONTRACTOR. IN CASE OF DISCREPANCIES, THE PLAN SHALL GOVERN.

5. PLANT LOCATIONS ARE TO BE ADJUSTED IN THE FIELD AS NECESSARY TO SCREEN UTILITIES BUT NOT TO BLOCK WINDOWS NOR IMPEDE

6. THE LANDSCAPE ARCHITECT RESERVES THE RIGHT TO MAKE SUBSTITUTIONS. ADDITIONS, AND DELETIONS IN THE PLANTING SCHEME AS THEY FEEL NECESSARY WHILE WORK IS IN PROGRESS. SUCH 17. ADJACENT TO CURBS OR PAVING. CONTRACTOR TO HOLD CENTER CHANGES ARE TO BE ACCOMPANIED BY EQUITABLE ADJUSTMENTS IN THE CONTRACT PRICE IF /WHEN NECESSARY.

7. BRANCHING HEIGHT OF TREES SHALL BE A 6'-0" MINIMUM ABOVE FINISH GRADE.

8. ALL TREES IN A FORMAL GROUP PLANTING SHALL BE MATCHING IN SIZE AND SHAPE.

9. LANDSCAPE CONTRACTOR SHALL HIRE AN ACCREDITED SOILS ANALYSIS FIRM TO TEST SOIL AND ABIDE BY RECOMMENDATIONS CONTAINED WITHIN FOR PROPER PLANT GROWTH.

10. ON GRADE PLANTING BACKFILL MIX SHALL CONSIST OF 50% IMPORTED TOPSOIL, 50 % NATIVE SOIL (WITH NO ROCKS LARGER THAN

11. ALL ON-GRADE PLANTING AREAS ARE TO RECEIVE IRON AND NITROGEN STABILIZED REDWOOD SOIL CONDITIONER AT THE RATE OF 6 CUBIC YARDS/1000 SQUARE FEET, EVENLY TILLED 6" DEEP INTO THE SOIL TO FINISH GRADE.

12. ALL PLANTING AREAS SHALL BE TOP-DRESSED WITH 3" LAYER OF SALT WATER FREE FIR BARK MULCH HAVING A MAXIMUM SIZE OF 3/4"

GENERAL NOTES

2" DIAMETER).

--UTILITIES ON SITE SHALL BE SCREENED BY EVERGREEN SHRUBS

--FOR BIO-RETENTION AREA CROSS-SECTION, SEE CIVIL DRAWINGS

--SCHEMATIC CONCEPT PLANS WERE BASE ON CITY OF HAYWARD'S WATER CONSERVATION IN LANDSCAPING REGULATIONS GUIDELINES AND CHECKLIST. FOLLOWING CITY'S APPROVAL OF PD SUBMITTAL DOCUEMENTS, THE CONSTRUCTION DOCUMENTS SHALL ALSO FOLLOW CITY OF HAYWARD'S WATER CONSERVATION IN LANDSCAPING REGULATIONS GUIDELINES.

LAYOUT NOTES

- CONTRACTOR SHALL VERIFY ALL GRADES, EXISTING CONDITIONS AND DIMENSIONS IN THE FIELD PRIOR TO COMMENCING WORK ALL DISCREPANCIES OR QUESTIONS SHALL BE BROUGHT TO THE ATTENTION OF THE LANDSCAPE
- ARCHITECT FOR RESOLUTION. ALL WRITTEN DIMENSIONS SUPERSEDE ALL SCALED DISTANCES AND DIMENSIONS. DIMENSIONS SHOWN ARE FROM THE FACE OF THE BUILDING, WALL, BACK OF CURB, EDGE OF WALK, PROPERTY LINE, OR CENTERLINE OF COLUMN UNLESS OTHERWISE NOTED ON THE DRAWINGS.
- ALL ANGLES ARE 45 DEGREE, 90 DEGREE, OR 135 DEGREE UNLESS
- ALL CURVES AND ALL TRANSITIONS BETWEEN CURVES AND STRAIGHT EDGES SHALL BE SMOOTH.
- SEE IRRIGATION SCHEMATIC FOR GENERAL SYSTEM REQUIREMENTS AND FOR LOCATION OF IRRIGATION MAINLINE PIPING. SLEEVES TO ACCOMMODATE IRRIGATION PIPING, SIZED AS NEEDED, SHALL BE PLACED UNDER AND THROUGH SLABS
- AND WALLS, PRIOR TO POURING WIDTH OF THE WALKWAY, UNLESS OTHERWISE SHOWN. EXPANSION JOINTS IN SIDEWALKS SHALL BE 30' ON CENTER MAXIMUM AND AS SHOWN ON THE PLANS. EXPANSION JOINTS SHALL BE PLACED AT THE INTERFACE OF WALLS AND BUILDINGS AND AT THE CHANGE OF DIRECTION OF TRAVEL.
- BUILDING LAYOUT AND LOCATION, SIDEWALK, CURB AND GUTTER, GRADING AND DRAINAGE IS BASED ON DRAWINGS PREPARED BY THE ARCHITECT AND THE CIVIL ENGINEER.
- SEE ELECTRICAL ENGINEER'S PLANS AND LIGHTING PLAN FOR ADDITIONAL INFORMATION.
- 9. 6" CONCRETE MOW BAND SHALL BE INSTALLED IN BETWEEN THE SEAT WALL AND THE LAWN AREA, AS WELL AS ALONG THE EDGE OF THE RUBBER SURFACING PLAY AREA.
- HANDRAILS ARE ONLY REQUIRED AT EACH RESIDENCE WHEN THE NUMBER OF RISERS IS 3 OR MORE.

WATER EFFICIENT LANDSCAPE STATEMENT

THE IRRIGATION SYSTEM SHALL BE DESIGNED TO MEET CURRENT WATER EFFICIENCY STANDARDS AND STATE MODEL WATER EFFICIENT LANDSCAPE ORDINANCE AB1881 AS REQUIRED BY LOCAL JURISDICTIONS WHILE ACHIEVING THE GOAL OF EFFECTIVELY AND EFFICIENTLY PROVIDING THE LANDSCAPE WITH WATER BY MEANS OF HIGH EFFICIENCY SPRAY IRRIGATION TO THE TURF AND GROUND COVER AREAS AND DRIP IRRIGATION BUBBLERS TO RESTRICTED SHRUB PLANTING AND SHRUB MASS PLANTING AREAS AS APPLICABLE.

IRRIGATION SYSTEMS SHALL BE DESIGNED TO ACCOMMODATE RECYCLED WATER WHERE AVAILABLE EITHER CURRENTLY OR IN THE FUTURE AS DIRECTED BY THE LOCAL WATER PURVEYOR. RECYCLED WATER SYSTEMS SHALL BE DESIGNED IN ACCORDANCE WITH LOCAL AND STATE CODES.

IRRIGATION SYSTEMS FOR LANDSCAPES GREATER THAT 5,000 SF SHALL HAVE A DEDICATED WATER METER FOR


A WATER EFFICIENT LANDSCAPE WORKSHEET SHALL BE INCLUDED WITH HYDROZONE INFORMATION TABLE, WATER BUDGET CALCULATIONS AND IRRIGATION OPERATION SCHEDULES.

A STATE OF THE ART ET BASED SELF ADJUSTING IRRIGATION CONTROLLER SHALL BE SPECIFIED FOR THIS PROJECT TO AUTOMATICALLY CONTROL THE WATER ALLOCATED TO EACH VALVE GROUPED PER INDIVIDUAL HYDROZONE (BASED ON PLANT TYPE AND EXPOSURE). THIS SHALL INCLUDE RAIN AND FLOW SENSORS AS APPLICABLE FOR A HIGHER LEVEL OF WATER CONSERVATION.

TREE BUBBLERS SHALL BE INCLUDED ON SEPARATE CIRCUITS TO ISOLATE THE IRRIGATION TO THE TREES AND PROVIDE DEEP WATERING TO PROMOTE A DEEPER ROOT STRUCTURE.

SPRAY IRRIGATION SYSTEMS FOR GROUNDCOVER AREAS GREATER THAN 8' WIDE IN ANY DIRECTION SHALL BE DESIGNED WITH COMMERCIAL SERIES SPRAY HEADS WITH HIGH EFFICIENCY NOZZLES THAT INCLUDE INTERNAL CHECK VALVES AND PRESSURE COMPENSATION DEVICES. THE HEADS SHALL BE DESIGNED IN A HEAD TO HEAD LAYOUT TO ACHIEVE AN EVEN LEVEL OF PRECIPITATION THROUGHOUT THE IRRIGATION SYSTEM. THE NOZZLES DELIVER WATER AT MINIMUM 70% EFFICIENCY WITH A LOW PRECIPITATION RATE THAT MATCHES THE INFILTRATION

THE DRIP SYSTEM WILL INCORPORATE PRESSURE COMPENSATING DRIP BUBBLERS WITH 1/4" DRIP TUBES TO EACH PLANT WHICH DELIVERS WATER AT 90% EFFICIENCY AT AN APPLICATION RATE THAT MATCHES THE SOIL TYPE.

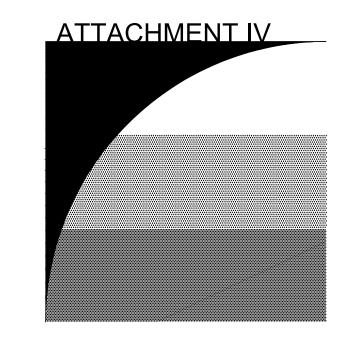


+ASSOCIATES LANDSCAPE ARCHITECTURE

2671 CROW CANYON RD. SAN RAMON. CA 94583 T 925.736.8176 www.dgates.com


LAND PLANNING • URBAN DESIGN

HAYWARD, CA

ISSUE: DESCRIPTION: DATE: 05/27/2015 ISSUE 1 SITE REVIEW ISSUE 2 SITE REVIEW 08/06/2015 ISSUE 3 SITE REVIEW 03/07/2016

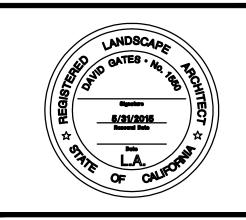

PROJECT NUMBER: DRAWN: MNO CHECK: DATE: 05/27/2014

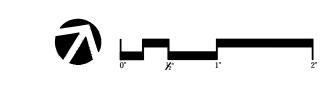

COVER SHEET

Page 7 of 46

IAVOLITIECEND

	PEDESTRIAN CONCRETE PAVING FINISH: MEDIUM BROOM COLOR: STANDARD GREY ALL PEDESTRIAN CONCRETE PAVING AT PATIO SHALL BE STANDARD		SCORELINE
	GREY COLOR WITH SALT FINISH.	<u>EJ</u>	EXPANSION JOINT
* * * * * * * * * * * * * * * * * * *	INTEGRAL COLOR CONCRETE PAVING FINISH: SALT COLOR: TBD	 	POINT OF BEGINNING
<u> </u>	COLOR. 1DD	TYP.	TYPICAL
, , , , , , , , , , , , , , , , , , , ,	STAMPED ASPHALT PAVING MFR: STREETPRINT BY IPC (Integrated Paving Concept) (888) 581-2899	EQ.	EQUAL
24 24 25 26 26 27 27 27 27 27 27 27 27 27 27 27 27 27	PATTERN: TBD COLOR: TBD	S.C.D.	SEE CIVIL'S DRAWINGS
	COLOR. 1DD	S.A.D.	SEE ARCHITECT'S DRAWINGS
	PERVIOUS CONCRETE PAVERS MFR: BASALITE	S.E.D.	SEE ELECTRICAL'S DRAWINGS
	MODEL: TBD COLOR: TBD	SIM	SIMILAR
· (************************************	DECOMPOSED GRANITE PAVING WITH BINDER	R	RADIUS - ALL RADII GIVEN FOR WALLS ARE DIMENSIONED TO OUTSIDE OF WALLS.
	COLOR: CALIFORNIA GOLD	\swarrow^{Δ}	ALIGN
		£ ——	CENTER LINE
*	LOOP BIKE RACK MFR: DUMOR	SP.	SPACING
	MODEL: 83 COLOR: BLACK	F.O.C.	FACE OF CURB
	CONTACT: WWW.DUMOR.COM INSTALL PER MFG SPECS	* * * * * * * * * * * * * * * * * * *	BIO-RETENTION IN PLANTING AREAS, S.C.D
MMM	MAILBOX CLUSTER MFR: CUSTOM HOME ACCESSORIES PH: (916) 987-7787 MODEL: REGENCY KIT CLUSTER BOX UNITS STYLE: SALSBURY 3300 SERIES (WITHOUT PEDESTAL COVER) COLOR: BLACK INSTALL PER MFG SPECS ACQUIRE APPROVAL FROM POST OFFICE PRIOR TO ORDERING.	PA	PLANTING AREA
	TABLE MFR: LANDSCAPE FORMS PH: (800) 521-2546 MODEL: CHARLIE - ADA COMPLIANT 67" TABLE WITHOUT UMBRELLA HO COLOR: BLACK INSTALL PER MFG SPECS	DLE	
	6' ORNAMENTAL IRON FENCE AND GATES		
	6' LATTICE TOP FENCE		

PLANT LIST

TREE					0.6	WATER DEC	CA NIATINE/
QUANTITY	SYMBOL	BOTANICAL NAME	COMMON NAME	SIZE	O.C. Spacing	WATER REQ.	CA NATIVE/ REF. MED.
	AM	Arbutus 'Marina'	NCN	15 Gal.	As Shown	OCC-INF	EBMUD Mediterranean
	AR	Acer rubrum 'Red Sunset'	Red Maple	15 Gal.	As Shown	MOD	WUCOLS
	CR	Ceanothus 'Ray Hartman' (Std.)	Ceanothus	15 Gal.	As Shown	LOW	WUCOLS CA Native
	ED	Elaocarpus dicipens	Japanese Blueberry	15 Gal.	As Shown	MOD	WUCOLS
	LM	Lagerstroemia indica 'Muskogee' (Std.)	Crape Myrtle	15 Gal.	As Shown	LOW	WUCOLS
	LN	Lagerstroemia indica 'Natchez' (Std.)	Crape Myrtle	15 Gal.	As Shown	LOW	WUCOLS
	PC	Pistachia chinensis	Chinese Pistache	15 Gal.	As Shown	LOW	WUCOLS
	TC ZE	Tilia cordata Zelkova s. 'Musaschino'	Little Leaf Linden Sawleaf Zelkova	15 Gal. 15 Gal.	As Shown As Shown	MOD MOD	WUCOLS WUCOLS
CLIDI ID / DEDEA		Zomova di Madadomio	Sufficial Bollova	10 0411	710 0110 1111	WOD.	
SHRUB/ PEREN		DOMINION NAME		OVER TO SERVICE OF THE PROPERTY OF THE PROPERT	O.C.	WATER REQ.	
QUANTITY	SYMBOL	BOTANICAL NAME Achillea tomentosa 'King George'	COMMON NAME Woolly Yarrow	SIZE 1 Gal.	SPACING 1'-6"	OCC-INF	REF. MED. EBMUD Me di terranean
	* AT	Achinea tomentosa King George Agapanthus 'Rancho White'	Lily-of-the-Nile		1 -6 1'-6"	OCC-INF	
	* AW * BU	Buxus sempervirens 'Green Mountain'	Boxwood	1 Gal.	1 -0 3'-0"	INF-NONE	EBMUD Mediterranean EBMUD CA Native
	*			1 Gal.			
	* CO	Coleonema 'Sunset Gold'	Pink Breath of Heaven	1 Gal.	2'-6"	MOD	WUCOLS EBMUD Mediterranean
	CP	Coprosma hybrids 'Tequila Sunrise'	Mirror Plant	1 Gal.	4'-0"	OCC-INF	
	* CS	Cistus x. argentius 'Silver Pink'	Rockrose	1 Gal.	4'-0"	OCC-INF	EBMUD Mediterranean
	* CU	Cuphea hyssopifolia 'Caribbean Sunset'	False Heather	1 Gal.	2'-0"	OCC-INF	EBMUD Mediterranean
	* DG	Dietes grandiflora 'Variegata'	Variegated Fortnight Lily	1 Gal.	3'-0"	LOW	WUCOLS
	* EG	Euonymus fortunei 'Golden Prince'	NCN	1 Gal.	3'-6"	LOW	WUCOLS
	, HA	Hebe x andersonii	Hebe	1 Gal.	5'-0"	MOD	WUCOLS
	* HO	Hebe odora	Boxleaf Hebe	1 Gal.	5'-0"	MOD	WUCOLS
	HR	Hemerocallis 'Terra Cotta Baby'	Evergreen Daylily	1 Gal.	2'-0"	LOW	WUCOLS
	HY	Hemerocallis hybrids 'Yellow'	Evergreen Daylily	1 Gal.	2'-6"	MOD	WUCOLS
	HS	Helictotrichon sempervirens	Blue Oat Grass	1 Gal.	2'-6"	MOD-OCC	EBMUD CA Native
	* LI	Liriope gigantea	Giant Lily Turf	1 Gal.	2'-6"	LOW	WUCOLS
	LA	Lavatera assurgentifolia	Tree Mallow	5 Gal.	6'-0"	LOW	WUCOLS Mediterranean
	LT	Lavatera thuringiaca 'Red Rum'	Tree Mallow	1 Gal.	4'-0"	LOW	WUCOLS Mediterranean
	* MC	Myrtus communis	Myrtle	1 Gal.	2'-0"	LOW	WUCOLS CA Native
	* MC	Myrtus communis 'Compacta'	Dwarf Myrtle	1 Gal.	4'-0"	LOW	WUCOLS CA Native
	ND	Nandina domestica 'Plum Passion'	Heavenly Bamboo	1 Gal.	4'-0"	LOW	WUCOLS
	. PJ	Phormium 'Jester'	New Zealand Flax	1 Gal.	1'-6"	LOW	WUCOLS
	* PY	Phormium 'Yellow Wave'	New Zealand Flax	1 Gal.	4'-0"	LOW	WUCOLS
	SL	Salvia leucantha 'Santa Barbara'	Mexican Bush Sage	1 Gal.	4'-0"	OCC	EDMID
	SV	Salvia leucophylla Figueroa'	Purple Sage	5 Gal.	6'-0"	OCC	
	TF	Teucrium fruticans 'Compactum'	Bush Germander	1 Gal.	2'-6"	OCC	EBMUD Mediterranean
GROUNDCOV	VERS				O.C.	WATER REQ.	CA NATIVE/
QUANTITY	SYMBOL *	BOTANICAL NAME	COMMON NAME	SIZE	SPACING		REF. MED.
	* EK	Erigeron karvinskainus Festuca californica	Santa Barbara Daisy California Fescue	1 Gal. 1 Gal.	3'-0" 1'-6"	OCC-INF Low	EBMUD CA Native WUCOLS CA Native
	* FC						
	$_*$ GZ	Gazania	Gazania "	1 Gal.	12"	OCC	EBMUD
	HM	Heuchera micrantha 'Painted Lady	Coral Bells	1 Gal. 1 Gal.	2'-0"	MOD-OCC	EBMUD CA Native WUCOLS
	RR	Rosa 'Carpet Rose Red'	Red Carpet Rose		3'-0"	LOW	
	RW	Rosa 'Carpet Rose White'	White Carpet Rose	1 Gal.	3'-0"	LOW	WOCOLD
	RY	Rosa 'Carpet Rose Yellow'	Yellow Carpet Rose	1 Gal.	3'-0"	LOW	WUCOLS
	TL	Teucrium lucidrys 'Prostratum'	Germander	1 Gal.	3'-6"	OCC-INF	EBMUD Mediterranean
GRASS						WATER DEA	CA KIA'PRIP
QUANTITY	SYMBOL	BOTANICAL NAME	COMMON NAME	SIZE	O.C. Spacing	WATER REQ.	CA NATIVE/ REF. MED.
	CH	Chondropetalum tectorum	Cape Rush	1 Gal.	3'-6"	MOD	EBMUD
	CT	Carex tumulicola	Berkeley Sedge	1 Gal.	2'-0"	OCC	EBMUD CA Native
	JР	Juncus patens	California Gray Rush	1 Gal. 1 Gal.	2'-0"	OCC	EBMUD CA Native
			Mexican Feather Grass	1 Gal.	2'-6"	MOD-OCC	EBMUD
	ST	Stipa tenuissima	MCAICAIL I CALLICI GIASS				
VINES		Stipa tenuissima	Mexical Feather Grass				
	ST			CIZE	O.C.	WATER REQ.	CA NATIVE/
	ST SYMBOL	BOTANICAL NAME	COMMON NAME	SIZE	SPACING	•	REF. MED.
	SYMBOL GS	BOTANICAL NAME Gelsemium sempervirens	COMMON NAME Carolina Jessamine	5 Gal.	SPACING as shown	MOD	REF. MED. WUCOLS
	SYMBOL GS * ML	BOTANICAL NAME Gelsemium sempervirens Mandevilla laxa	COMMON NAME Carolina Jessamine Chilean Jasmine	5 Gal. 5 Gal.	as shown as shown	MOD MOD	REF. MED. WUCOLS WUCOLS
<u>vines</u> Quantity	SYMBOL GS	BOTANICAL NAME Gelsemium sempervirens	COMMON NAME Carolina Jessamine	5 Gal.	SPACING as shown	MOD	REF. MED. WUCOLS

NOTE: "*" ARE PLANTS APPROPRIATE FOR SHADE LOCATIONS.

SOD:	
* * * * * * * * * * * * * * * * * * *	BIOFILTRATION SOD AVAILABLE FROM DELTA BLUE GRASS (800) 637-8873 OR APPROVED EQUAL

WATER USE RATING LEGEND

EBMUD CATEGORIES OF WATER NEEDS FROM: PLANTS & LANDSCAPES FOR SUMMER DRY CLIMATES OF THE SAN FRANCISCO BAY REGION BY THE EAST BAY MUNICIPAL UTILITY DISTRICT, 2004		WUCOLS III CATEGORIES OF WATER NEEDS FROM: UNIVERSITY OF CALIFORNIA COOPRATIVE EXTENSION, CALIFORNIA DEPARTMENT OF WATER RESOURCES, UNITED STATES BUREAU OF RECLAMATION
MOD	MODERATE WATER	HIGH
OCC	OCCASIONAL WATER	MODERATE
INF	INFREQUENT WATER	LOW
NONE	NO ADDITIONAL WATER	VERY LOW

ON-SITE	TOTAL PLANTS	SUBTOTAL PLANTS WITH OCC/INF/NONE /LOW/VERY LOW WATER REQUIREMENTS			
	X	x			
PERCENTAGE OF PLANTS MEETING LOW WATER REQUIREMENTS: 94.7% MORE THAN 75% REQUIRED.					


PLANTING LEGEND


/	XX	TREE NAME QUANTITY
ean tive	$\begin{pmatrix} XX \\ XX \end{pmatrix}$	SHRUB NAME QUANTITY
	XX	GROUNDCOVER QUANTITY
/	XX	VINE QUANTITY

TREE LEGEND

CALIFORNIA NATIVE PLANTS (CNP)
FOR THE GARDEN, 2005 BY
CAROL BORNSTEIN, DAVID FROSS,,
BART O'BRIEN

MOD MODERATE WATER OCC OCCASIONAL WATER INF INFREQUENT WATER

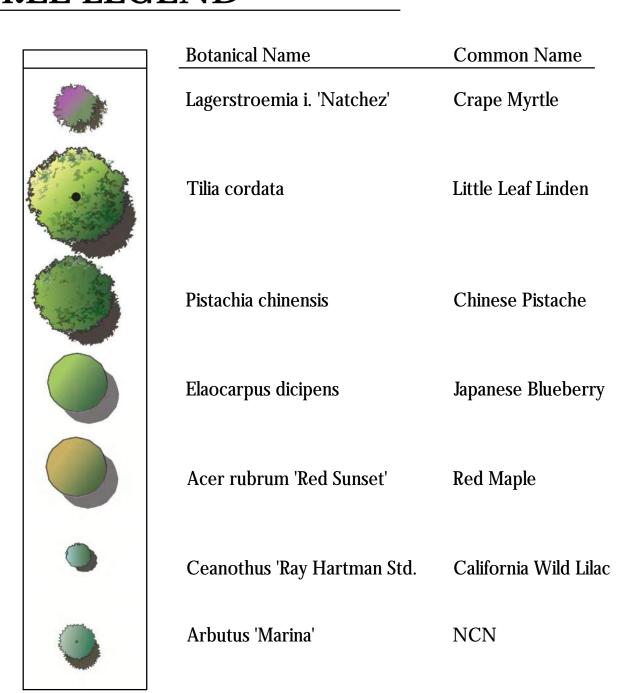

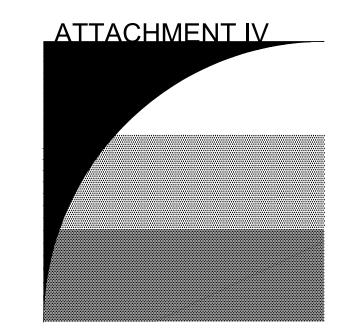

GATES +ASSOCIATES LANDSCAPE ARCHITECTURE LAND PLANNING • URBAN DESIGN

2671 CROW CANYON RD. SAN RAMON, CA 94583 T 925.736.8176 www.dgates.com


> **AMARAL PROPERTY**

> > HAYWARD, CA


ISSUE: DESCRIPTION: DATE: ISSUE 1 SITE REVIEW 05/27/2015 ISSUE 2 SITE REVIEW 08/06/2015

03/07/2016

ISSUE 3 SITE REVIEW

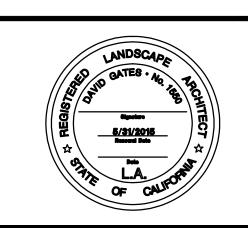

PROJECT NUMBER: DRAWN: MNO CHECK: DATE: 05/27/2014

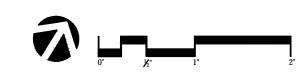

LAYOUT AND PLANTING LEGEND

Page 8 of 46

EXISTING STREET TREE ASSESSMENT CHART

STREET TREE MITIGATION SUMMARY CHART:

TREES TO BE REMOVED


TREES TO BE PRESERVED IN PLACE

TREES TO BE RELOCATED

		Condition 1=Poor	Cuitabilitu fa							
Tree No. Species	Trunk Diameter (in)	Protected	5=Excellent	Suitability for Preservation		North	South	East	West	t Height
163 Fig	12,11,10,9,8,8	yes	4	Moderate	Multiple attachments at 4'; topped; trunk wounds	8	10			9
164 Fig	15,13,10,10	yes	4	Moderate	Multiple attachments at 4'; topped; trunk wounds	15	15	12		17
165 Plum	6	no	3	Moderate	Upright form; Low branch E	10	10	12		5
166 Mulberry	18	yes	3	Moderate	Multiple attachments at 6'; topped; crown formed by epicormics	10	15	17		15
167 Australian Brush Cherry	8	yes	3	Moderate	Large Hedge	5	5	5		5
168 Grecian Bay	6,5,4,3,2	yes	4	Moderate	5tump sprouts; many small stems	15	15	15		15
169 Callery Pear	7,5,5	yes	3	Low	Multiple attachments at 6'; moderate dieback	10	15	10		8
170 Persimon	6,6,5	yes	4	High	Multiple attachments at 4'; good form and structure	10	15	15		12
171 Plum	16	yes	3	Moderate	Multiple attachements at 6'; growing against garage; topped	15	5	10		12
172 Orange	14,12,11,4	yes	5	High	Multiple attachments at 3'; good form and structure	15	15	15		15
173 Box Elder	13,12	yes	2	Low	Codominant trunks at base; dead top	12	15	10		18
174 Coast Live Oak	7	yes	5	High	Good young tree	12	10	10		12
175 Apple	8,7,7	yes	2	Low	Multiple attachements at 3'; dead top; epicormics	18	10	15		10
176 Coast Live Oak	6,4	yes	5	High	Good young tree	10	10	10		12
177 Blue Oak	12,9,6,4	yes	4	Moderate	Multiple attachments at 4'; one sided E; dieback	18	18	20		8
178 Japanese Maple	8,7,5,4	yes	4	Moderate	Multiple attachments at 4'; growing in atrium; leans N; high crown	15	10	15		15
179 Coast Redwood	22	yes	4	High	Good form and structure; canopy a little thin.	10	10	10		10
180 Sweetgum	12	yes	3	Low	Lost top; poor form and structure	10	10	10		12
181 Deodar Cedar	15	yes	3	Moderate	Multiple attachements at 7'; poor structure	12	8	125		15
182 Coast Redwood	27	yes	4	High	Good form and structure; canopy a little thin.	10	10	10		10
183 Coast Redwood	31	yes	4	Moderate	Codominant trunks at base; upright form	10	10	10		10
184 Coast Redwood	24	yes	4	Moderate	Crowded; narrow form	10	10	5		5
185 Coast Redwood	27	yes	4	Moderate	Crowded; narrow form	10	10	5		5
186 Coast Redwood	28	yes	4	Moderate	Crowded; narrow form	10	10	5		5
187 Coast Redwood	31	yes	4	High	Good form and structure; one sided 5	5	13	10		10
188 Buckeye	15,12,10,10,10,9,9,8,7	yes	4	Moderate	Mutiple attachements at base; spreading form; 16" stem losing bark	25	20	20		15
189 Valley Oak	9	yes	5	High	Good young tree	13	13	12		12
190 White Fir	8	yes	4	Moderate	5weeps E. from base; low branching	5	5			10
191 Coast Redwood	26	yes	4	Moderate	Good form and structure; thin upper canopy	12	10	12		10
192 Australian Brush Cherry	10,9	yes	3	Moderate	Codominant trunks at base; dieback in upper canopy	10	10	10		. 5.
193 Coast Redwood	19	yes	3	Moderate	Very thin canopy; engulfed in ivy	10	10	10		10
194 Ginkgo	9	yes	4	High	5light lean SE; low branching	13	10	15		10
195 Blue Gum	57	yes	4	High	Multiple attachments at 5'; good form and structure; trumpet vine in canopy	15	15	15		15
196 Privet	5,5	yes	3	Moderate	Off-site, no tag; codominant trunks at base; extends 10' N over fence	8	8	8		8
			and the second of the second	and the second second		17 S S		the second second		the state of the s

	QUANTITY	APPRAISED VALUE	MITIGATION MEASURE
POOR CONDITION/ LOW SUITABILITY TREES/TREE TO BE REMOVED	3	NOT APPRAISED BY ARBORIST	MITIGATION PER CITY
HERITAGE TREES TO BE REMOVED	30	\$133,350 (Total APPRAISED VALUE)	MITIGATION PER CITY
RELOCATED TREES	1	N/A	N/A
TREES TO BE PRESERVED IN PLACE	1	\$8,800	N/A
TOTAL MITIGATION TREES	35		

NOTE: REFER TO ARBORIST TREE ASSESSMENT AND APPRAISAL REPORT DATED MAY 2015 PREPARED BY HORT SCIENCE FOR DETAILED INFORMATION ON TREE ASSESSMENT CHART, TREE APPRAISAL AND TREE PROTECTION PLAN.

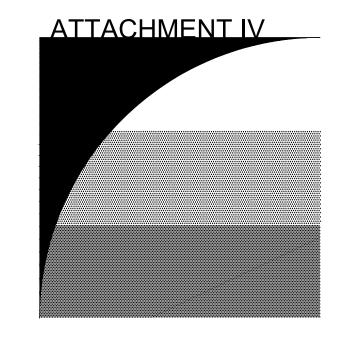


CATES
+ASSOCIATES
LANDSCAPE ARCHITECTURE
LAND PLANNING · URBAN DESIGN

2671 CROW CANYON RD. SAN RAMON, CA 94583
T 925.736.8176 www.dgates.com


AMARAL PROPERTY

HAYWARD, CA

ISSUE: DESCRIPTION: DATE:
ISSUE 1 SITE REVIEW 05/27/2015
ISSUE 2 SITE REVIEW 08/06/2015
ISSUE 3 SITE REVIEW 03/07/2016

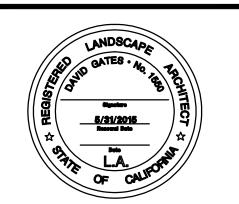

PROJECT NUMBER: P4894
DRAWN: MNC
CHECK: DC
DATE: 05/27/2014

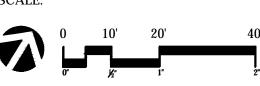

TREE REMOVAL PLAN


L-2

- of -Page 9 of 46

	193 Coast Redwood 19 194 Ginkgo 9 195 Blue Gum 57 196 Privet 5,5 197 Chinese Pistache 7	yes 3 Moderate Very thin canopy; enguired yes 4 High 5light lean SE; low branchin yes 4 High Multiple attachments at 5'; yes 3 Moderate Off-site, no tag; codominan no 4 Moderate Off-site, no tag; multiple attachments	good form and structure; trumpet vine in canopy 15 trunks at base; extends 10' N over fence 8	10 15 10 40 10 15 10 40 15 15 15 55 8 8 8 8 15 8 8 8 10				
\$0. The same of th	188 3	187 185 184 1	× 60,3	× ^{SO} _{P,S}	× 60,6 ×	169 3 m		PH
* \$8,5 (T) \ \ \ \ \ \ \ \ \ \ \ \ \ \ \ \ \ \	94 . 3	* so so control of the sound of	50			The second secon	x x x x x x x x x x x x x x x x x x x	* × 55.
	178	180 182 181		× GO, g	60,9 x	170	*	><
× Ses COM	192	179 177	176 × 59,5	× SQ.	SO,S X	171	166 × 65,5	× ~ ~ ~ ~ ~ ~ ~ ~ ~ ~ ~ ~ ~ ~ ~ ~ ~ ~ ~
195 A						172	167	ISSUE: D
	(L. 191)	* s _o , { 175	× 539,0	* 60,5	× 61,6 ×	* 164 X	163 \\ \tag{\chi_g}	ISSUE 1 SI ISSUE 2 SI ISSUE 3 SI
So _g ×	190	* *				165		*
5.3 E M 196	× Se ₂	× 59,5	80 C 200	× 60,5	× GI,S	* ES.,	A X X X X X X X X X X X X X X X X X X X	× G _F
W Jumphan x 28"								PROJECT N DRAWN: CHECK: DATE:
	× Se _J	× 59,3	× So,>	× 50 ₁₂	× Cpp	× 62,3	ESO X X X ESSO	SCALE:
				60			>< ><	TREE
m 197	* 5>,5	× 5g ₁	× ^{روک} ×	× 60,1	× 60,6	× GR,>	173 × 53.	× G _g
							Tymus d	*

Driplines (ft)



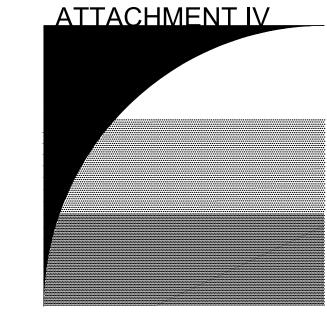

GATES +ASSOCIATES LANDSCAPE ARCHITECTURE


LAND PLANNING • URBAN DESIGN
2671 CROW CANYON RD. SAN RAMON, CA 94583

T 925.736.8|76 www.dgates.com

AMARAL PROPERTY

HAYWARD, CA

ISSUE: DESCRIPTION: DAT
ISSUE 1 SITE REVIEW 05/27/202
ISSUE 2 SITE REVIEW 08/06/202
ISSUE 3 SITE REVIEW 03/07/202

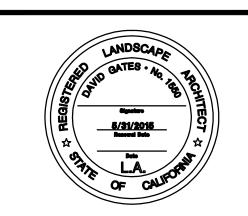


PROJECT NUMBER: P4894

DRAWN: MNO

CHECK: DG


DATE: 05/27/2014

SCALE: 1"= 20'-0"

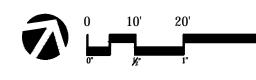


LANDSCAPE CONCEPT

L-3

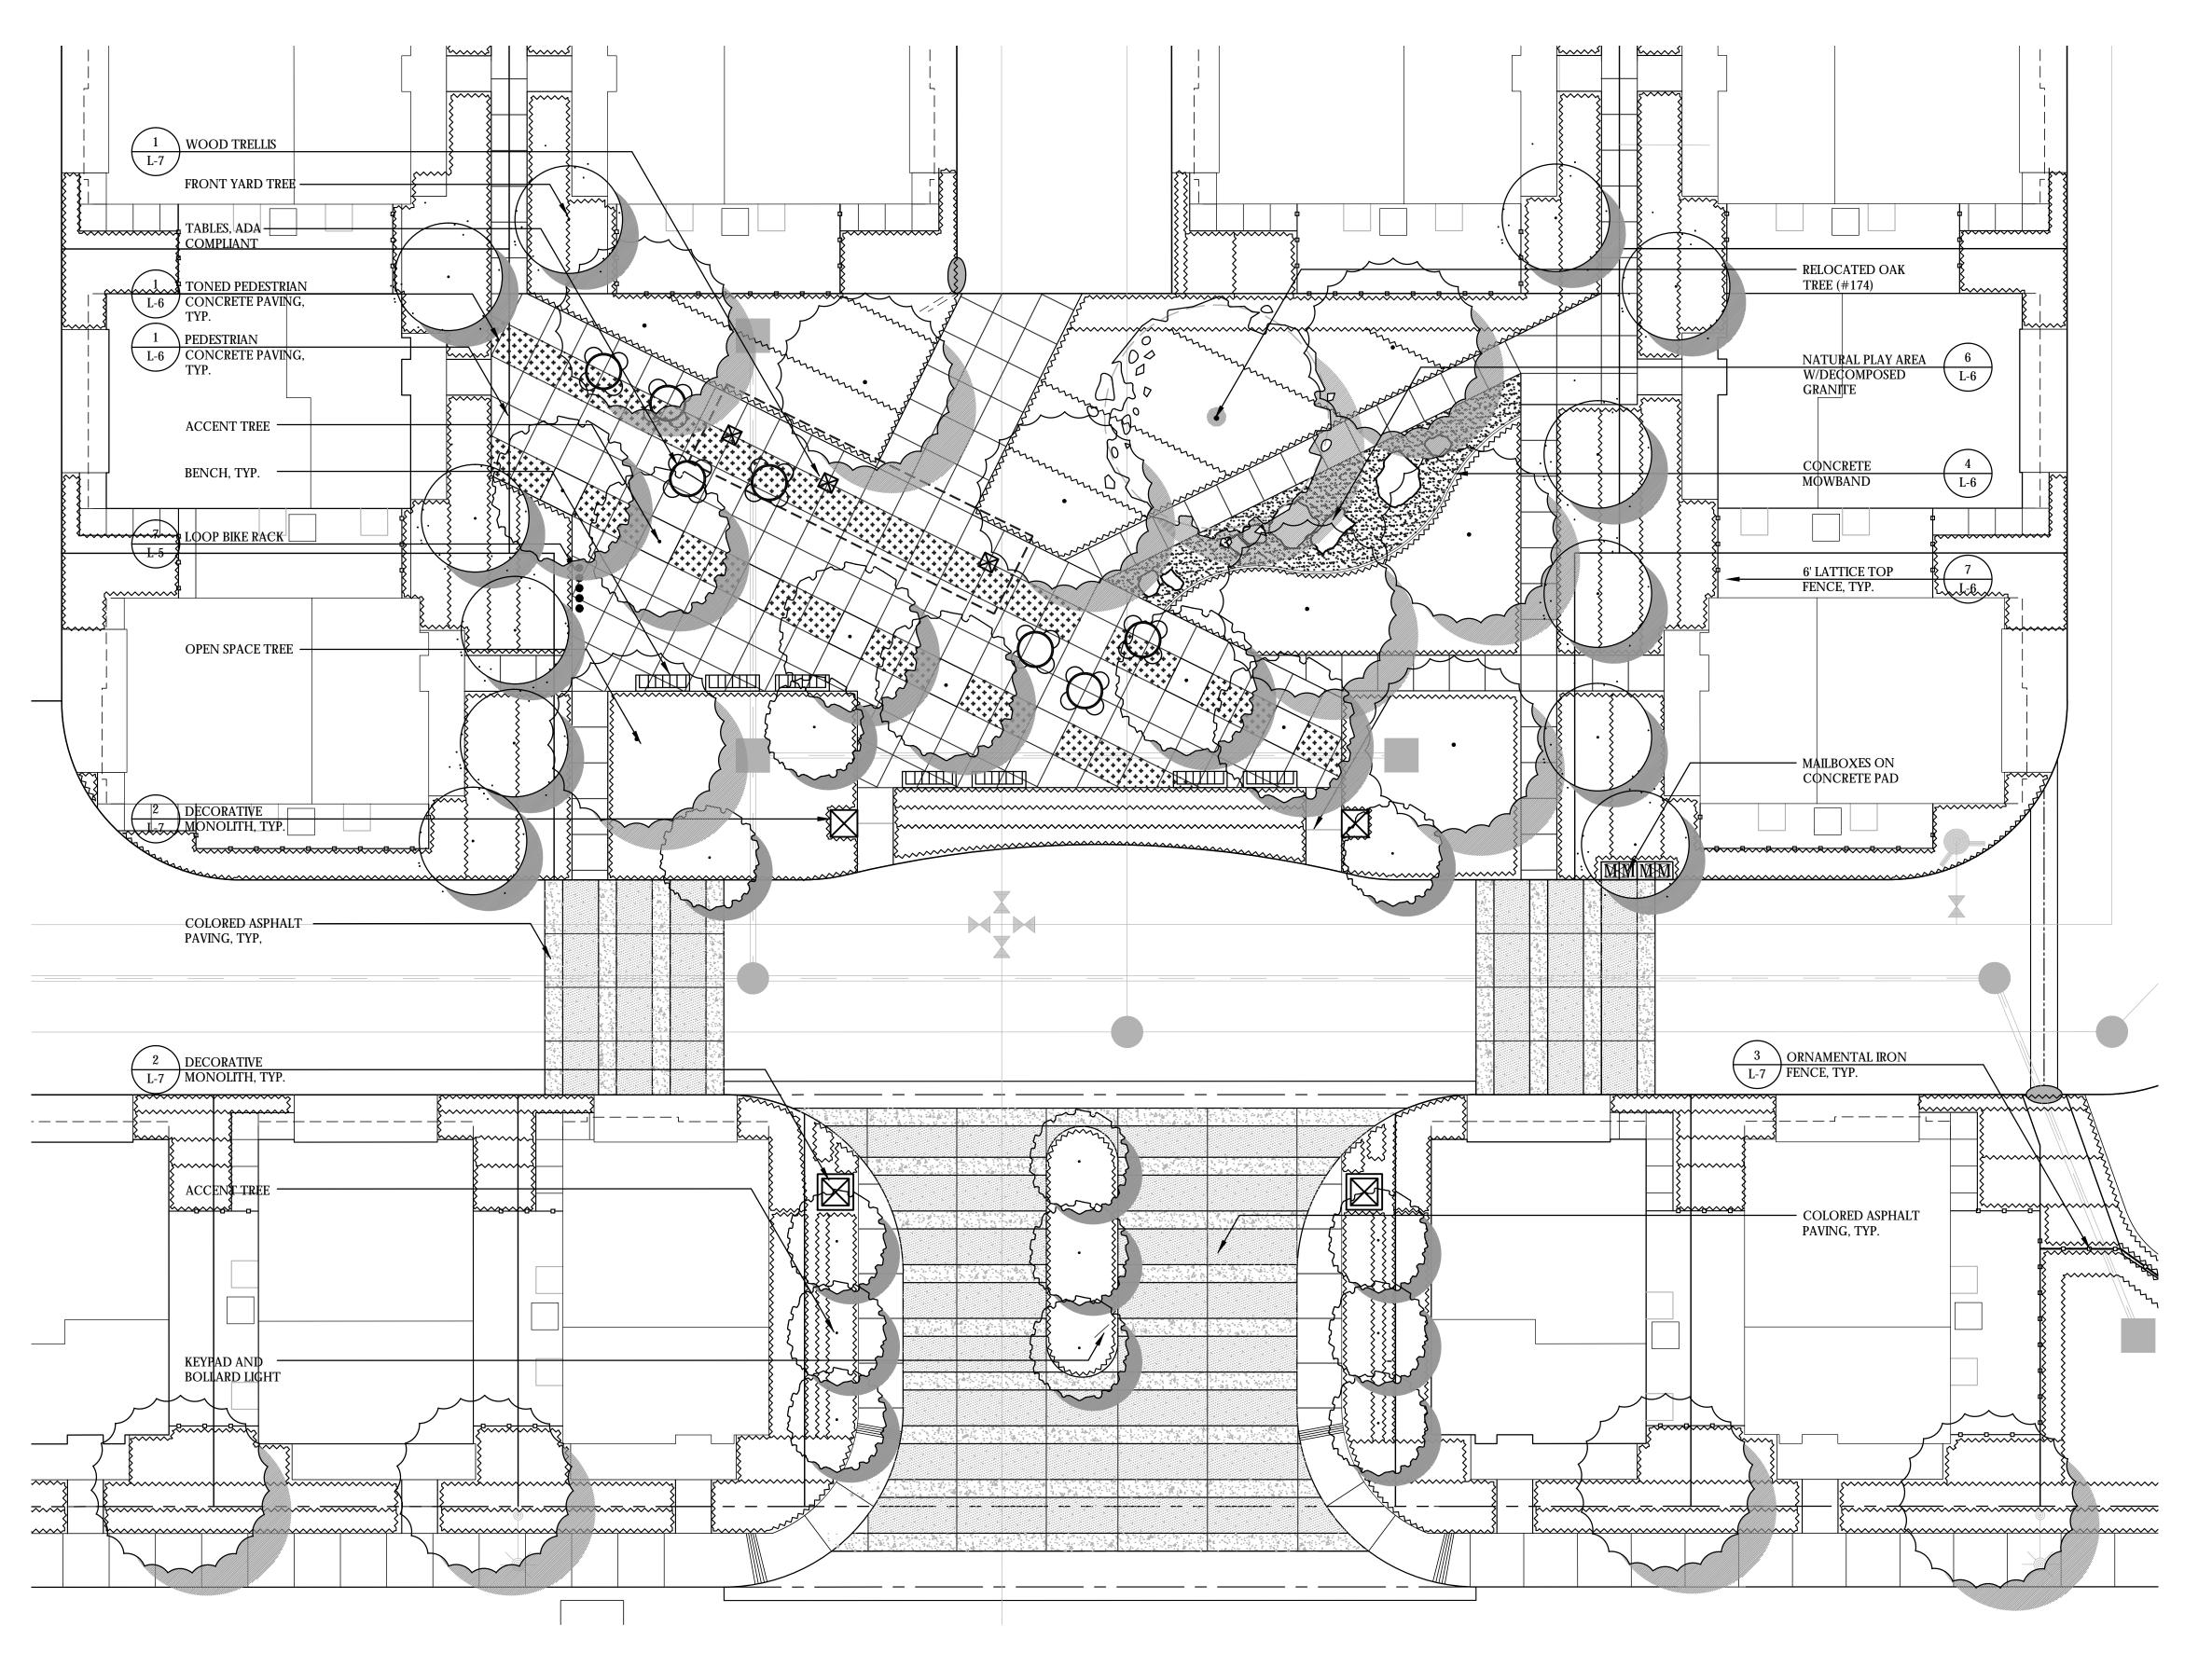

ENTRY AND CENTRAL OPEN SPACE ENLARGEMENT

SCALE: 1"= 10'

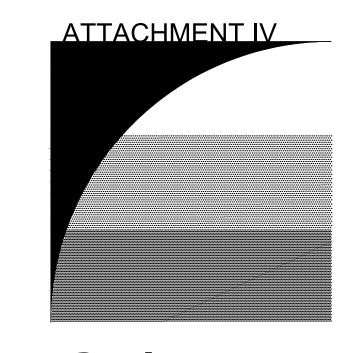


GATES +ASSOCIATES


LANDSCAPE ARCHITECTURE
LAND PLANNING • URBAN DESIGN

2671 CROW CANYON RD. SAN RAMON, CA 94583
T 925.736.8176 www.dgates.com


AMARAL PROPERTY

HAYWARD, CA

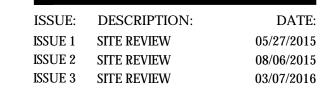

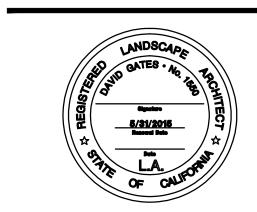


PROJECT NUMBER: P4894
DRAWN: MNO
CHECK: DG
DATE: 05/27/2014

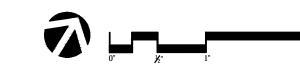



CONCEPTUAL ENLARGEMENT PLAN


L-4

Page 11 of 46

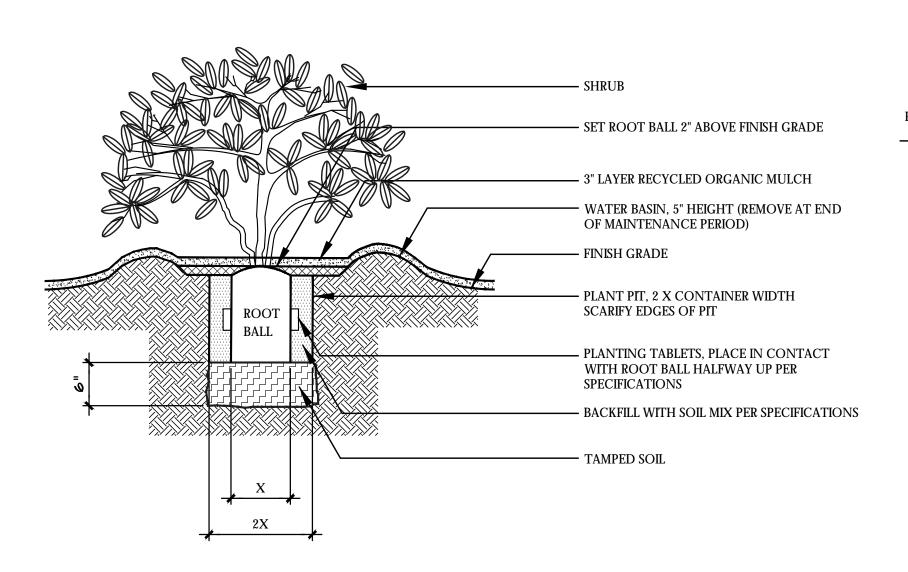


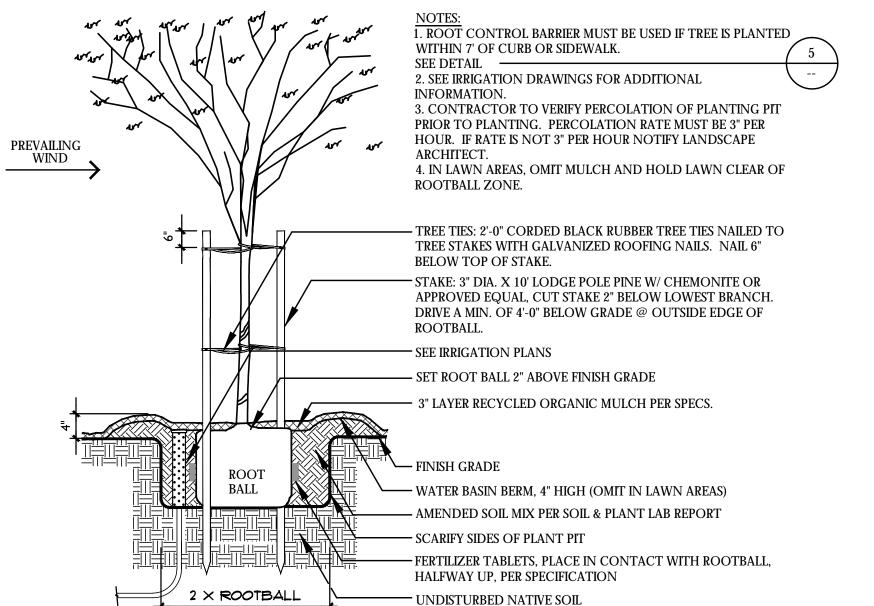

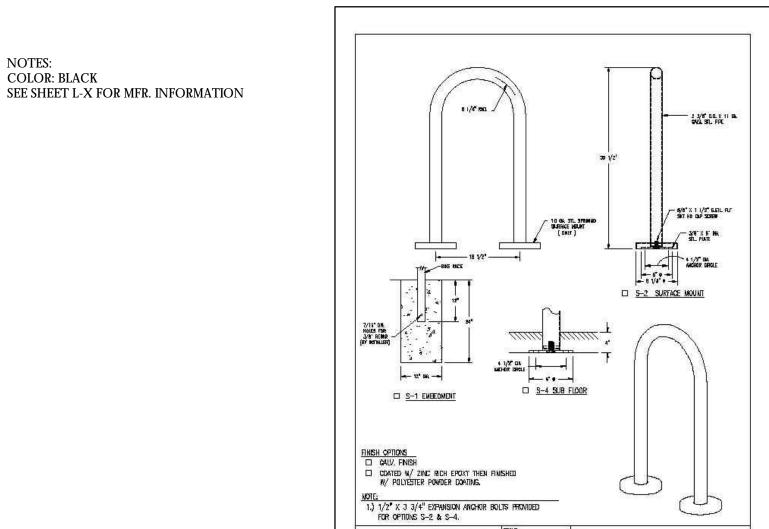

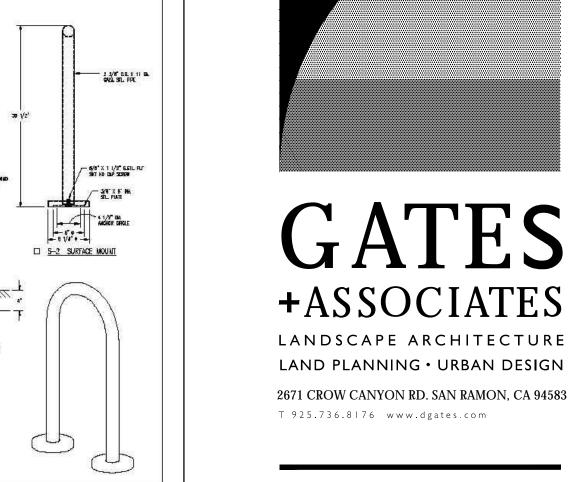



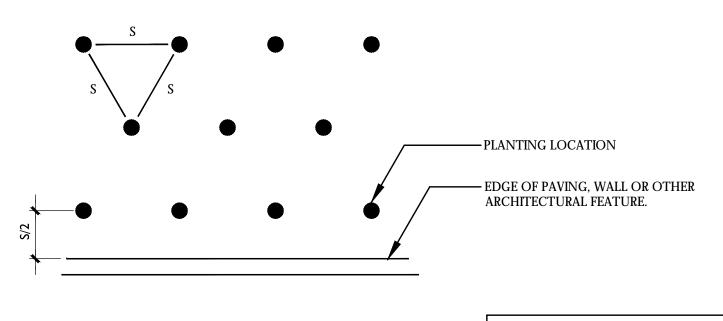

NOTES: A. S = PLANT SPACING DISTANCE ON CENTER, SEE CHART B. FOR USE AS A GUIDE FOR SHRUBS AND GROUNDCOVER WHEN PLANTS ARE SPACED EQUIDISTANT FROM EACH OTHER.	Plant Quantity Chart				
	Spacing	# of Plants/S.F.			
D EOD LICE AS A CLUIDE EOD SUBLIDS AND	6" o.c.	4.60			
	8" o.c.	2.60			
	12" o.c.	1.15			
of Note Esomethic Thom Enor Office.	18" o.c.	.512			
	24" o.c.	.290			
	30" o.c.	.185			
	36" o.c.	.128			
	42" o.c.	.087			

48" o.c.

.063


TREE STAKING DETAIL - ON SITE SCALE: 3/8" = 1'-0"

LINEAR ROOT BARRIER

SCALE: 1" = 10'-0"


VINE PLANTING

SCALE: NTS

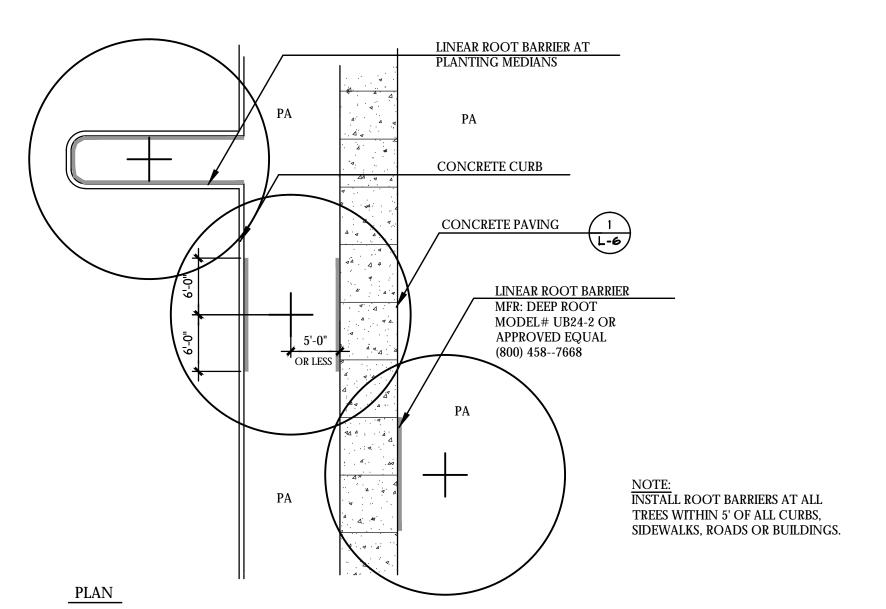





SEE SHEET LL0.2 FOR MFR. INFORMATION COLOR: BLACK

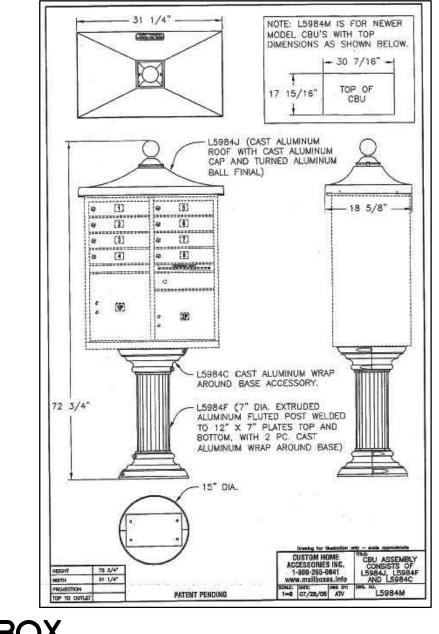

PLANT SPACING SCALE: N.T.S.


SCALE: 3/4" = 1'-0"

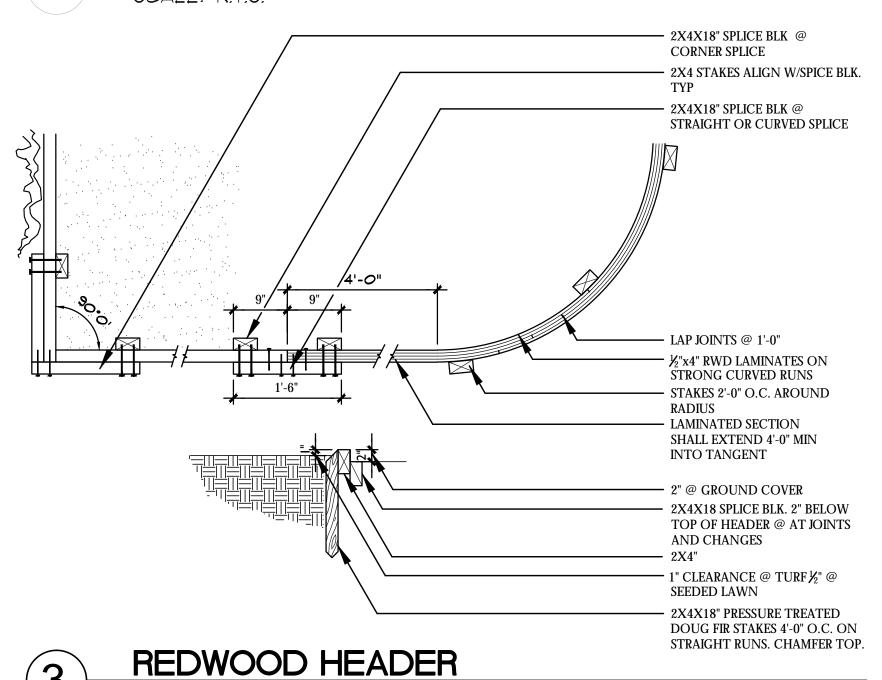

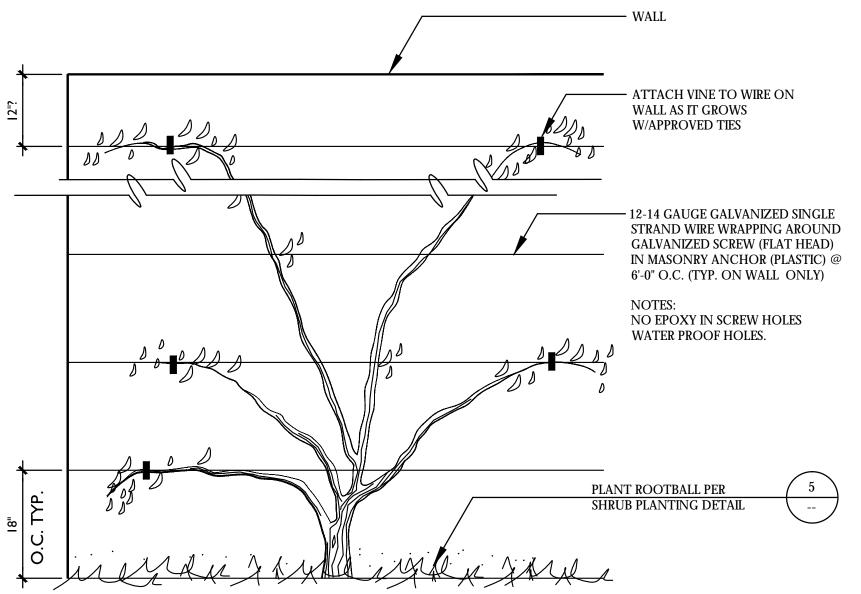


CLUSTER MAILBOX

SCALE: N.T.S.

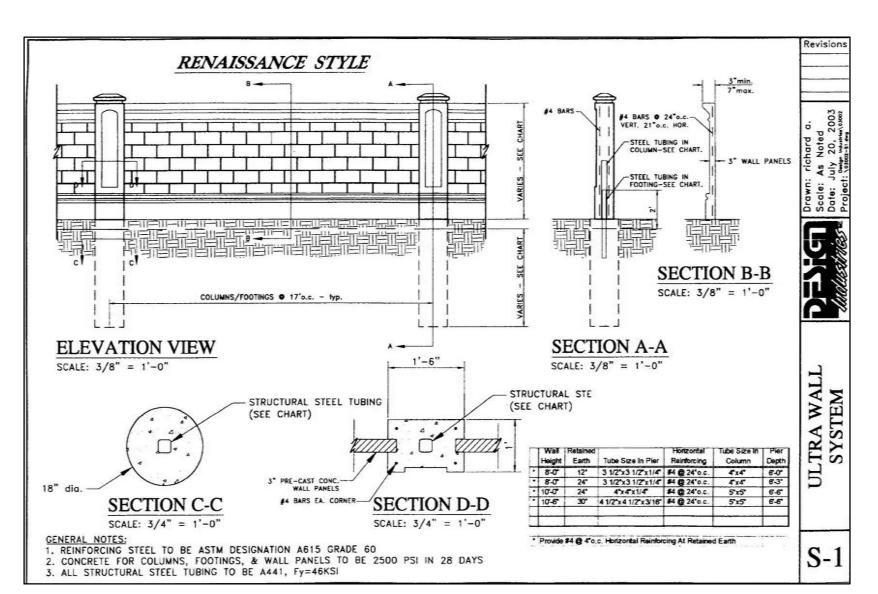



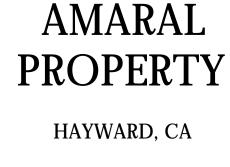


ATTACHMENT IV

ISSUE: DESCRIPTION: DATE: ISSUE 1 SITE REVIEW 05/27/2015 ISSUE 2 SITE REVIEW 08/06/2015 ISSUE 3 SITE REVIEW 03/07/2016





PROJECT NUMBER: DRAWN: MNO CHECK: DATE: 05/27/2014


DG

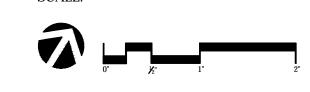

LANDSCAPE DETAILS

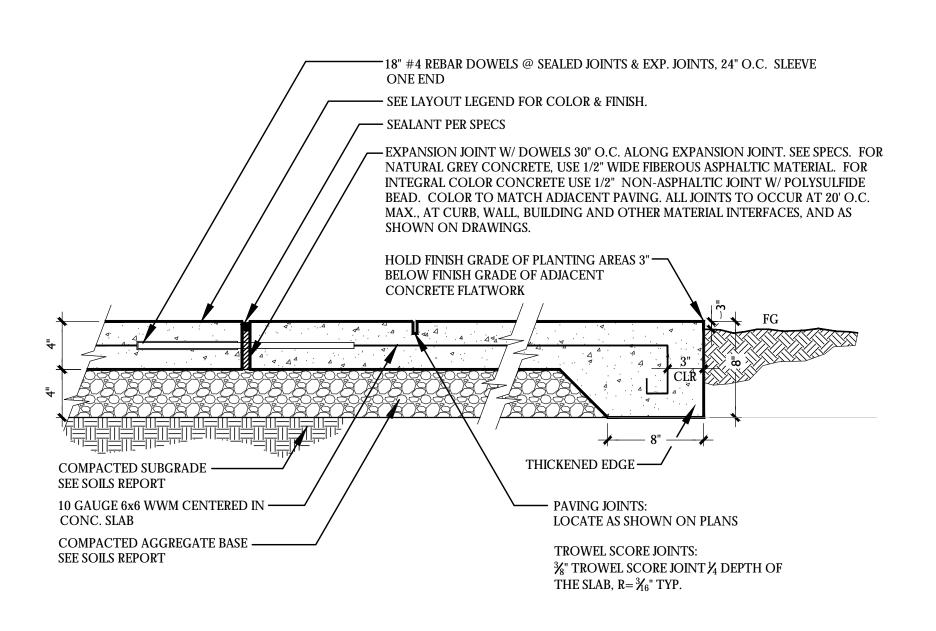

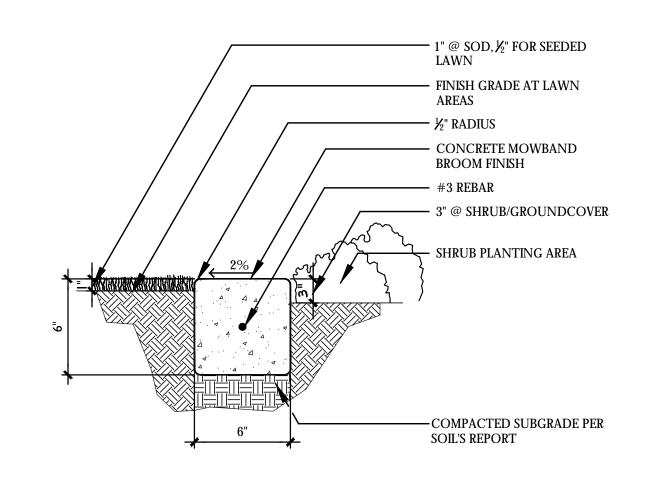

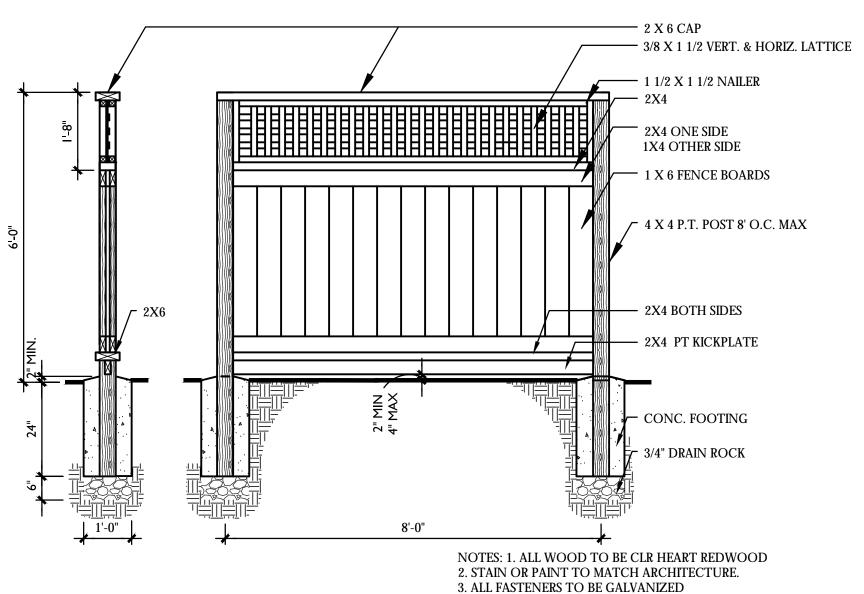

WOOD PRIVACY FENCE W/ LATTICE

1/2" W EXPANSION JOINT —

TO ALLOW FOR CAULKING

STOP REBAR @ JOINT

12" O.C. PVC SLIP JT. @ ONE END

CONCRETE SEATWALL

EXPANSION JOINT AT SEAT WALL

— #5 DOWEL, 18" LONG @

PREMOLDED JT. FILLER MATERIAL RECESS

SCALE: 3"= 1'-0"


- CONSTRUCTION JTS. @ CORNERS. 30" O.C. MAX.

COLOR: TO MATCH SEATWALL COLOR

SCALE: N.T.S.

8

1/2" 1/2" 1/2"

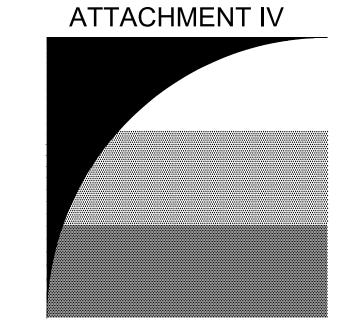

GATES +ASSOCIATES

LANDSCAPE ARCHITECTURE LAND PLANNING • URBAN DESIGN 2671 CROW CANYON RD. SAN RAMON, CA 94583 T 925.736.8176 www.dgates.com

AMARAL

PROPERTY HAYWARD, CA

ISSUE: DESCRIPTION: DATE: ISSUE 1 SITE REVIEW 05/27/2015 ISSUE 2 SITE REVIEW 08/06/2015

ISSUE 3 SITE REVIEW

PROJECT NUMBER: DRAWN: CHECK:


DATE:

05/27/2014

LANDSCAPE DETAILS


Page 13 of 46

PEDESTRIAN CONCRETE PAVING SCALE: 1 1/2" = 1'-0"

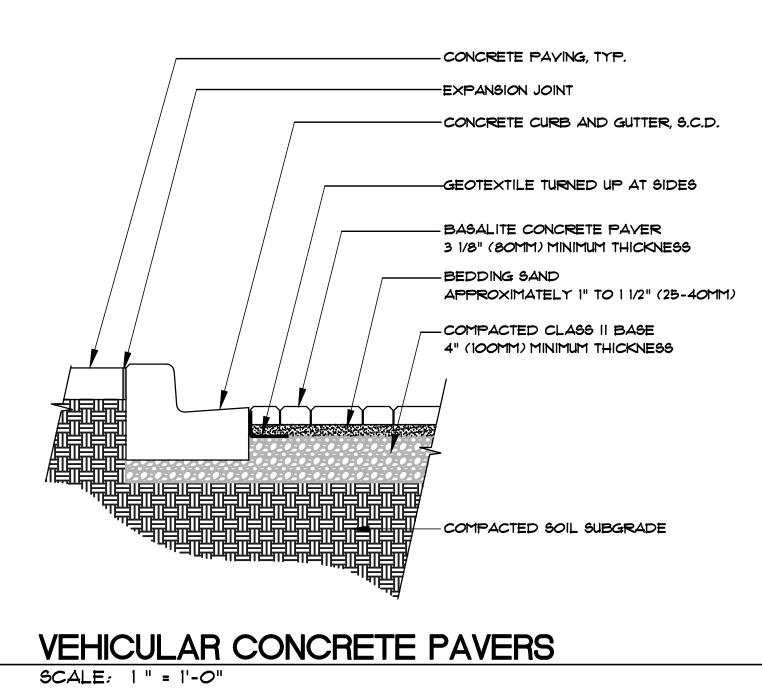

SCALE: 1 1/2" = 1'-0"


6" CONCRETE MOWBAND

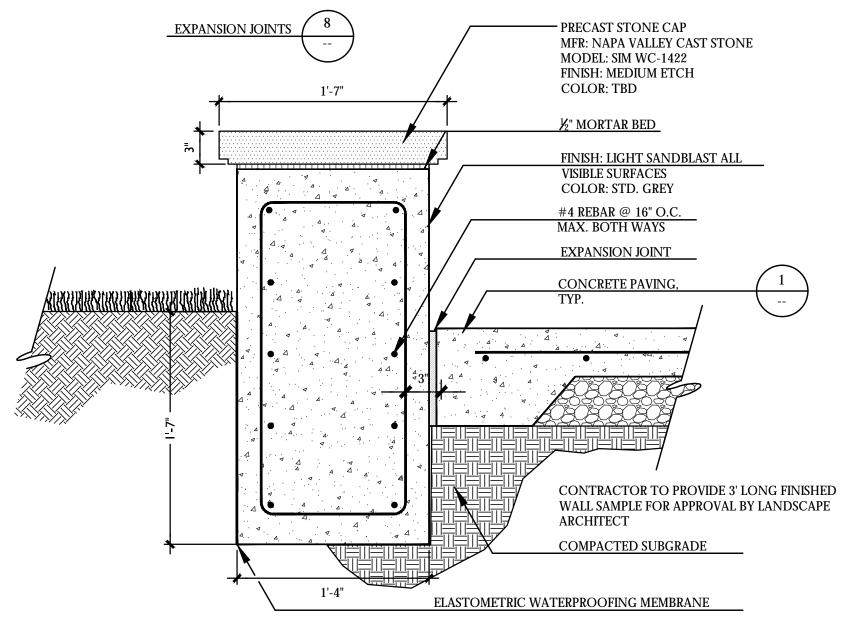









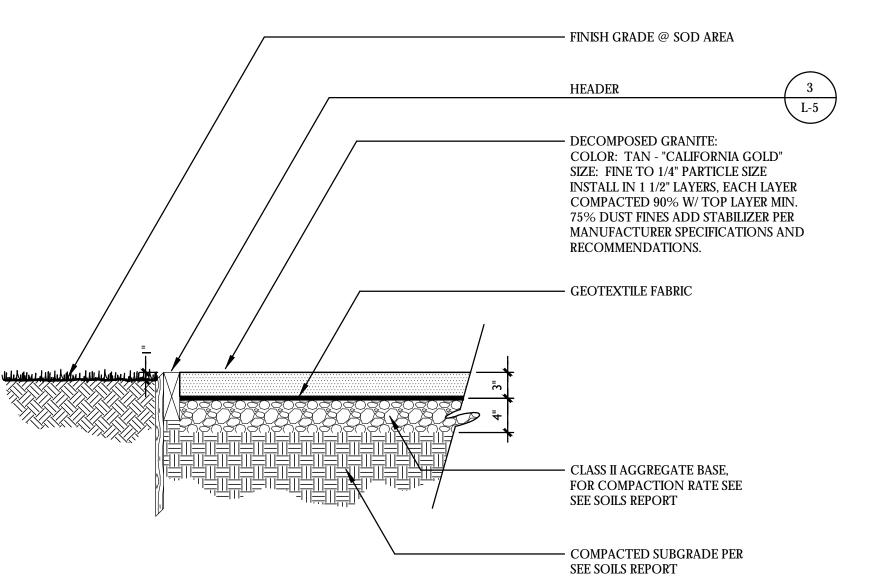


DECOMPOSED GRANITE PAVING

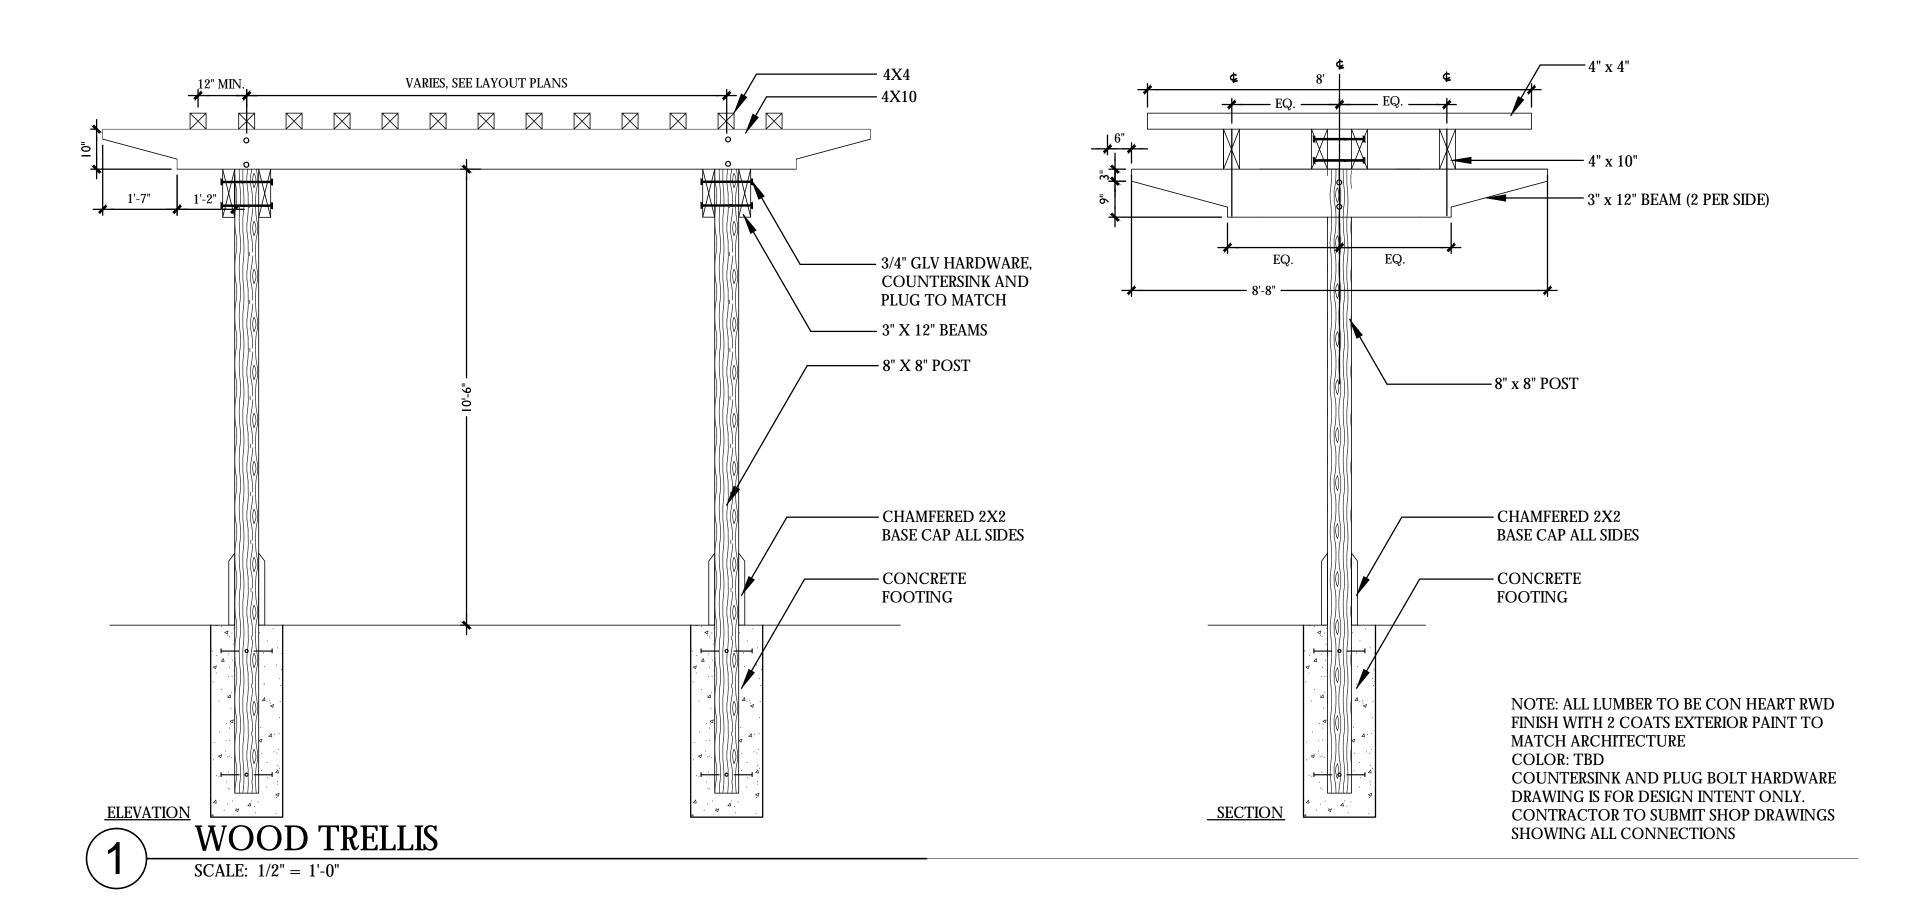

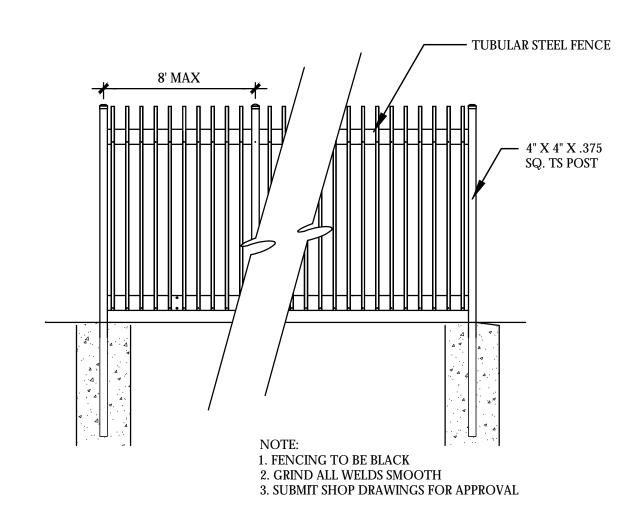


ORNAMENTAL IRON FENCE SCALE: 3/8" = 1'-0"

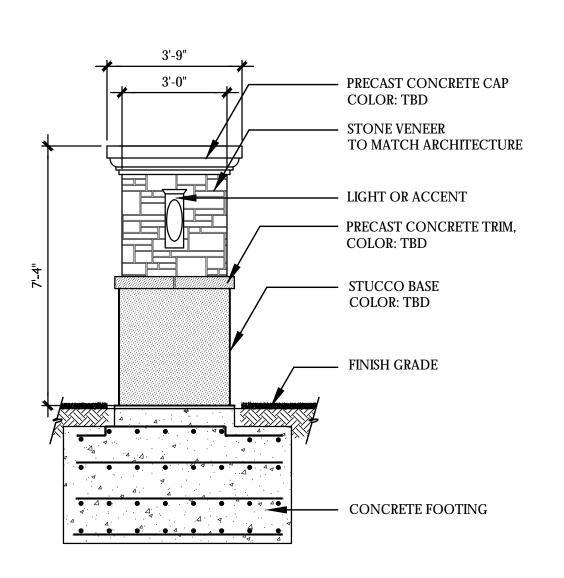

DECORATIVE MONOLITH

SCALE: 3/8" = 1'-0"

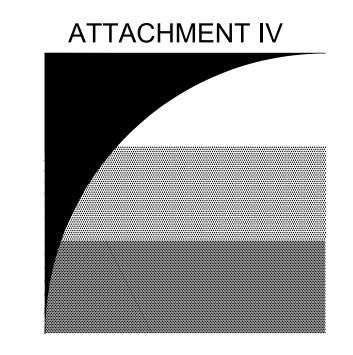

GATES
+ASSOCIATES
LANDSCAPE ARCHITECTURE

LAND PLANNING • URBAN DESIGN


2671 CROW CANYON RD. SAN RAMON, CA 94583

T 925.736.8176 www.dgates.com

AMARAL PROPERTY

HAYWARD, CA

ISSUE: DESCRIPTION: DATE:
ISSUE 1 SITE REVIEW 05/27/2015
ISSUE 2 SITE REVIEW 08/06/2015
ISSUE 3 SITE REVIEW 03/07/2016

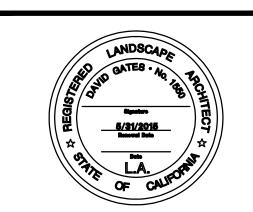


PROJECT NUMBER:
DRAWN:

DRAWN: CHECK: DATE:

DG 05/27/2014


MNO

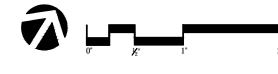


LANDSCAPE DETAILS

L-7

Page 14 of 46

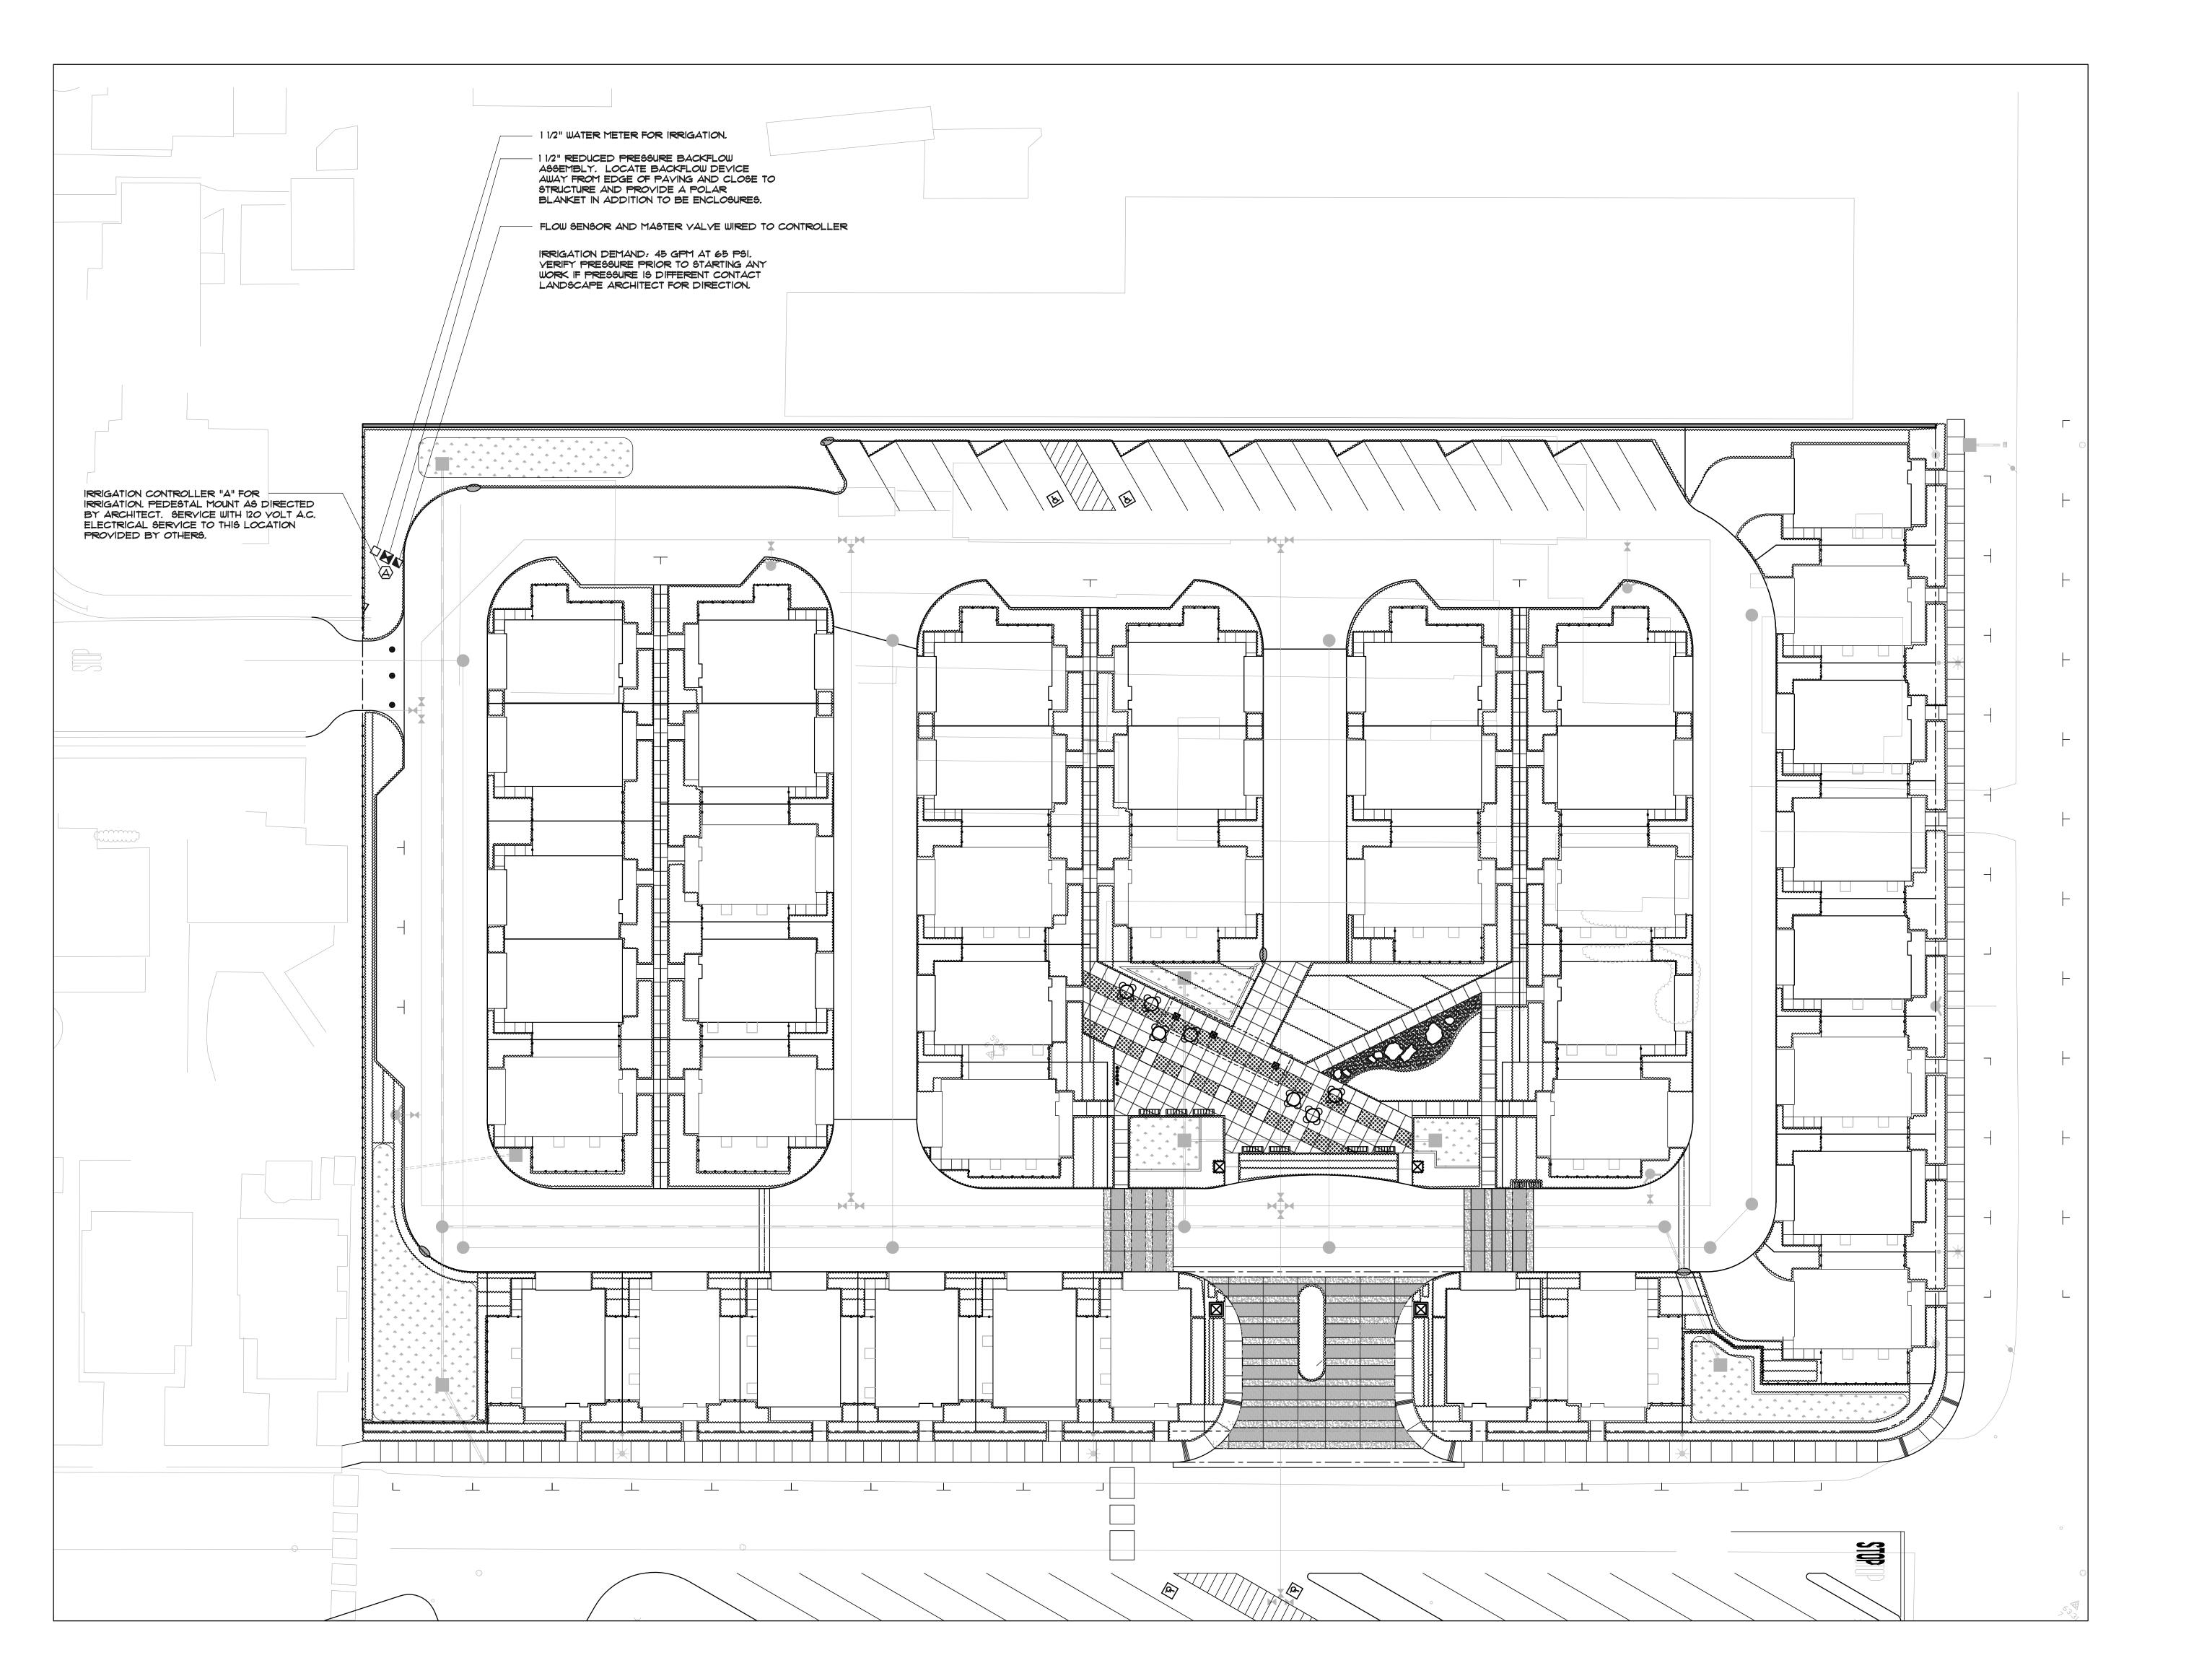

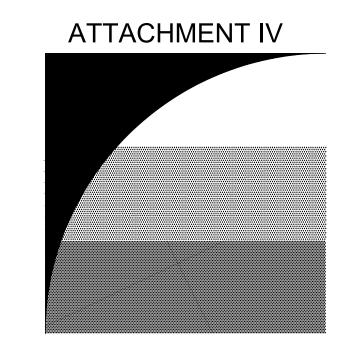

GATES +ASSOCIATES

LANDSCAPE ARCHITECTURE
LAND PLANNING • URBAN DESIGN

2671 CROW CANYON RD. SAN RAMON, CA 94583
T 925.736.8176 www.dgates.com

AMARAL PROPERTY

HAYWARD, CA


ISSUE:DESCRIPTION:DATE:ISSUE 1SITE REVIEW05/27/2015ISSUE 2SITE REVIEW08/06/2015ISSUE 3SITE REVIEW03/07/2016



PROJECT NUMBER: DRAWN:

DRAWN: CHECK: DATE:

 $\begin{array}{r}
 D0 \\
 05/27/201 \\
 1" = 20'-0
 \end{array}$

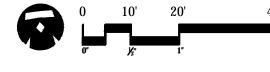

IRRIGATION CONCEPT


L-8

IRRIGATION NOTES

- 1. THIS DESIGN IS DIAGRAMMATIC. ALL PIPING, VALVES, ETC. SHOWN WITHIN PAVED AREAS IS FOR DESIGN CLARIFICATION ONLY AND SHALL DE INSTALLED IN PLANTING AREAS WHERE POSSIBLE. AVOID ANY CONFLICTS BETWEEN THE SPRINKLER SYSTEM, PLANTING AND ARCHITECTURAL FEATURES.
- 2. DO NOT WILLFULLY INSTALL THE SPRINKLER SYSTEM AS SHOWN ON THE DRAWINGS WHEN IT IS OBVIOUS IN THE FIELD THAT OBSTRUCTIONS, GRADE DIFFERENCES OR DIFFERENCES IN THE AREA DIMENSIONS EXIST THAT MIGHT NOT HAVE BEEN CONSIDERED IN THE ENGINEERING. SUCH OBSTRUCTIONS OR DIFFERENCES SHOULD BE BROUGHT TO THE ATTENTION OF THE OWNER'S AUTHORIZED REPRESENTATIVE. IN THE EVENT THAT THIS NOTIFICATION IS NOT PERFORMED, THE IRRIGATION CONTRACTOR SHALL ASSUME FULL RESPONSIBILITY FOR ANY REVISIONS NECESSARY.
- 3. IT IS THE RESPONSIBILITY OF THE IRRIGATION CONTRACTOR TO FAMILIARIZE HIMSELF WITH ALL GRADE DIFFERENCES, LOCATION OF WALLS, RETAINING WALLS, ETC. HE SHALL COORDINATE HIS WORK WITH THE GENERAL CONTRACTOR AND OTHER SUBCONTRACTORS FOR THE LOCATION AND THE INSTALLATION OF PIPE SLEEVES THROUGH WALLS, UNDER ROADWAYS, PAVING, STRUCTURES, ETC.
- 4. DUE TO THE SCALE OF THE DRAWINGS, IT IS NOT POSSIBLE TO INDICATE ALL OFFSETS, FITTINGS, SLEEVES, ETC., WHICH MAY BE REQUIRED. THE CONTRACTOR SHALL CAREFULLY INVESTIGATE THE STRUCTURAL AND FINISHED CONDITIONS AFFECTING ALL OF HIS WORK AND PLAN HIS WORK ACCORDINGLY, FURNISHING SUCH FITTINGS, ETC., AS MAY DE REQUIRED TO MEET SUCH CONDITIONS. DRAWINGS ARE GENERALLY DIAGRAMMATIC AND INDICATIVE OF THE WORK TO DE INSTALLED. THEN WORK SHALL DE INSTALLED IN SUCH A MANNER AS TO AVOID CONFLICTS BETWEEN IRRIGATION SYSTEMS, PLANTING, AND ARCHITECTURAL FEATURES.
- 5. ELECTRICAL CONTRACTOR TO SUPPLY 120 VOLT A.C. (2.5 AMP) SERVICE TO CONTROLLER LOCATION. IRRIGATION CONTRACTOR TO MAKE FINAL CONNECTION FROM ELECTRICAL STUB-OUT TO CONTROLLER.
- 6. EACH CONTROLLER SHALL HAVE ITS OWN INDEPENDENT GROUND WIRE.
- 7. VALVE LOCATIONS SHOWN ARE DIAGRAMMATIC. INSTALL IN GROUND COVER/SHRUB AREAS WHERE POSSIBLE (NOT IN LAWN AREA).
- 8. SPLICING OF 24 VOLT WIRES WILL NOT DE PERMITTED EXCEPT IN VALVE BOXES. LEAVE A 24" COIL OF EXCESS WIRE AT EACH SPLICE AND 100 FEET ON CENTER ALONG WIRE RUN. TAPE WIRE IN BUNDLES 10 FEET ON CENTER. NO TAPING PERMITTED INSIDE SLEEVES.
- 9. INSTALL FOUR (4) SPARE CONTROL WIRES ALONG THE ENTIRE MAIN LINE. LOOP 36" EXCESS WIRE INTO EACH SINGLE VALVE BOX AND INTO ONE VALVE BOX IN EACH GROUP OF VALVES. SPARE WIRES SHALL BE YELLOW, COMMON WIRES SHALL BE WHITE AND CONTROL WIRES SHALL BE RED.
- 10. THE IRRIGATION CONTRACTOR SHALL FLUSH AND ADJUST ALL DRIP TUBES FOR OPTIMUM PERFORMANCE.
- 11. NOTIFY ARCHITECT OF ANY ASPECTS OF LAYOUT WHICH WILL PROVIDE INCOMPLETE OR INSUFFICIENT WATER COVERAGE OF PLANT MATERIAL AND DO NOT PROCEED UNTIL HIS INSTRUCTIONS ARE OBTAINED.
- 12. ALL SPRINKLER HEADS SHALL BE SET PERPENDICULAR TO FINISH GRADE OF THE AREA TO BE IRRIGATED UNLESS OTHERWISE DESIGNATED ON THE PLANS.
- 13. INSTALL A VALCON 5000 SERIES SPRING LOADED CHECK VALVE BELOW DRIP BUBBLERS WHERE LOW HEAD DRAINAGE WILL CAUSE EROSION AND EXCESS WATER.
- 14. INSTALL VALVE BOXES 12" FROM AND PERPENDICULAR TO WALK, CURB, BUILDING OR LANDSCAPE FEATURE. AT MULTIPLE VALVE BOX GROUPS, EACH BOX SHALL DE AN EQUAL DISTANCE FROM THE WALK, CURB, ETC. AND EACH BOX SHALL DE 12" APART. SHORT SIDE OF VALVE BOX SHALL BE PARALLEL TO WALK, CURB LAWN, ETC.
- 15. THE SPRINKLER SYSTEM DESIGN IS BASED ON THE MINIMUM OPERATING PRESSURE SHOWN ON THE IRRIGATION DRAWINGS. THE IRRIGATION CONTRACTOR SHALL VERIFY WATER PRESSURE PRIOR TO CONSTRUCTION. REPORT ANY DIFFERENCE BETWEEN THE WATER PRESSURE INDICATED ON THE DRAWINGS AND THE ACTUAL PRESSURE READING AT THE IRRIGATION POINT OF CONNECTION TO THE OWNER'S AUTHORIZED REPRESENTATIVE.
- 16. OPERATE IRRIGATION CONTROLLER(S) BETWEEN THE HOURS OF 10:00 PM AND 7:00 AM.
- 17. IRRIGATION CONTRACTOR TO NOTIFY ALL LOCAL JURISDICTIONS FOR INSPECTION AND TESTING OF INSTALLED BACKFLOW PREVENTION DEVICE.
- 18. PRIOR TO TRENCHING, CALL UNDERGROUND SERVICE ALERT, (1-800) 642-2444 FOR NORTHERN CALIFORNIA
- 19. WHEN VERTICAL OBSTRUCTIONS (STREET LIGHTS, TREES, FIRE HYDRANTS, ETC.) INTERFERE WITH THE PATTERN OF THE DRIP TUBING LAYOUT SO AS TO PREVENT PROPER COVERAGE, THE IRRIGATION CONTRACTOR SHALL FIELD ADJUST THE DRIP SYSTEM AT THE LOCATION OF THE OBSTRUCTION SO AS TO PROVIDE PROPER COVERAGE. ALL ADJUSTMENTS SHALL BE MADE AT NO ADDITIONAL COST TO THE OWNER.

IRRIGATION LEGEND

SYMBOL	MODEL NUMBER	DESCRIPTION	PSI	GPM	PRECIP	RADIUS				
A	OCT816	PEPCO OCTA BUBBLER-SHRUBS	30	2 GPH	-	_				
•	RWS-B-C-1401	TREE BUBBLERS IN TURF— ONE RAINBIRD BUBBLER IN DEEP 30 .25 EACH — WATERING TUBE PER TREE								
->	M64/AP100	SPEARS FLUSHING END PLUG — LOCATE AT END OF LONG DRIP LINES								
● P-220-27		TORO REMOTE CONTROL VALVE								
×	T-113-K	NIBCO GATE VALVE (LINE SIZE) WITH CROSS HANDLE INSIDE ROUND VALVE BOX								
•	33-DLRC	RAIN BIRD 3/4" QUICK COUPLING VALVE								
	825Y-BV-SBBC-30SS	FEBCO BACKFLOW PREVENTOR WITH STRONG BOX ENCLOSURE								
O	1-1201-1151-8130 PMR-MF-30-1"	AMIAD 1" FILTER WITH 130 MESH SCREEN WITH SENNINGER 1" IN-LINE PRESSURE REDUCING VALVE (1-22 GPM)								
A	RME24EG RS1000	RAINMASTER ET BASED CONTROLLER WALL MOUNTED INSIDE METAL ENCLOSURE WITH IRRITROL SYSTEMS WIRELESS RAIN SENSOR								
		IRRIGATION INSIDE DASHED OUTLINE AREA: TORO DL2000 DRIPLINE DRIP EMITTER TUBING PART NUMBER: RGP-412-10 - 1.0 GPH EMITTERS 12" ON CENTER DRIPLINE PIPE WITH TORO LOC-EZE FITTINGS (OR EQUAL) INSTALLED 4" COVER BELOW SOIL LEVEL AND 8" FROM EDGE OF SIDEWALK OR CURB. INSTALL DRIPLINE PER INSTALLATION DETAILS SHEET L-8								
A-1 1" 15		STATION NUMBER GALLONS PER MINUTE VALVE SIZE								
		MAINLINE: SCHEDULE 40 PVC PLASTIC PIPE WITH SCHEDULE 40 PVC SOLVENT WELD FITTINGS. 18" COVER.								
		LATERAL LINE: 1120-CLASS 200 PVC PLASTIC PIPE WITH SCHEDULE 40 PVC SOLVENT WELD FITTINGS. 12" COVER.								
		SLEEVE:1120-200 PSI PVC PLASTIC PIPE W/SCHEDULE 40 PVC PLASTIC FITTINGS. 24" COVER. SIZE NOTED ON PLANS.								

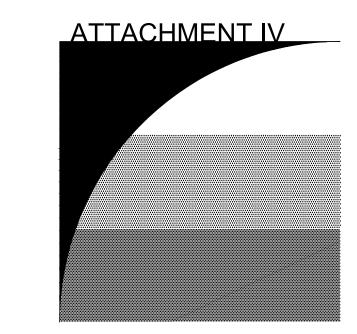

CATES
+ASSOCIATES
LANDSCAPE ARCHITECTURE
LAND PLANNING · URBAN DESIGN

2671 CROW CANYON RD. SAN RAMON, CA 94583T 925.736.8176 www.dgates.com

AMARAL PROPERTY

HAYWARD, CA


ISSUE: DESCRIPTION:
ISSUE 1 SITE REVIEW
ISSUE 2 SITE REVIEW
ISSUE 3 SITE REVIEW

DATE:


05/27/2015

08/06/2015

03/07/2016

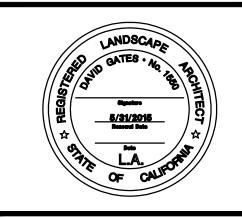


PROJECT NUMBER: P4894
DRAWN: MNO
CHECK: DG
DATE: 05/27/2014
SCALE:

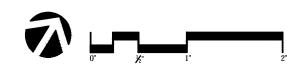



IRRIGATION NOTES & LEGEND

L-9


- of -Page 16 of 46

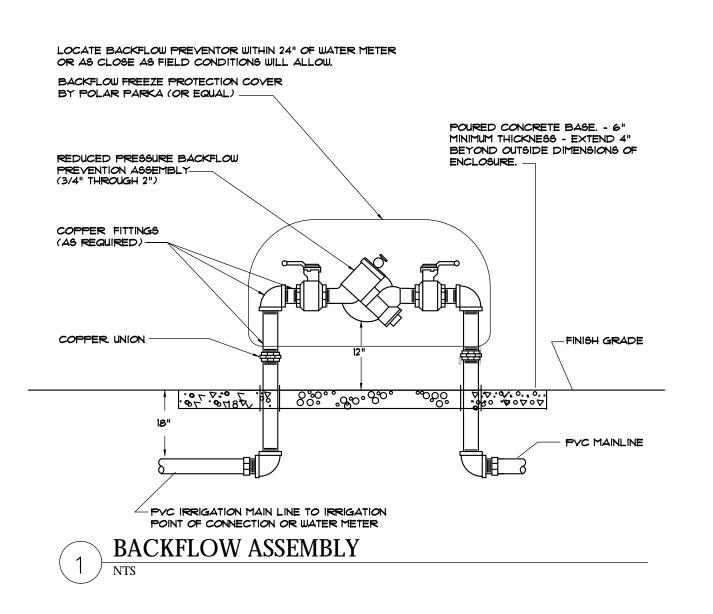


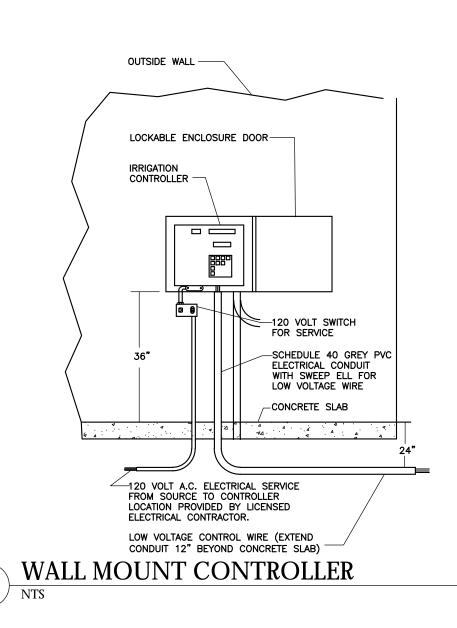


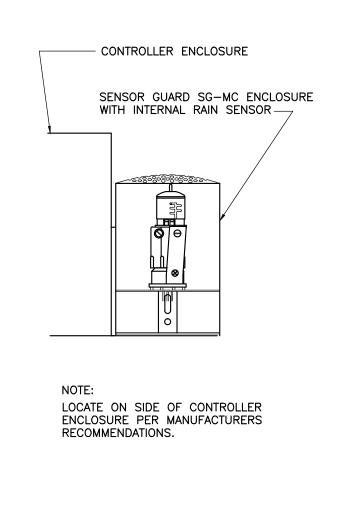





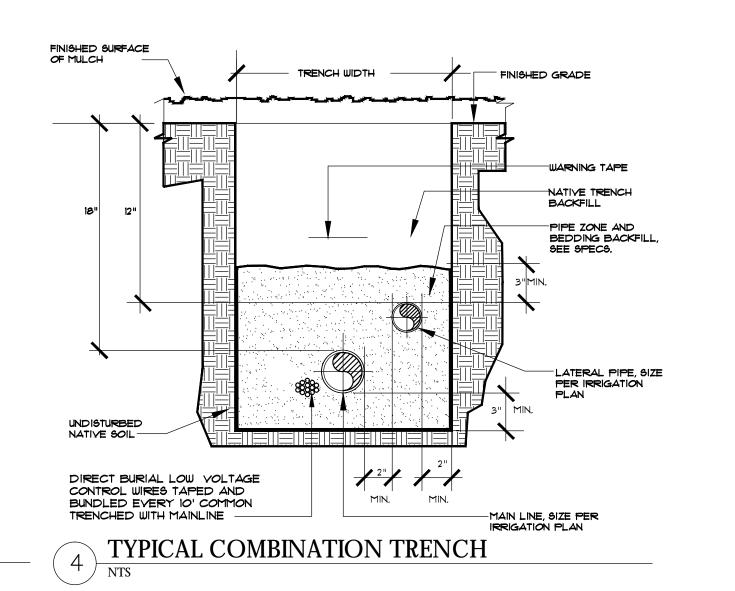

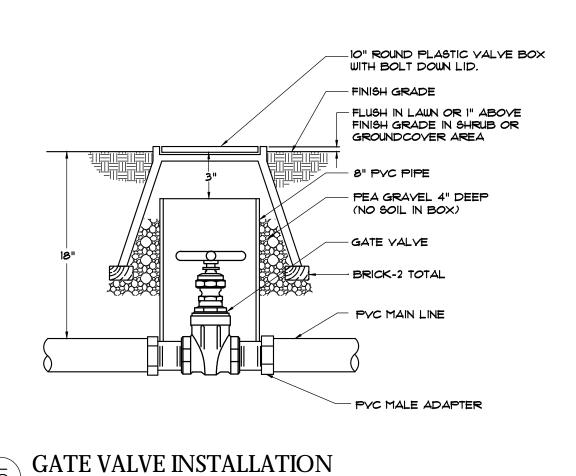


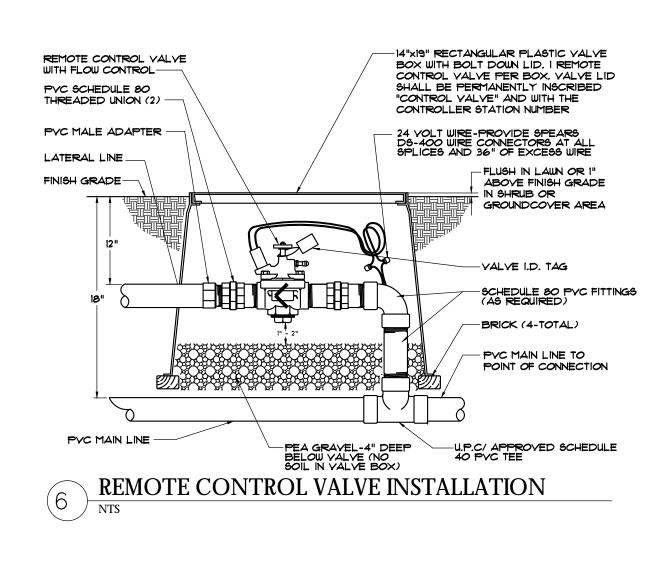

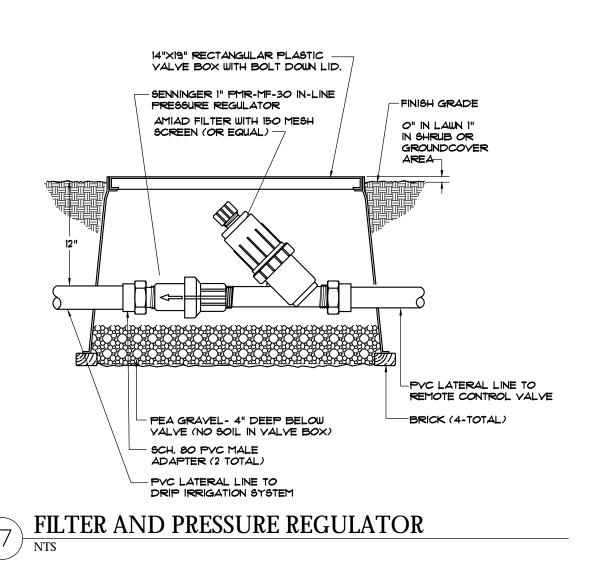


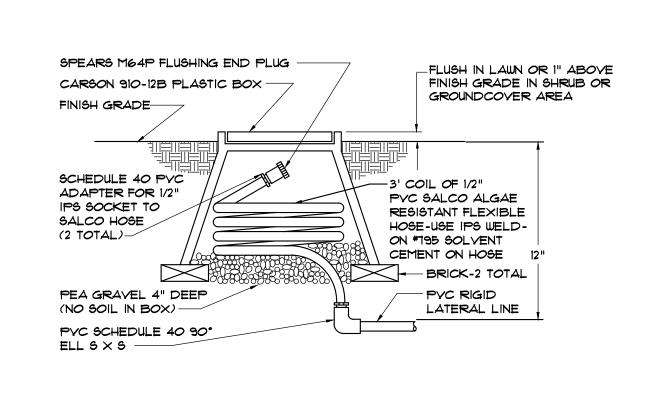




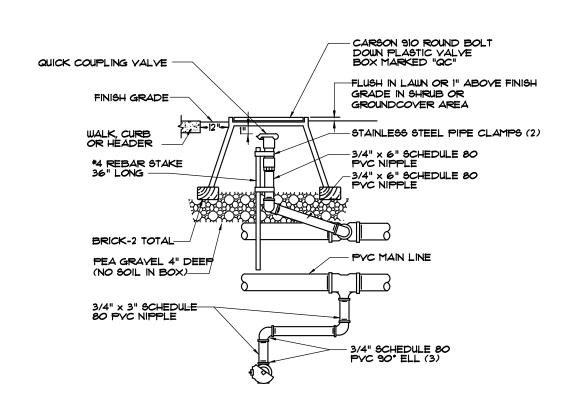




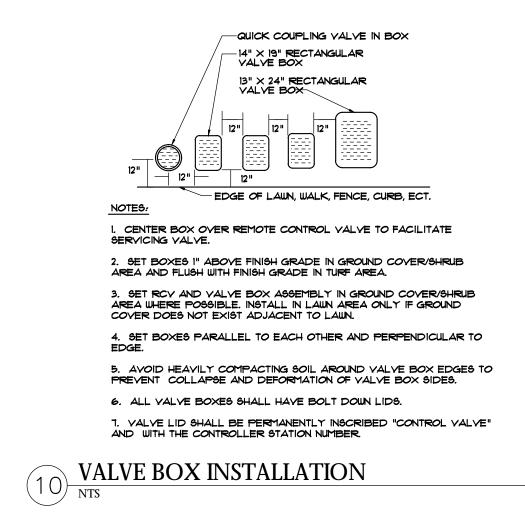

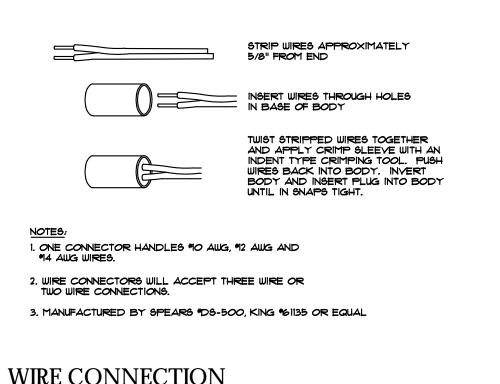




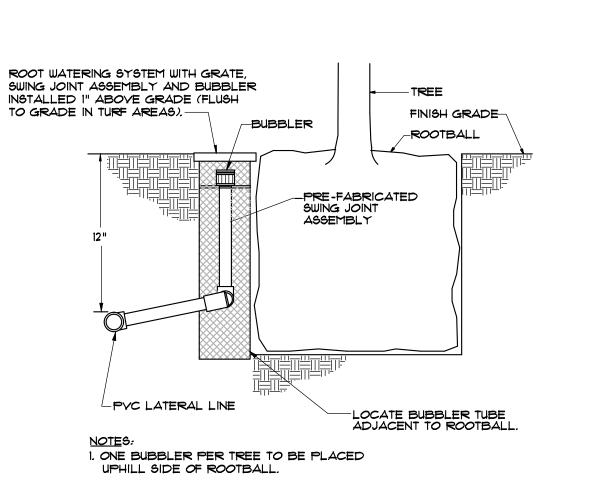

TREE BUBBLER INSTALLATION

NTS

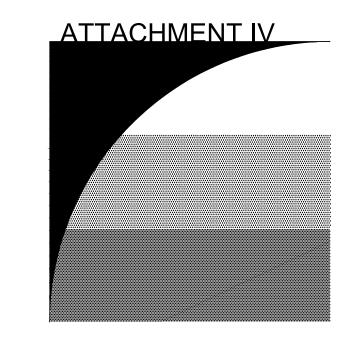


CATES
+ASSOCIATES
LANDSCAPE ARCHITECTURE
LAND PLANNING • URBAN DESIGN
2671 CROW CANYON RD. SAN RAMON, CA 94583

T 925.736.8176 www.dgates.com


AMARAL PROPERTY

HAYWARD, CA

ISSUE: DESCRIPTION: DATE:
ISSUE 1 SITE REVIEW 05/27/2015
ISSUE 2 SITE REVIEW 08/06/2015
ISSUE 3 SITE REVIEW 03/07/2016

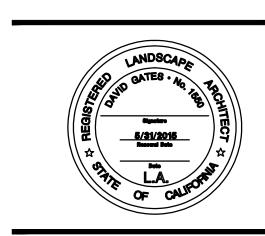



PROJECT NUMBER: P4894
DRAWN: MNO
CHECK: DG
DATE: 05/27/2014
SCALE:

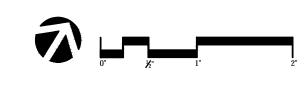



IRRIGATION DETAILS

L-10

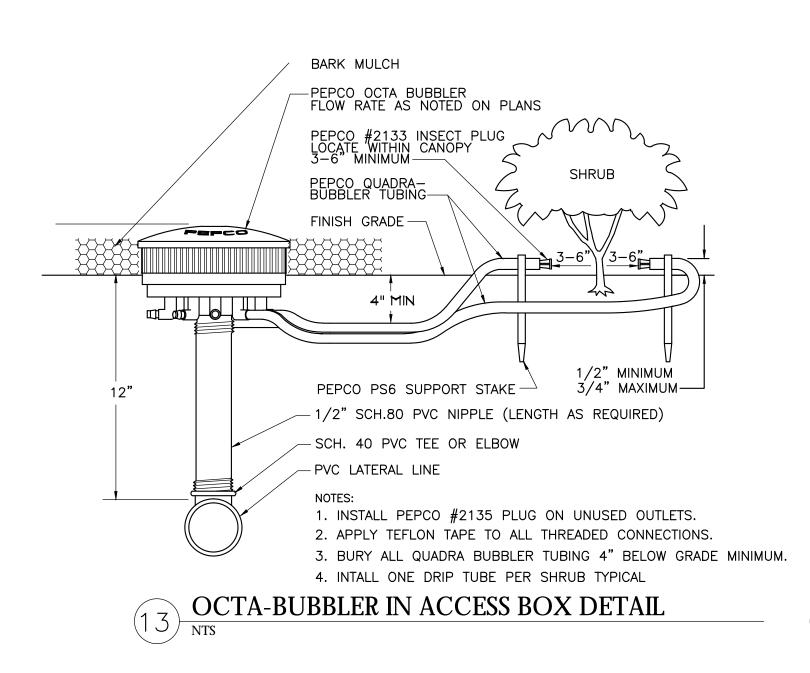

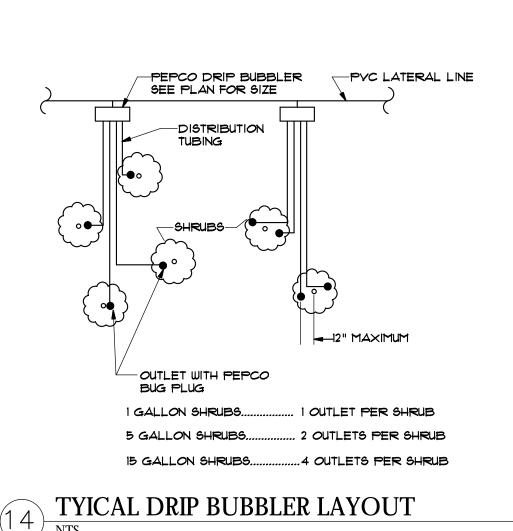

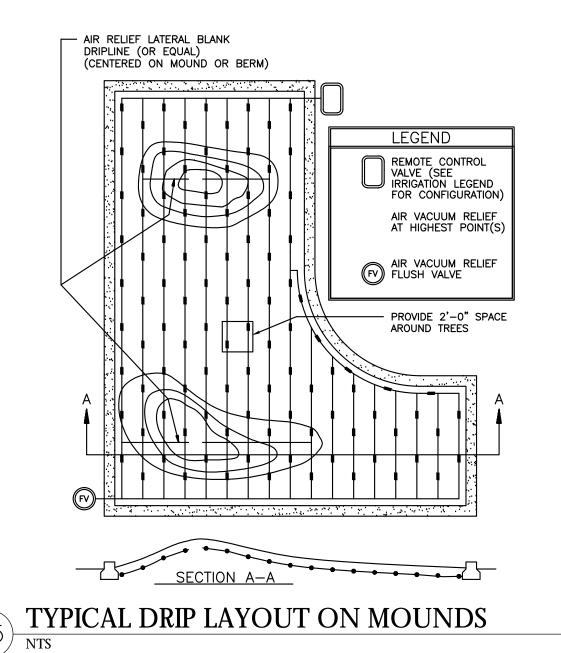

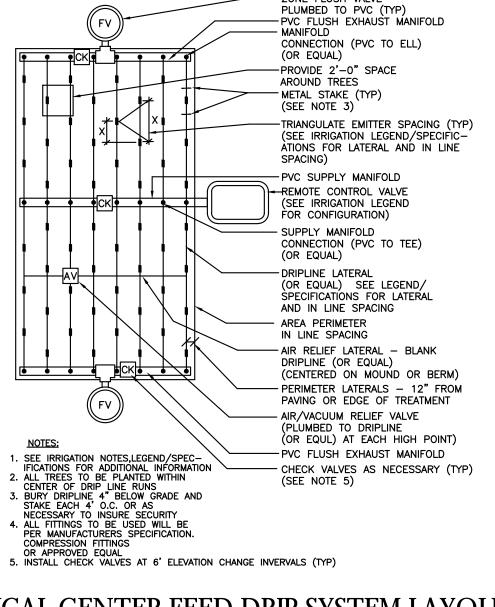

TYPICAL CENTER FEED DRIP SYSTEM LAYOUT




1. SEE IRRIGATION NOTES, LEGEND/SPECIFICATIONS FOR ADDITIONAL INFORMATION.


2. ALL TREES TO BE PLANTED WITHIN CENTER OF DRIP LINE RUNS

3. BURY DRIPLINE 4" BELOW GRADE AND STAKE EACH 36" O.C. LOCATED AT EMITTER AND AS NECESSARY TO INSURE SECURITY.

4. ALL FITTINGS TO BE USED WILL BE PER MANUFACTURERS SPECIFICATION. COMPRESSION FITTINGS OR APPROVED EQUAL.

5. CONNECT WITH BLANK TUBING TO EACH DRIPLINE.

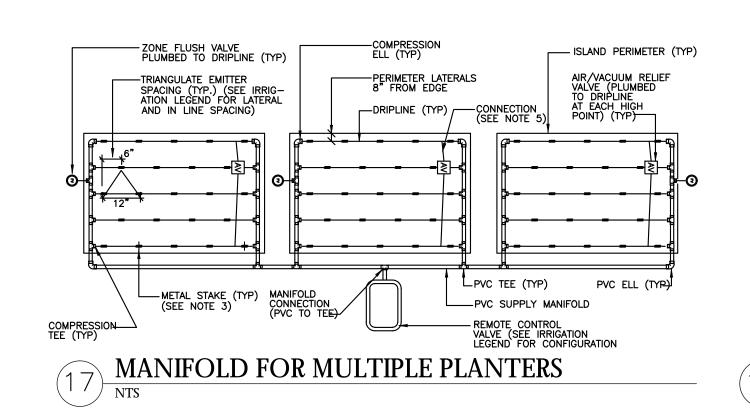

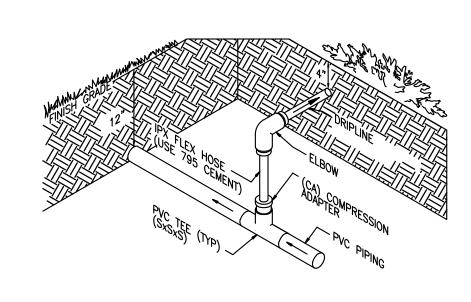

1. ALL FITTINGS TO BE PER MANUFACTURERS SPECIFICATION. USE COMPRESSION FITTINGS ONLY OR APPROVED EQUAL.


DRIPLINE TO PVC INSTALLATION

1. ALL FITTINGS TO BE PER MANUFACTURERS SPECIFICATION. USE COMPRESSION FITTINGS <u>ONLY</u> ON APPROVED EQUAL.

DRIPLINE TO PVC INSTALLATION

SUBSURFACE IRRIGATION INSTALLATION NOTES:


- 1. ASSEMBLE AND INSTALL FILTER, REMOTES CONTROL VALVE AND PRESSURE REGULATING VALVE ASSEMBLIES ACCORDING TO DETAILS.
- 2. ASSEMBLE AND INSTALL SUPPLY HEADERS ACCORDING TO DETAIL. TAPE OR PLUG OPEN CONNECTIONS TO PREVENT DEBRIS CONTAMINATION.
- 3. ASSEMBLE AND INSTALL EXHAUST HEADERS IN ACCORDANCE WITH
- DETAILS. TAPE OR PLUG ALL OPEN CONNECTIONS TO PREVENT DEBRIS CONTAMINATION. 4. INSTALL DRIP LATERALS. TAPE OR PLUG OPEN ENDS WHILE INSTALLING TO PREVENT DEBRIS CONTAMINATION.
- 5. INSTALL AIR VACUUM RELIEF VALVES AT HIGHEST POINTS OF THE IRRIGATION ZONES IN ACCORDANCE WITH DETAILS.
- 6. THOROUGHLY FLUSH DRIPLINE LATERALS AND CONNECT TO EXHAUST HEADERS OR INTERCONNECTING LATERALS WHILE FLUSHING.
- 7. THOROUGHLY FLUSH EXHAUST HEADERS AND INSTALL LINE FLUSHING VALVES ACCORDING TO DETAILS.
- 9. LOCATE AND INSTALL CHECK VALVE(S) AS NEEDED AND AS SHOWN IN INSTALLATION DETAILS.

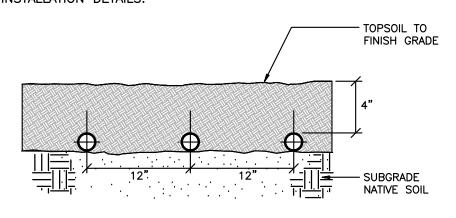

TYPICAL DRIPLINE SUBGRADE INSTALLATION


1. SEE IRRIGATION NOTES, LEGEND/SPECIFICATIONS FOR ALL DIMENSIONS AND LATERAL AND INLINE SPACING

- 2. ALL FITTINGS TO BE USED WILL BE PER MANUFACTURERS SPECIFICATIONS. USE COMPRESSION FITTINGS ONLY OR APPROVED EQUAL 3. IF DRIP TUBING HAS BEEN HAND DUG IN, STAKE DRIPLINE AT 4' O.C. AND AS NECESSARY TO INSURE SECURITY 4" BELOW GRADE. IF DRIP TUBING HAS BEEN PLOWED IN, NO STAKING IS NECESSARY.
- DRIPLINE TO PVC HEADER INSTALLATION

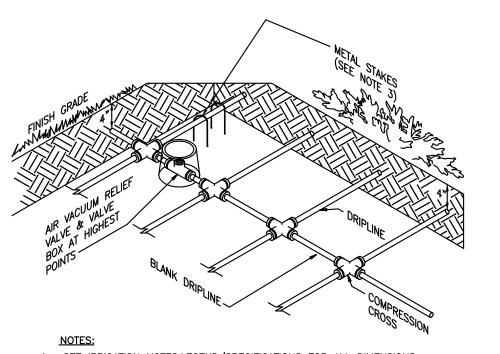


- . SEE IRRIGATION NOTES, LEGEND/SPECIFICATIONS FOR ALL DIMENSIONS AND LATERAL AND INLINE SPACING
- ALL FITTINGS TO BE USED WILL BE PER MANUFACTURERS SPECIFICATIONS. USE COMPRESSION FITTINGS <u>ONLY</u> OR APPROVED EQUAL IF DRIP TUBING HAS BEEN HAND DUG IN, STAKE DRIPLINE AT 4' O.C. AND AS NECESSARY TO INSURE SECURITY 4" BELOW GRADE. IF DRIP TUBING HAS BEEN PLOWED IN, NO STAKING IS NECESSARY.
- AIR VACUUM RELIEF VALVE LOCATION

 NTS

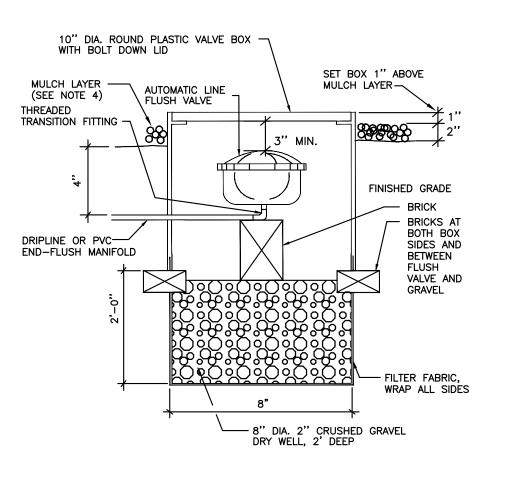

23 FLUSH VALVE FOR SUB SURFACE TUBING
NTS

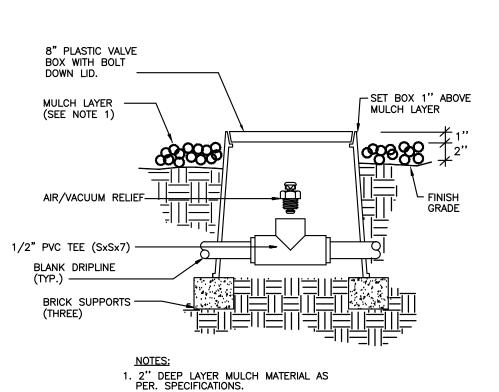

24 AIR/VACUUM RELIEF VALVE

1. 2" DEEP LAYER MULCH MATERIAL AS PER. SPECIFICATIONS.
2. AIR VACUUM RELIEF VALVE CANNOT BE CONNECTED LOWER THAN DRIPLINE LATERALS.

- of -Page 18 of 46

AMARAL PROPERTY HAYWARD, CA

ATTACHMENT IV

GATES

+ASSOCIATES

LANDSCAPE ARCHITECTURE

LAND PLANNING • URBAN DESIGN


2671 CROW CANYON RD. SAN RAMON, CA 94583

T 925.736.8176 www.dgates.com

ISSUE: DESCRIPTION: DATE: 05/27/2015 ISSUE 1 SITE REVIEW ISSUE 2 SITE REVIEW 08/06/2015

03/07/2016

ISSUE 3 SITE REVIEW

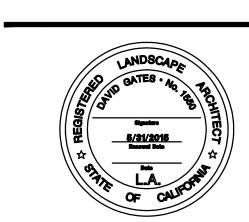

PROJECT NUMBER: MNO DRAWN: CHECK: DATE:

DG 05/27/2014

IRRIGATION DETAILS



KBHome


STREET SCENE


Page 19 of 46


-ADJACENT

BUILDING


OVERALL

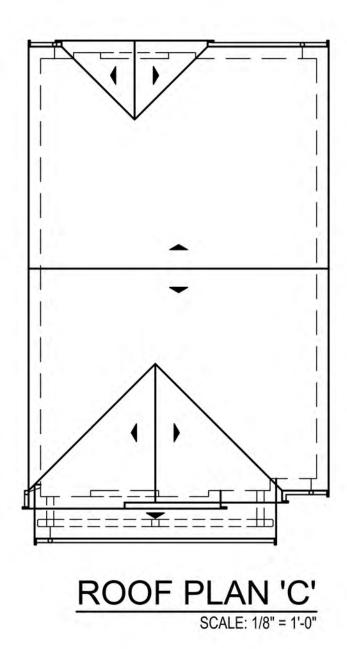

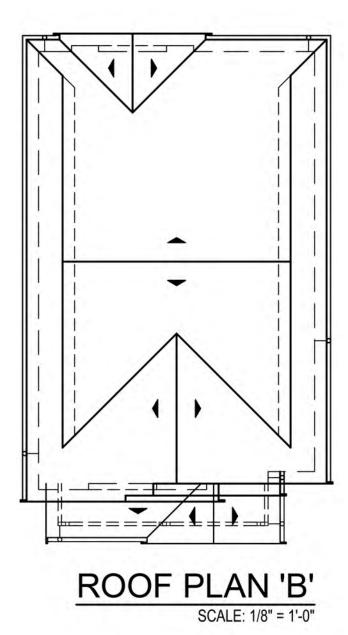

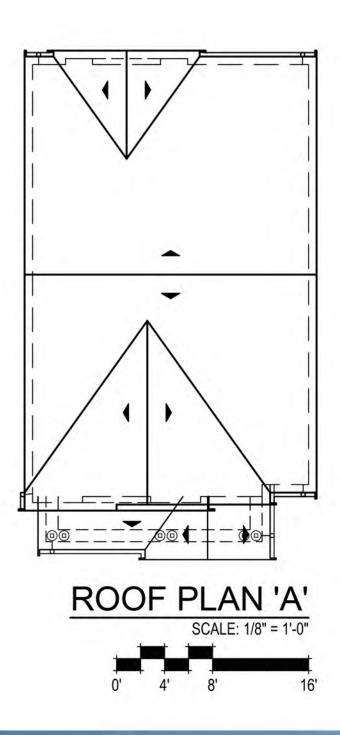



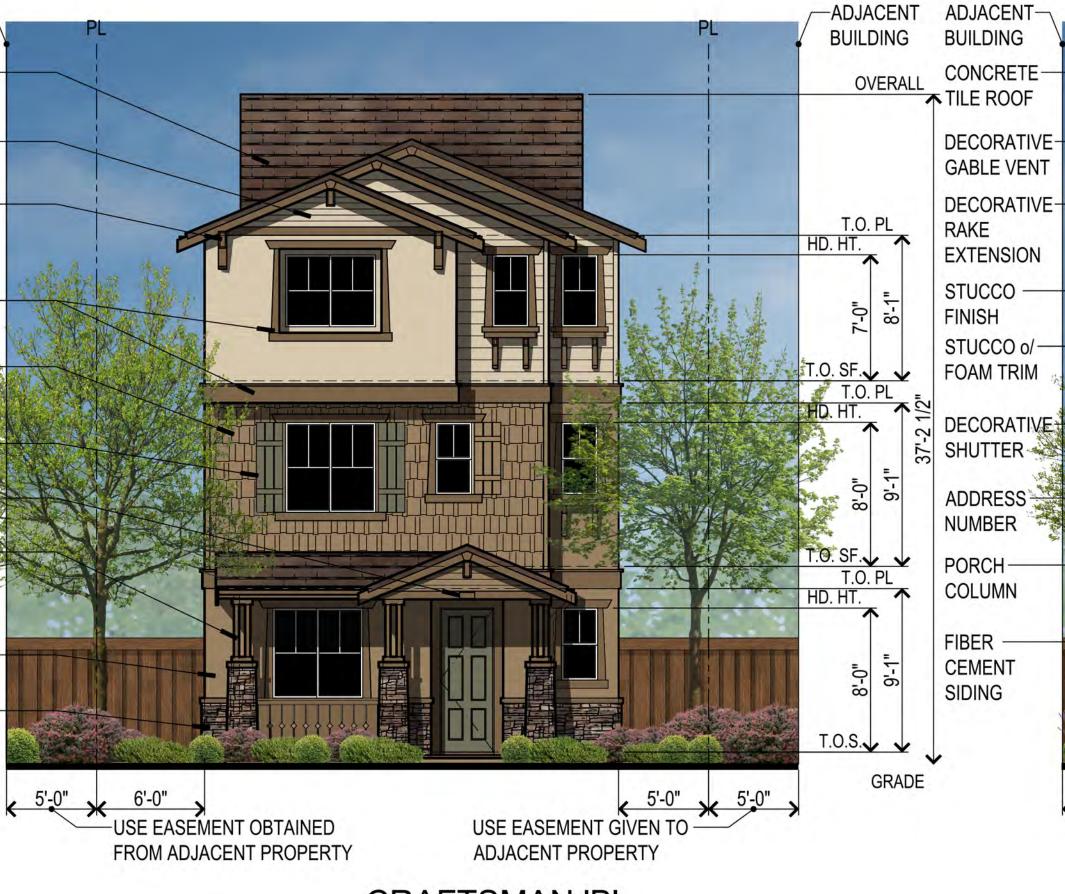

T.O. PL
HD. HT.
ADJACENT PROPERTY
ADJACENT PROPERTY

MONTEREY 'C'

SCALE: 3/16" = 1'-0"

CRAFTSMAN 'B'
SCALE: 3/16" = 1'-0"


SCALE: 3/16" = 1'-0"

0' 2' 4' 6' 8' 12


Amaral City of Hayward Mar 7, 2016


PLAN 1 FRONT ELEVATIONS & ROOF PLANS

A02

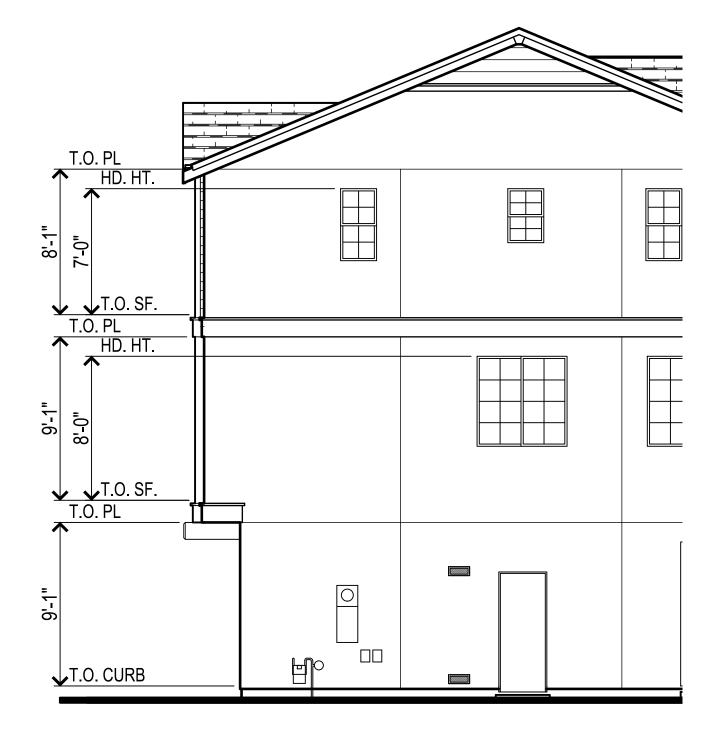

<u>LEF</u>

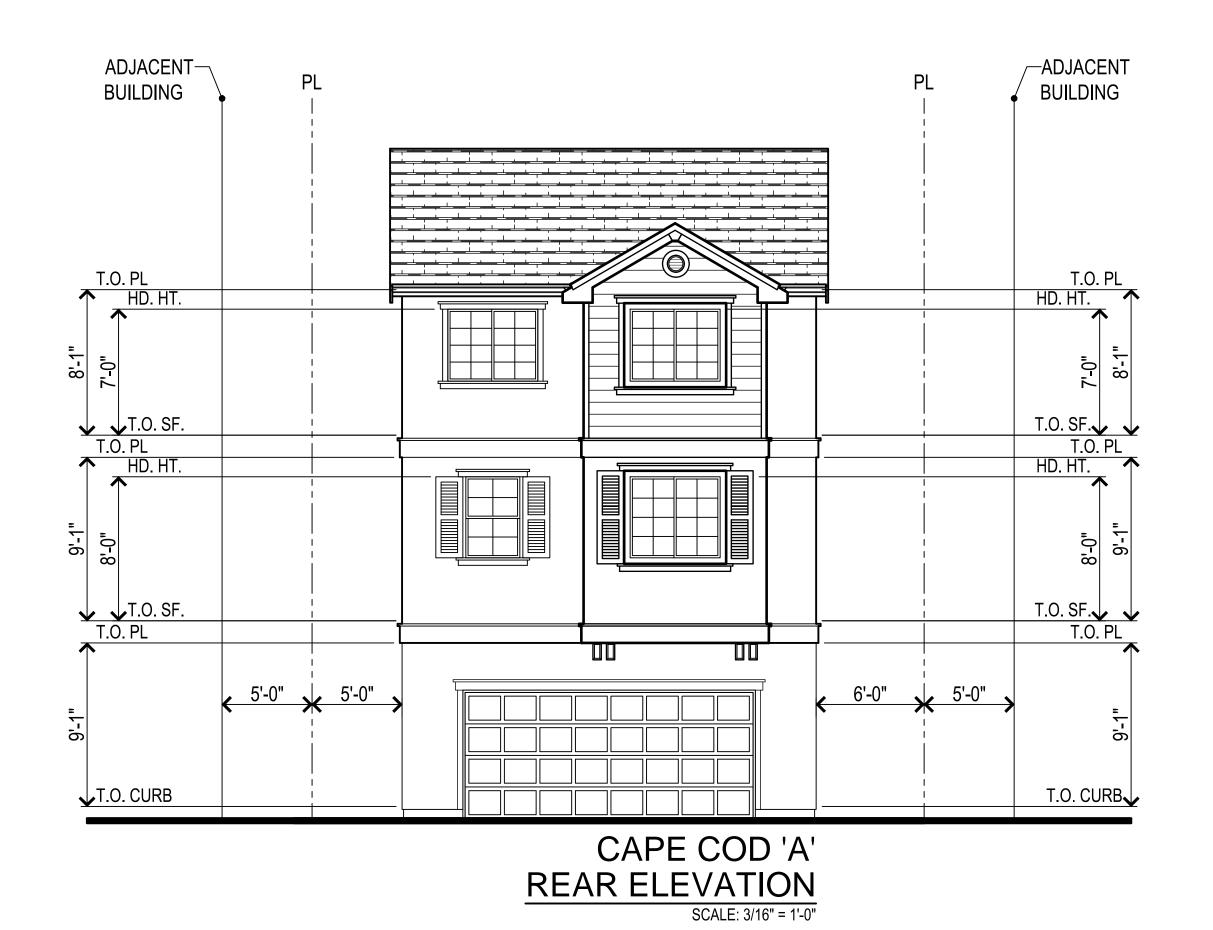

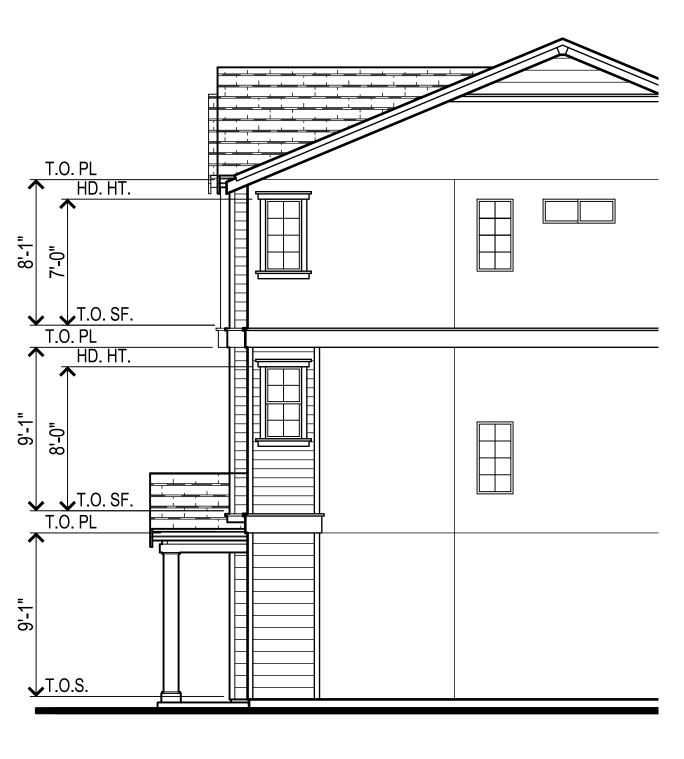



<u>RIGH</u>


Amaral
City of Hayward
Mar 7, 2016

PLAN 1 'A' ELEVATION

KBHome

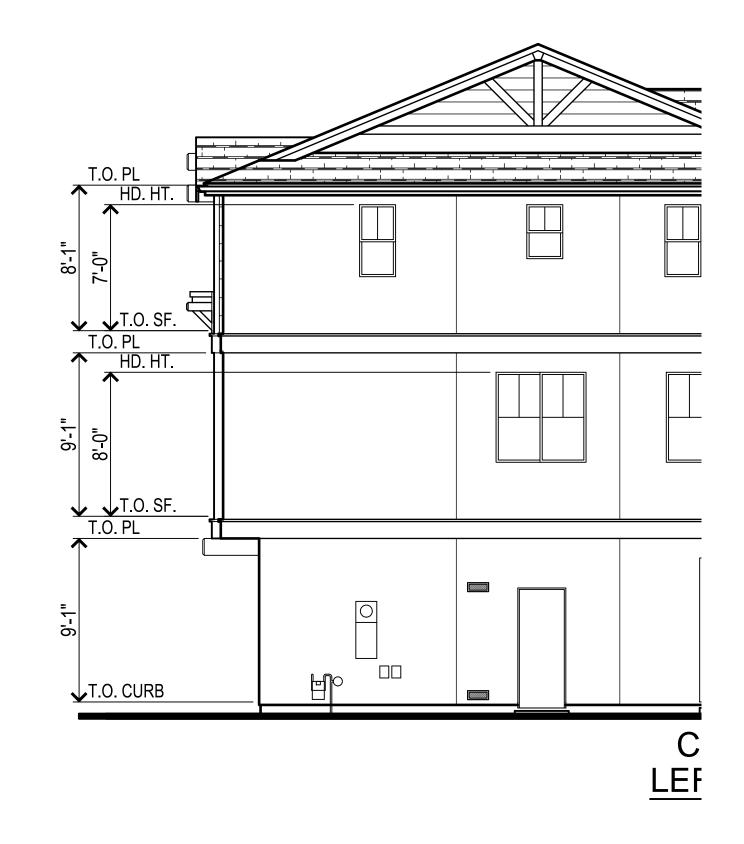


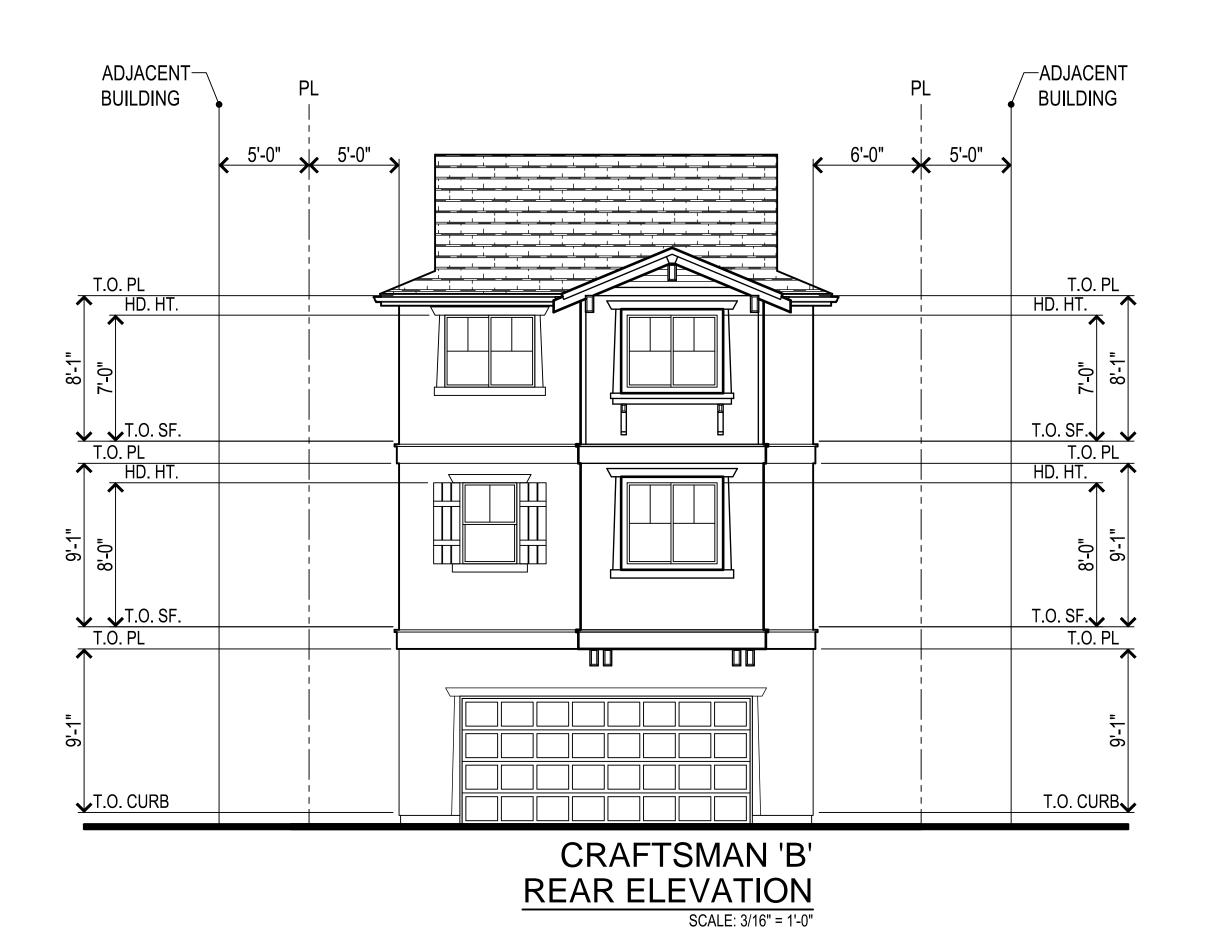


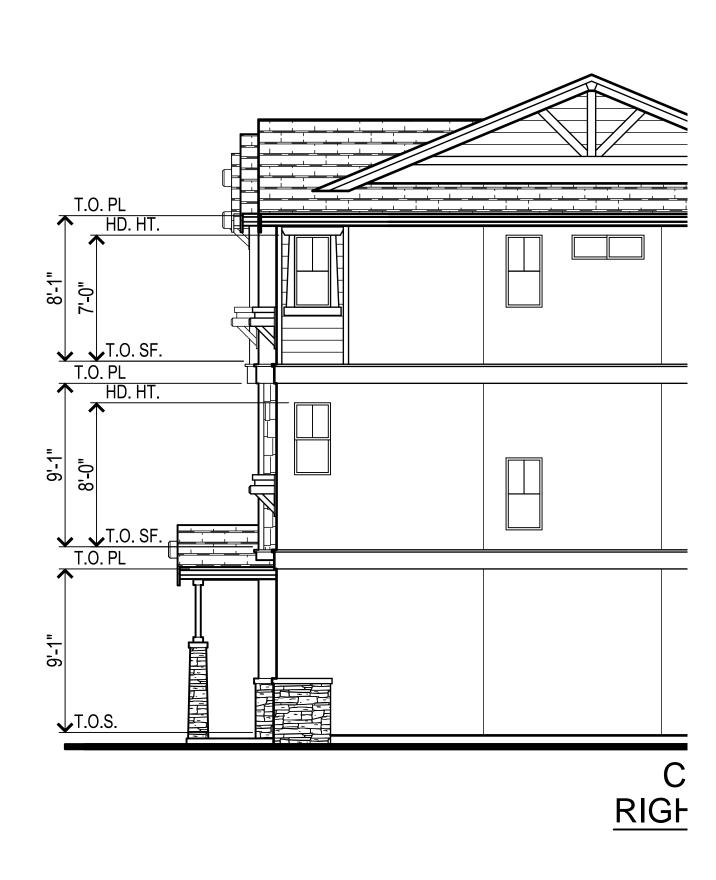


PLAN 1 'B' ELEVATION

K B H o m e

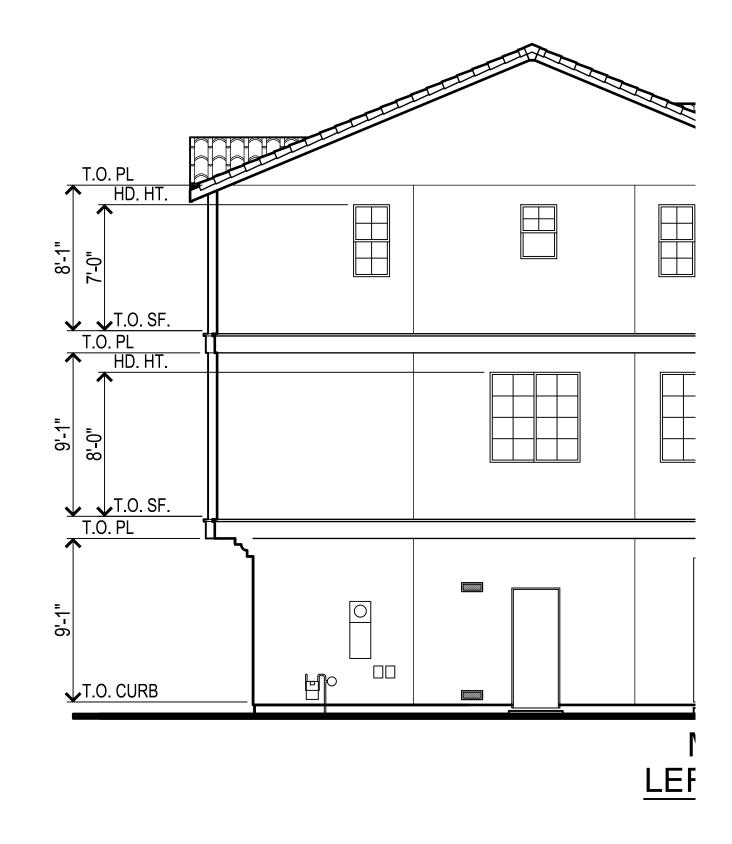


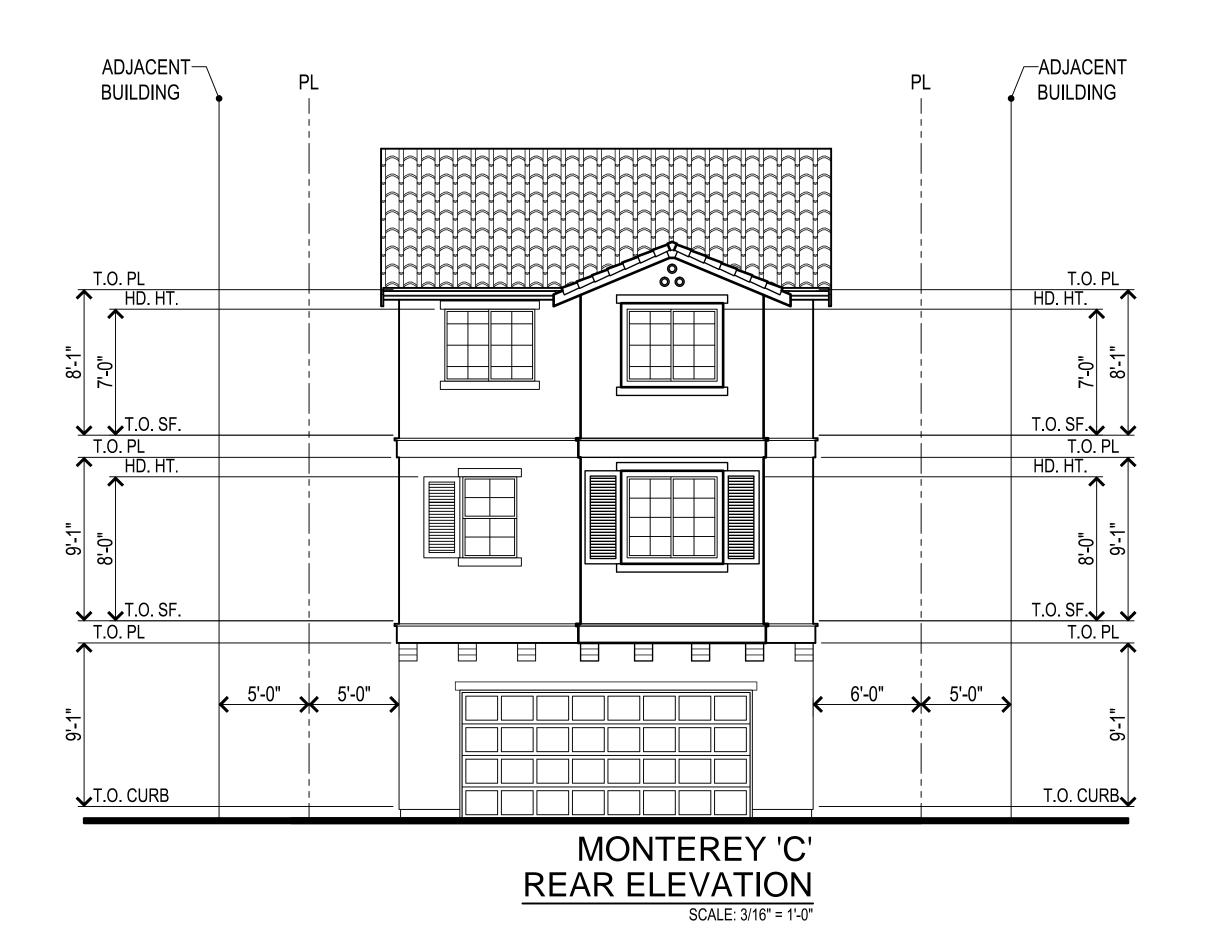


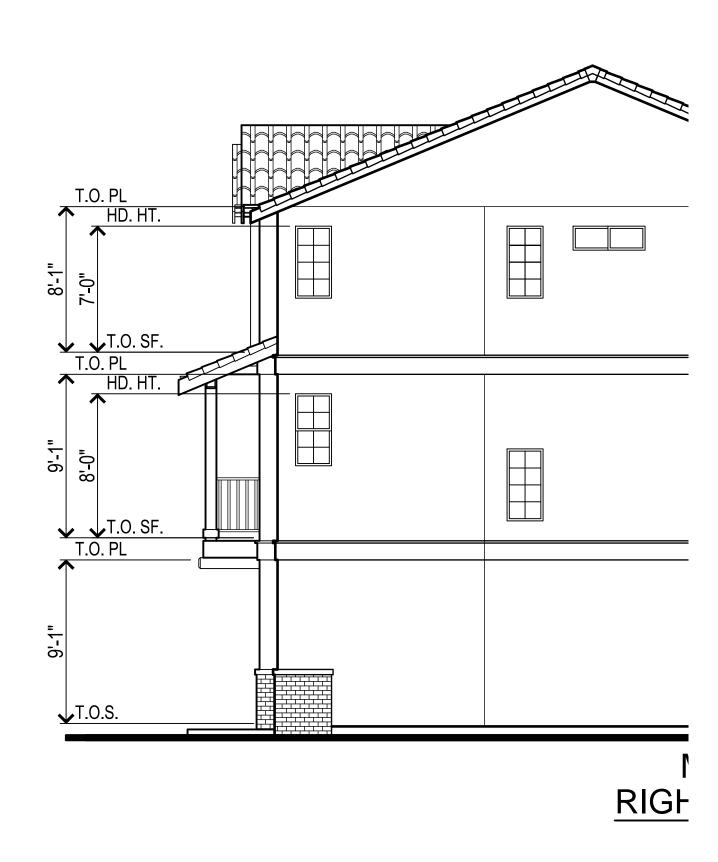


PLAN 1 'C' ELEVATION

Mar 7, 2016

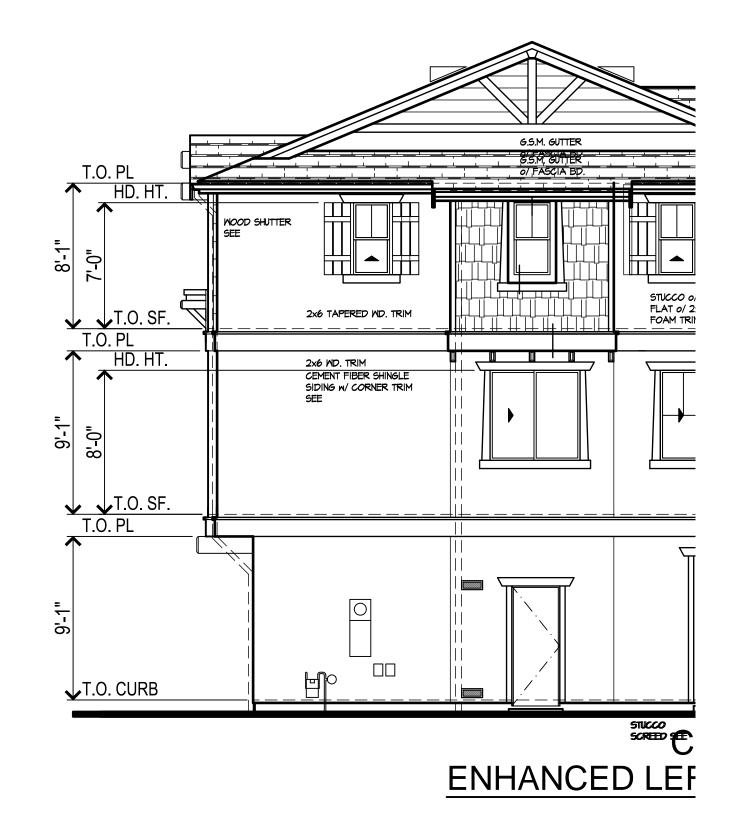


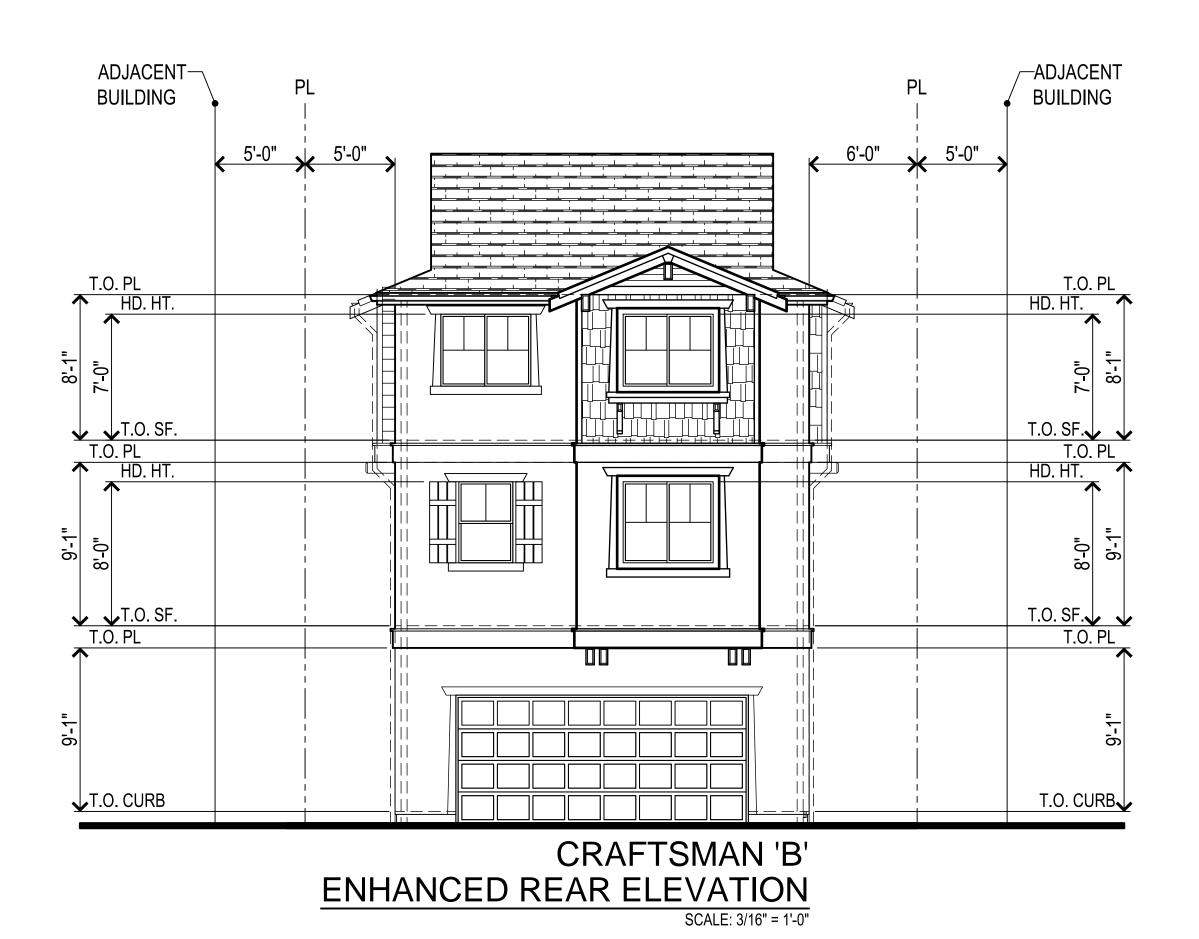

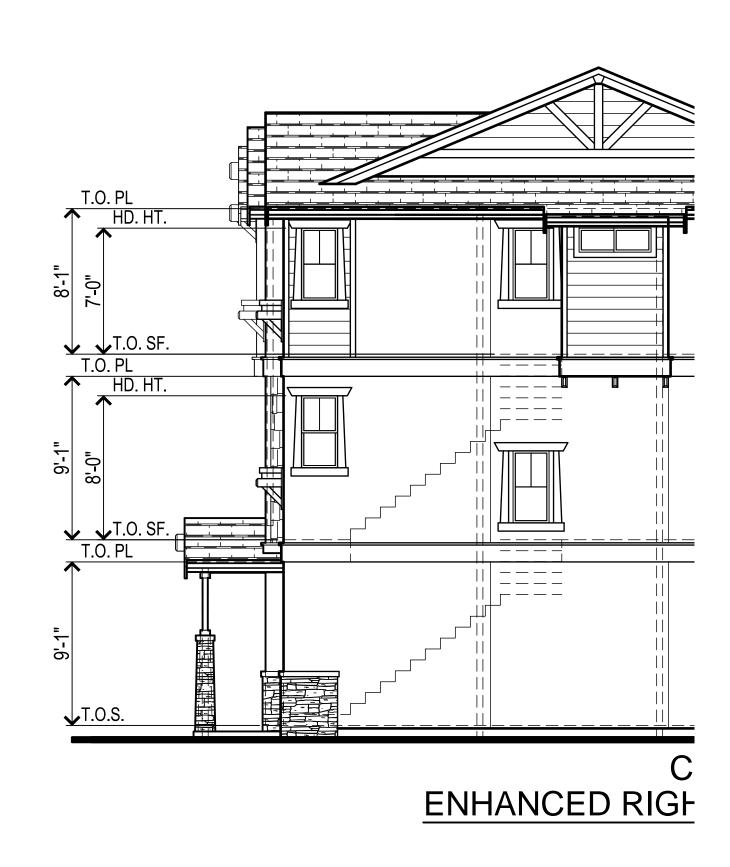



PLAN 1 'B' EN

KBHome

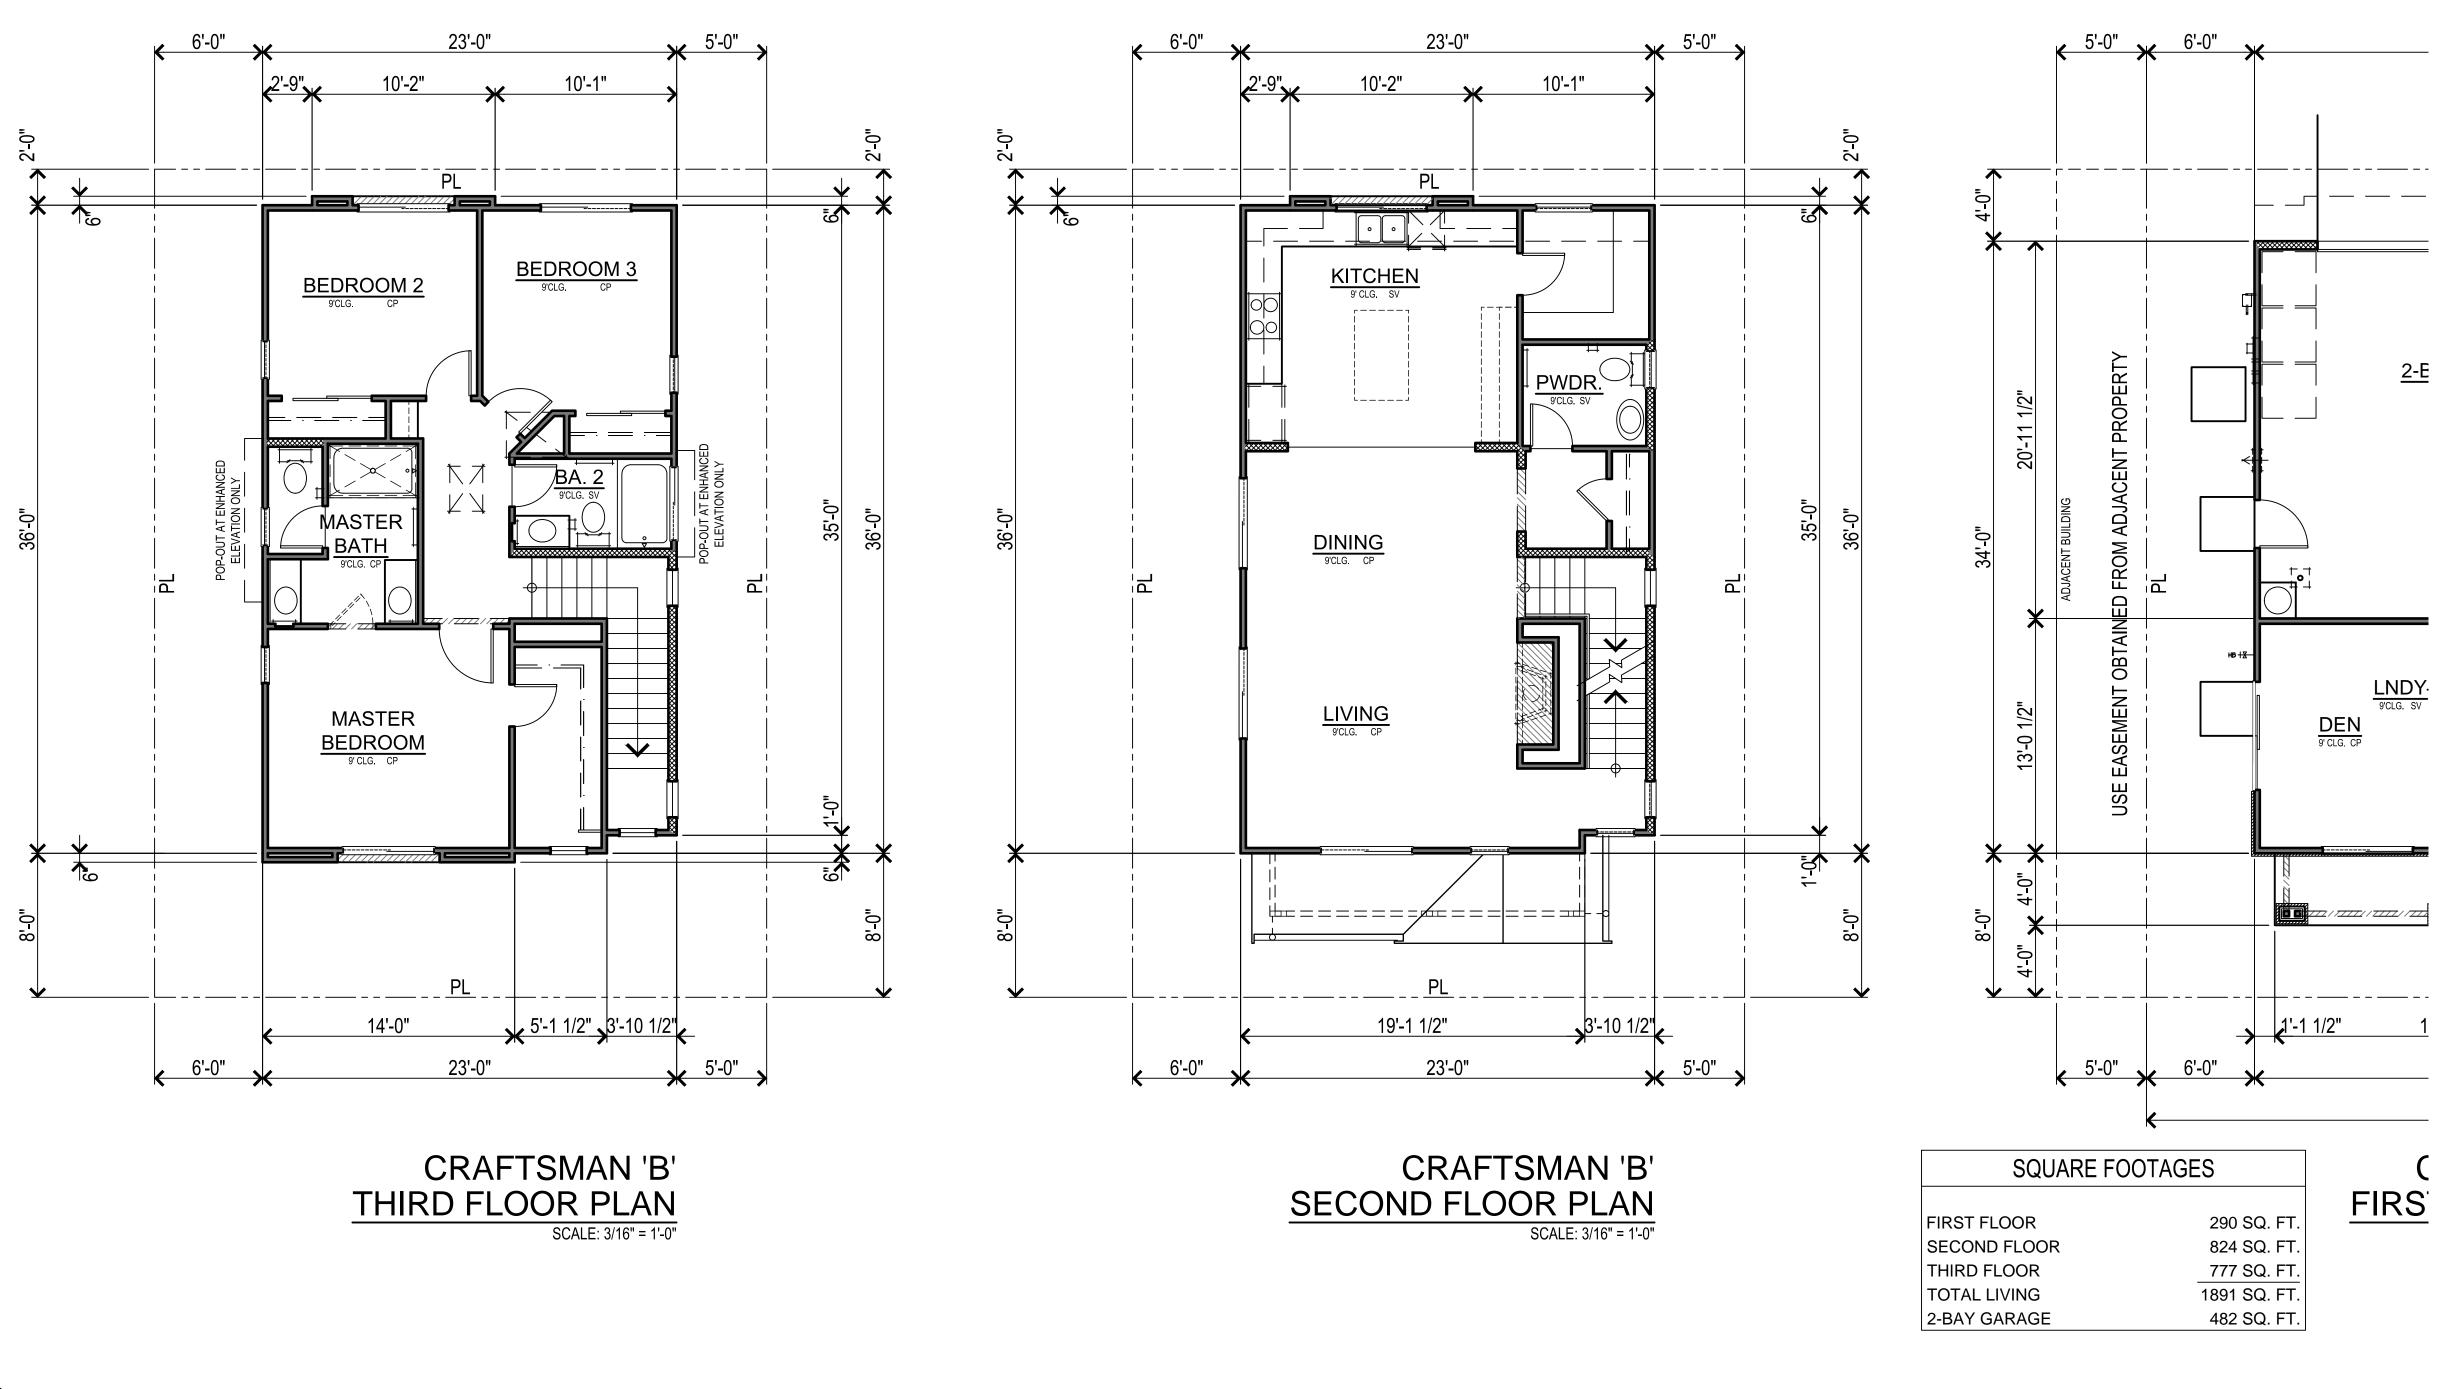

KBHome

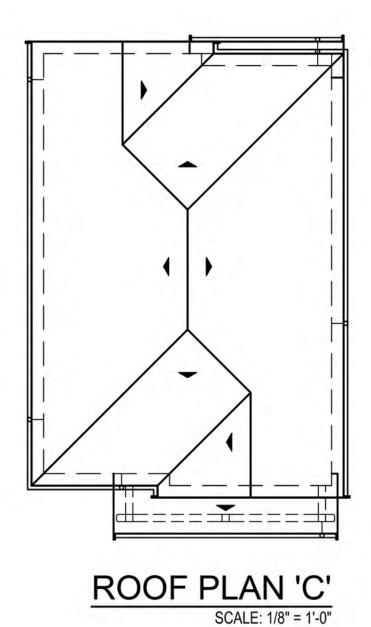

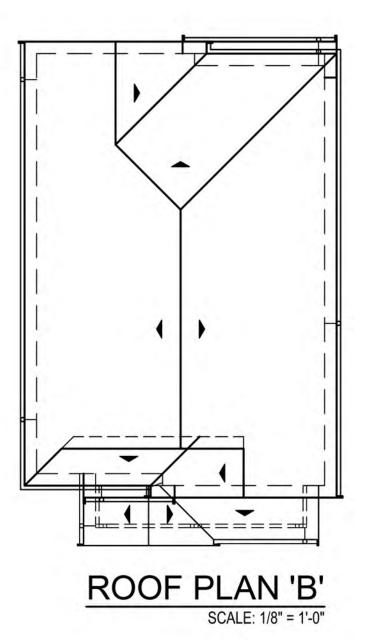

-ADJACENT

BUILDING

T.O. PL HD. HT.

T.O. PL

T.O. PL

T.O.S. 🗸 🗸

GRADE

HD. HT.

OVERALL

RAKE

STUCCO

FINISH


PORCH-


COLUMN

FIBER


CEMENT

SIDING

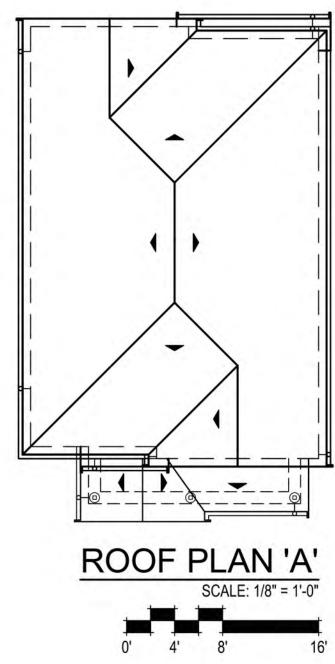

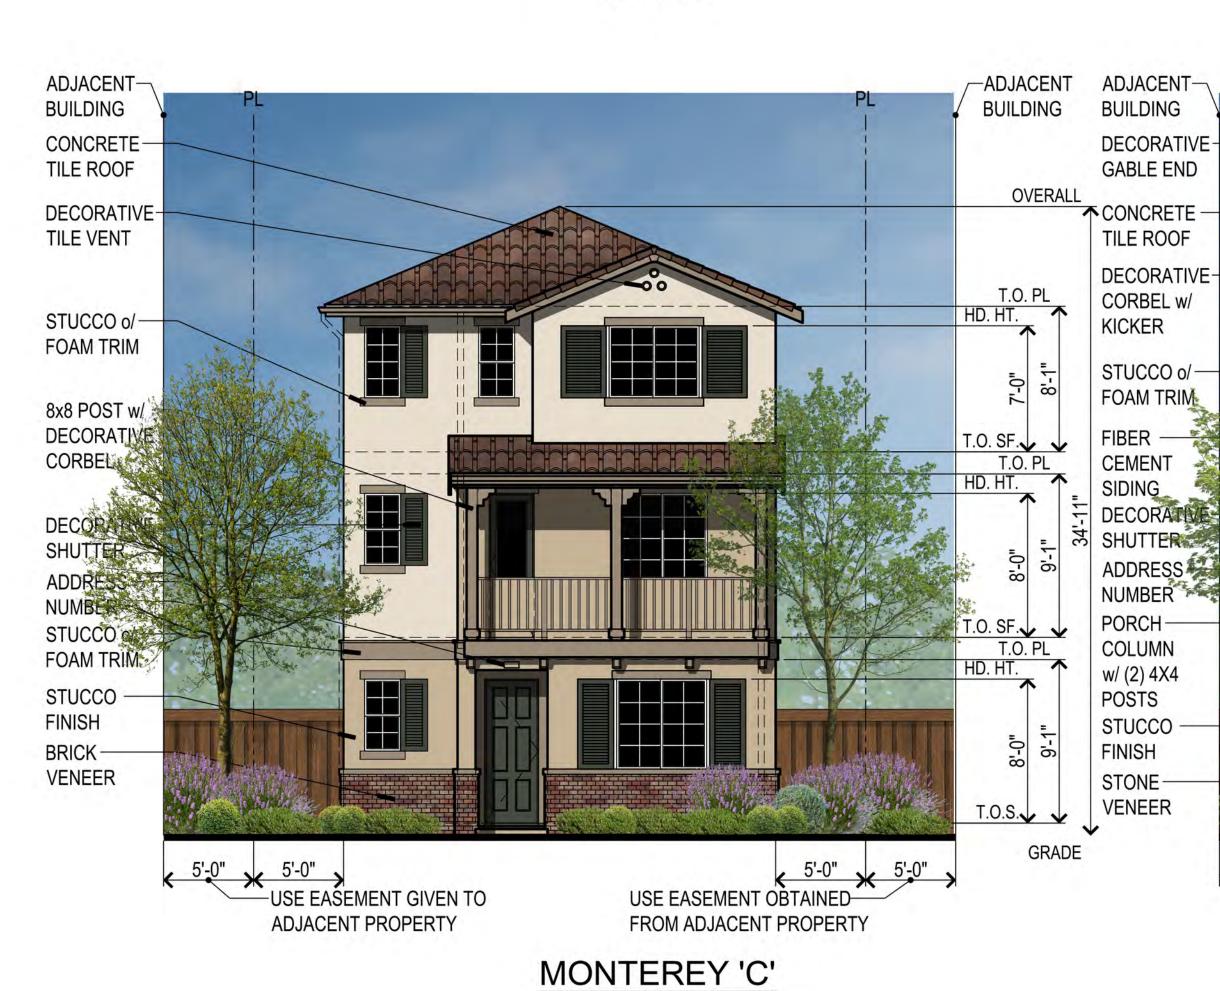

SCALE: 3/16" = 1'-0"

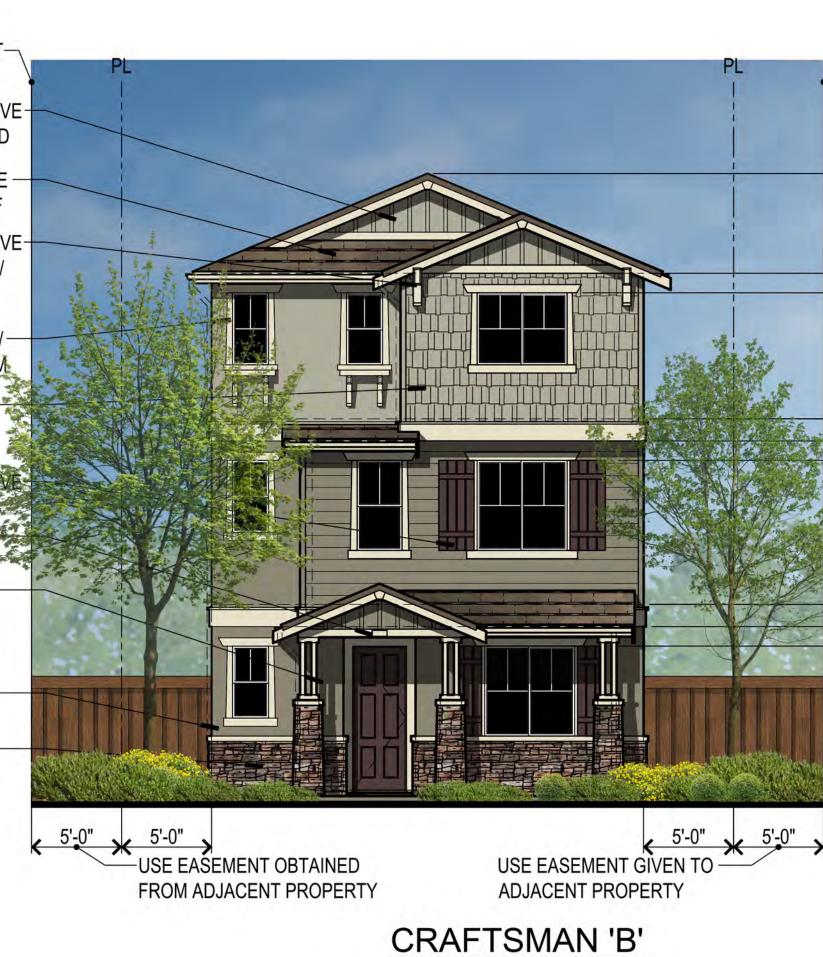

SCALE: 3/16" = 1'-0"

/-ADJACENT ADJACENT-BUILDING BUILDING CONCRETE-TILE ROOF **OVERALL ↑**DECORATIVE **GABLE VENT** DECORATIVE **EXTENSION** STUCCO o/-FOAM TRIM T.O. SF. T.O. PL 8'-0" 9'-1" T.O.S. 🗸 🗸 GRADE USE EASEMENT GIVEN TO 5'-0" × 5'-0" > USE EASEMENT OBTAINED FROM ADJACENT PROPERTY ADJACENT PROPERTY


> CAPE COD 'A' SCALE: 3/16" = 1'-0"


Amaral City of Hayward Mar 7, 2016


KBHome

PLAN 2 FRONT ELEVATIONS & ROOF PLANS

Page 26 of 46

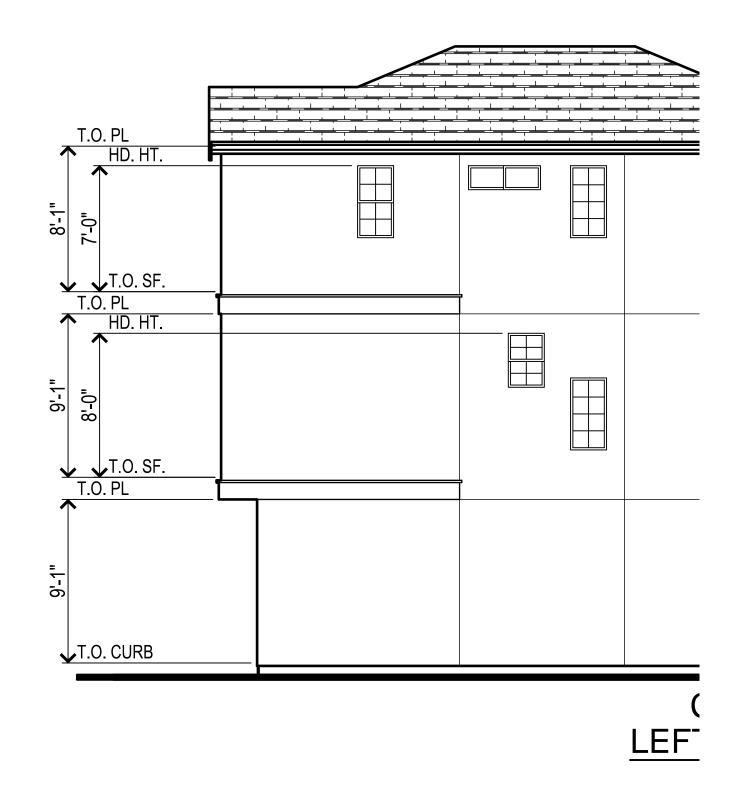


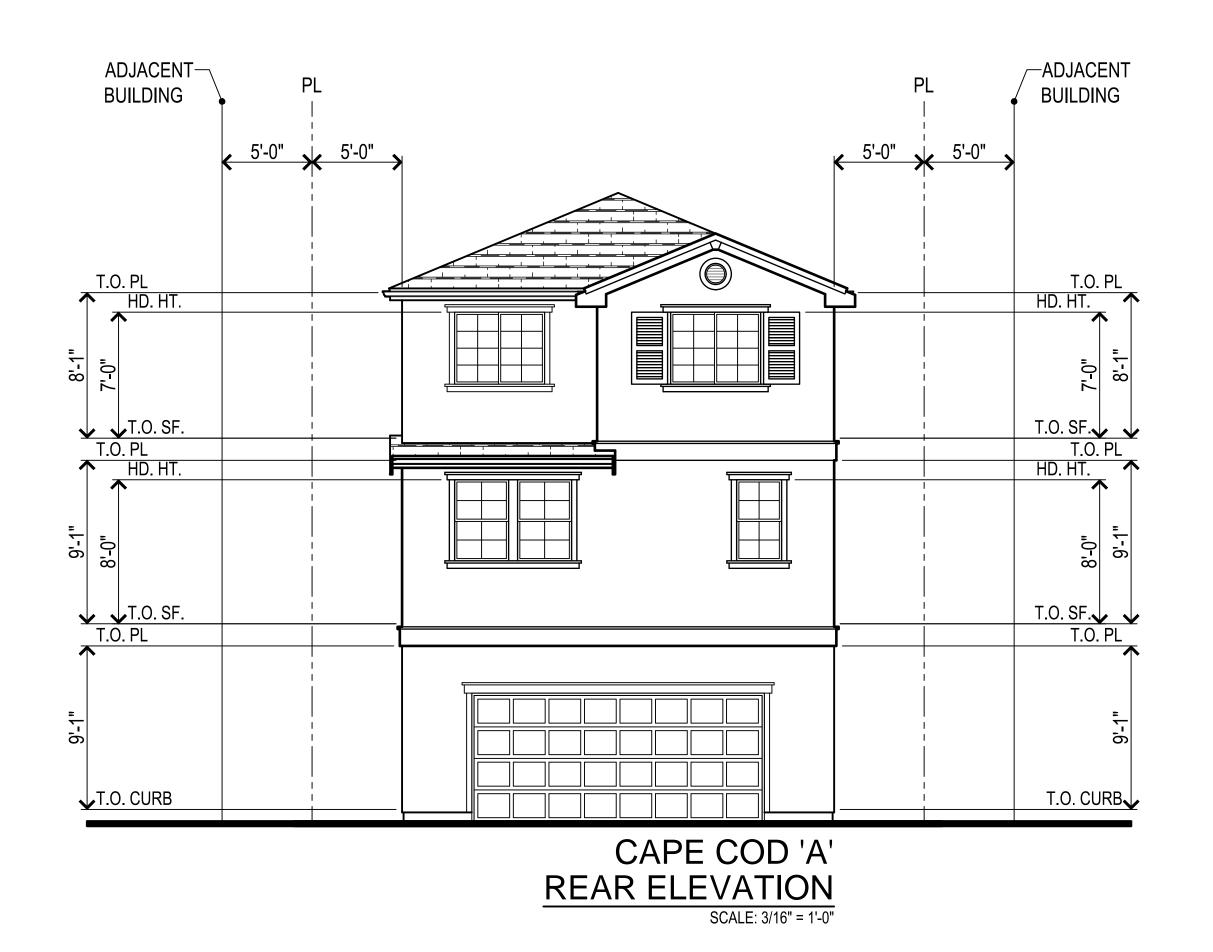


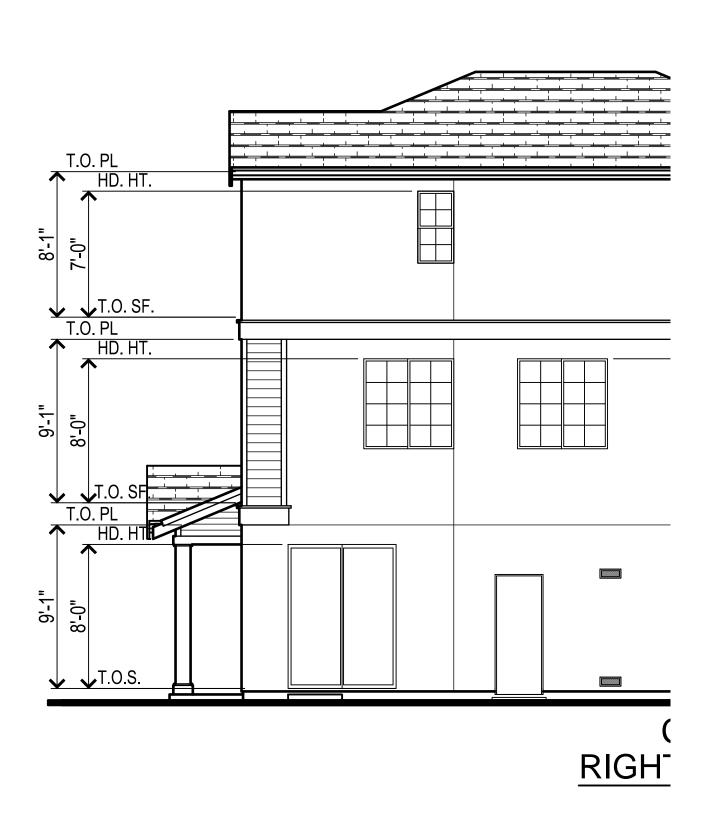


PLAN 2 'A' ELEVATION

KBHome

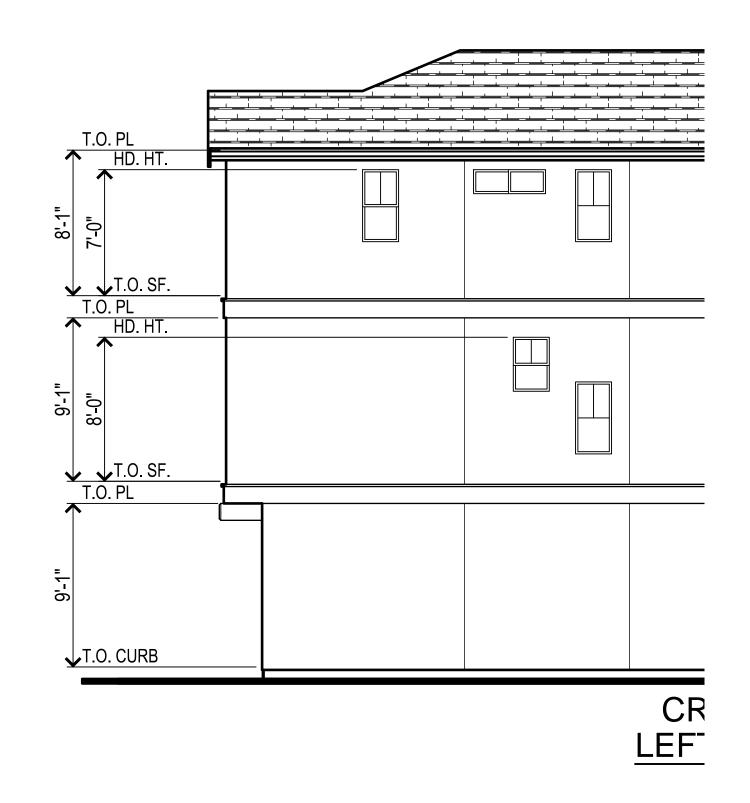


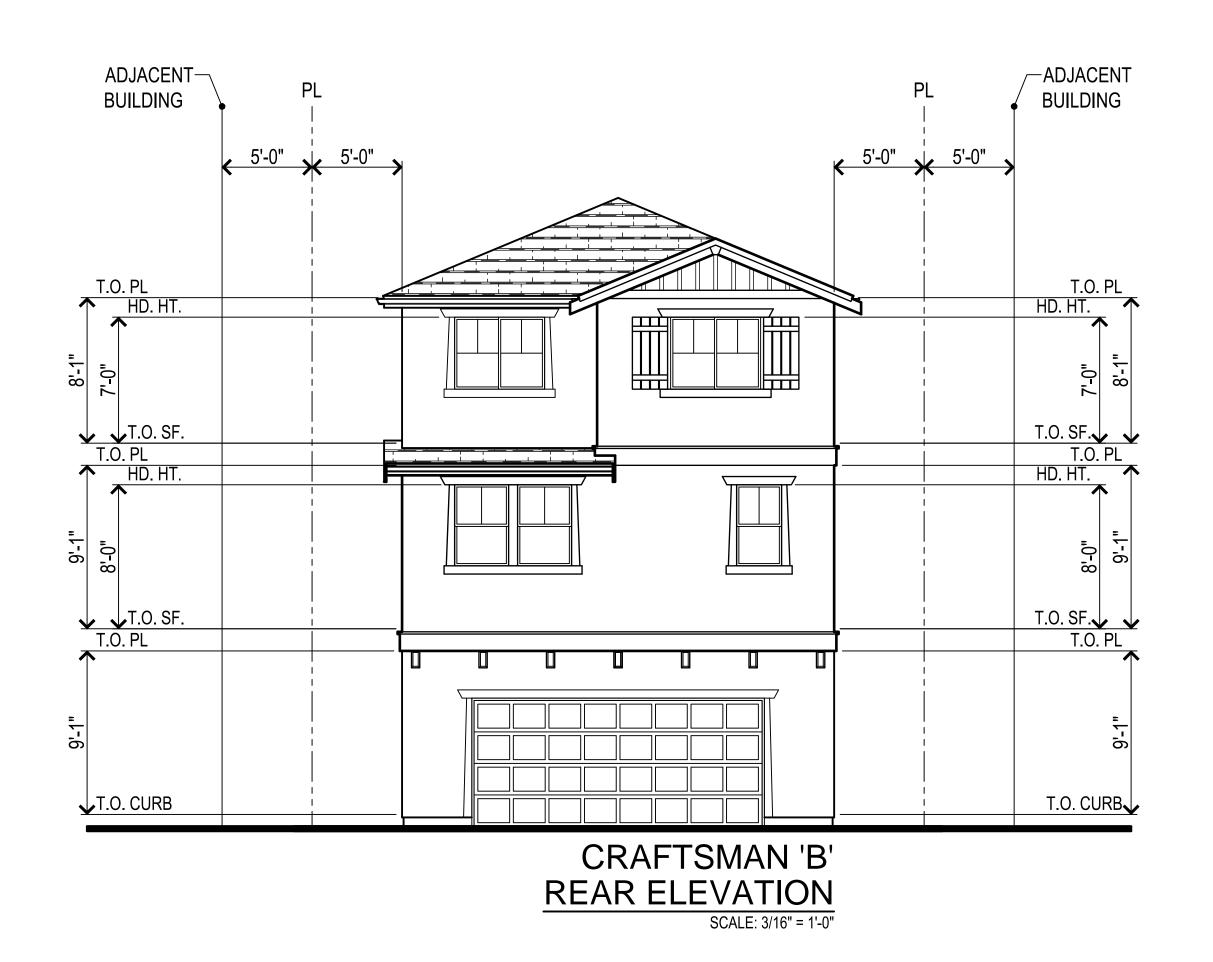


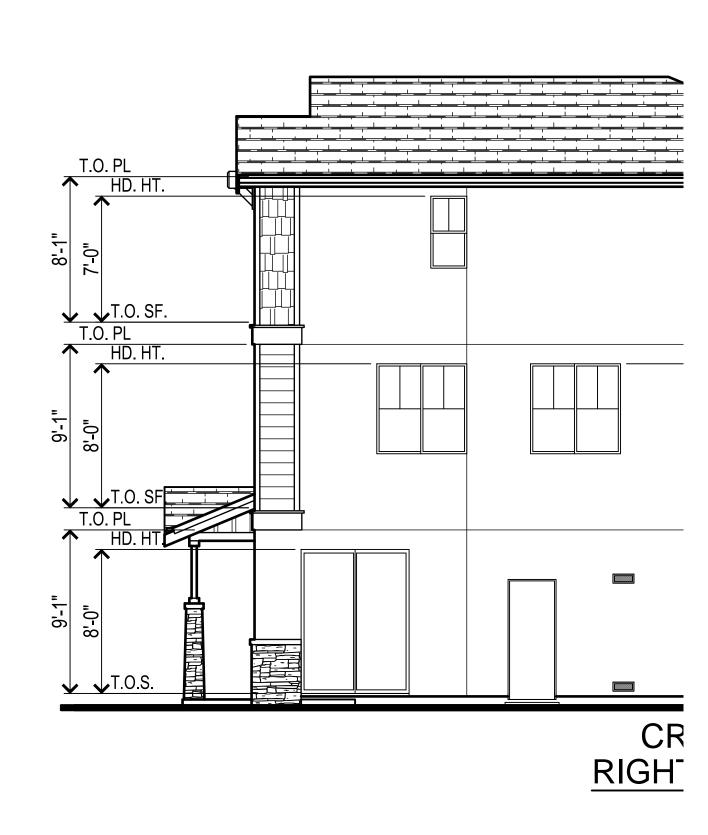


PLAN 2 'B' ELEVATION


K B H o m e

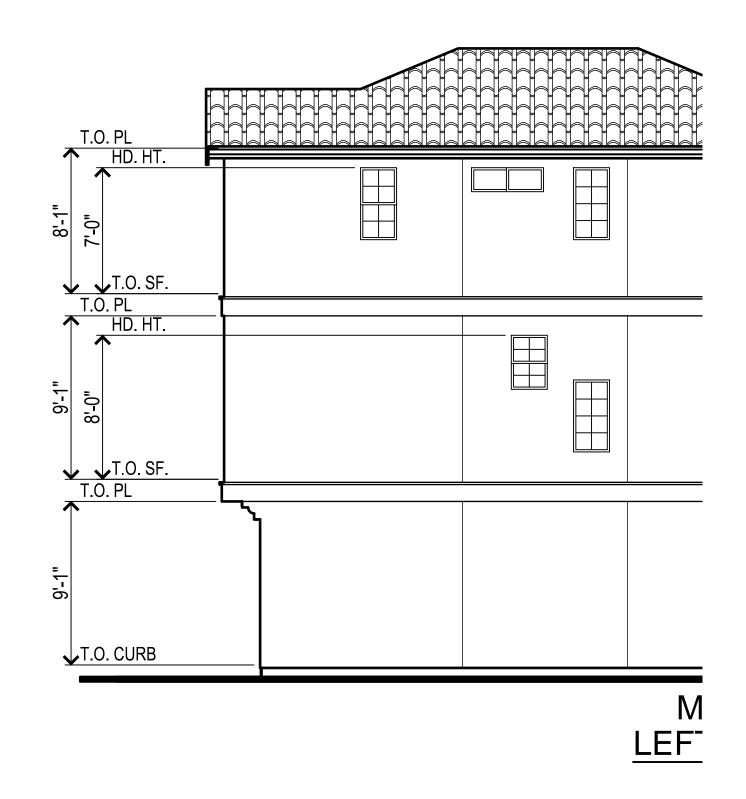

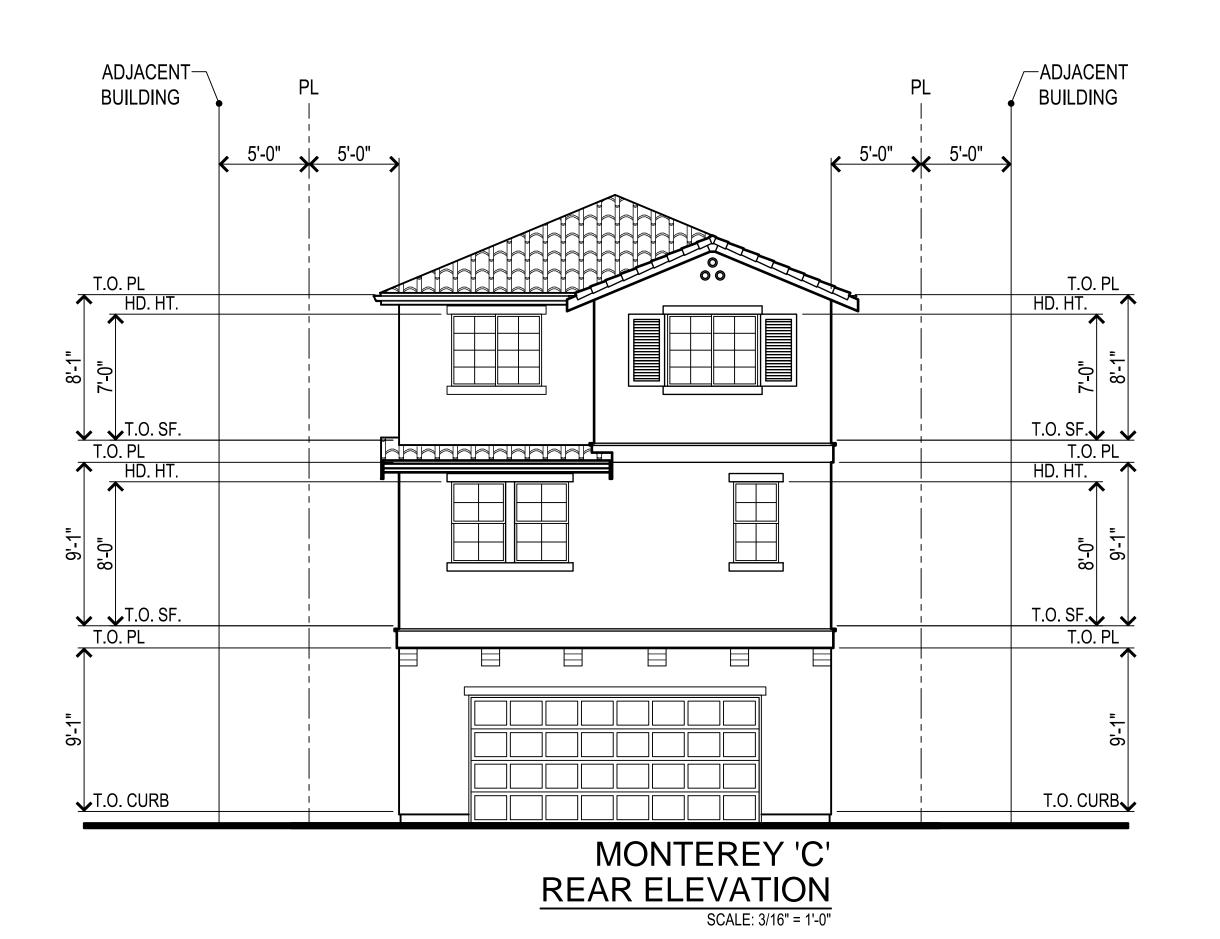


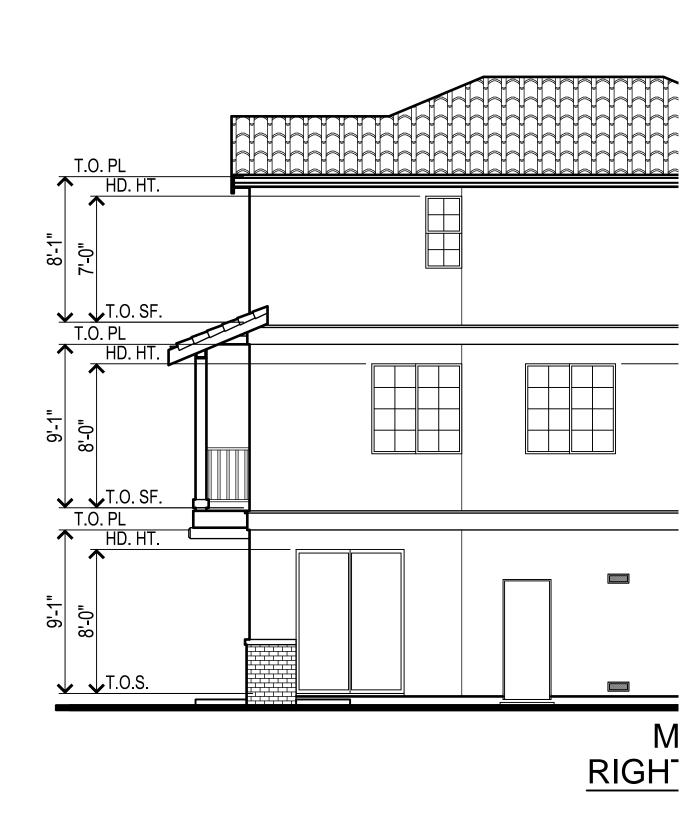


PLAN 2 'C' ELEVATION

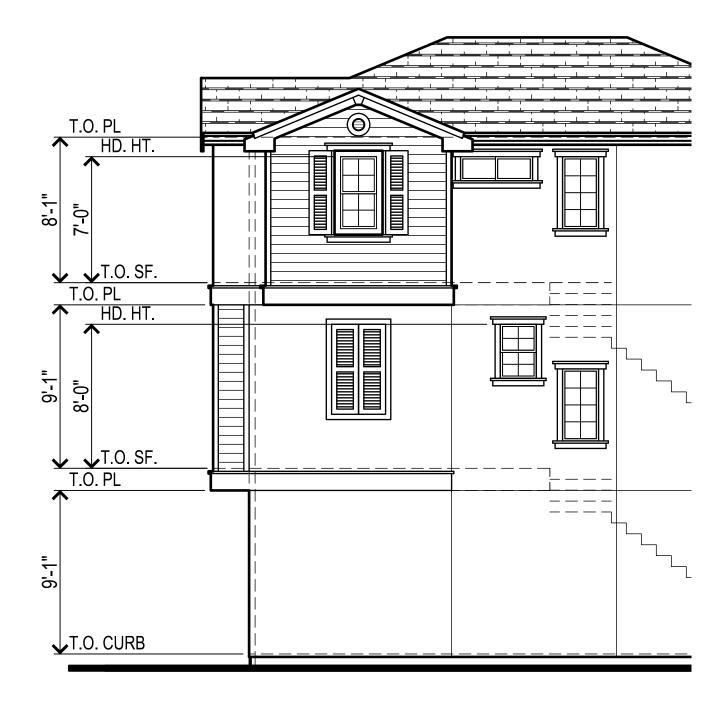

ENHANCED LEF

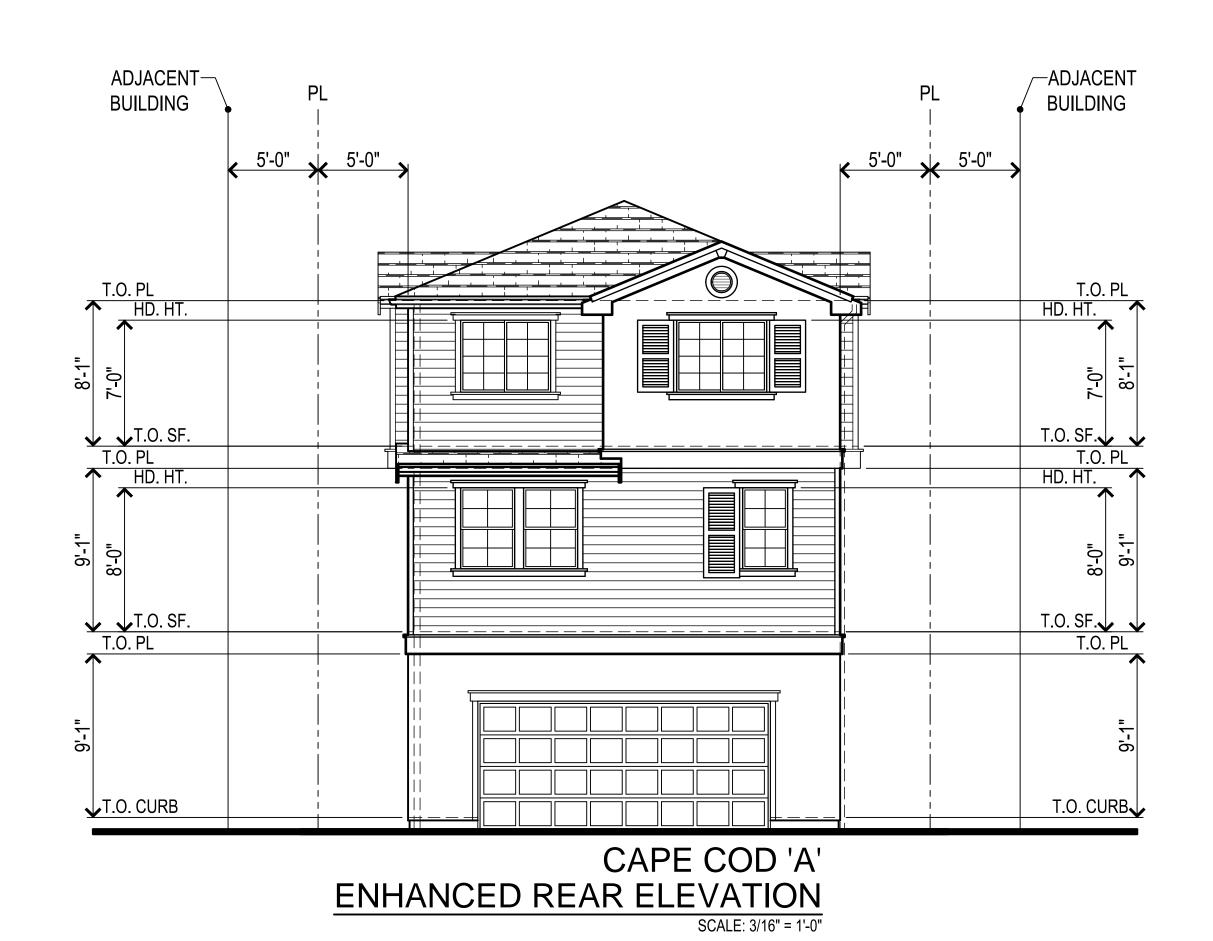

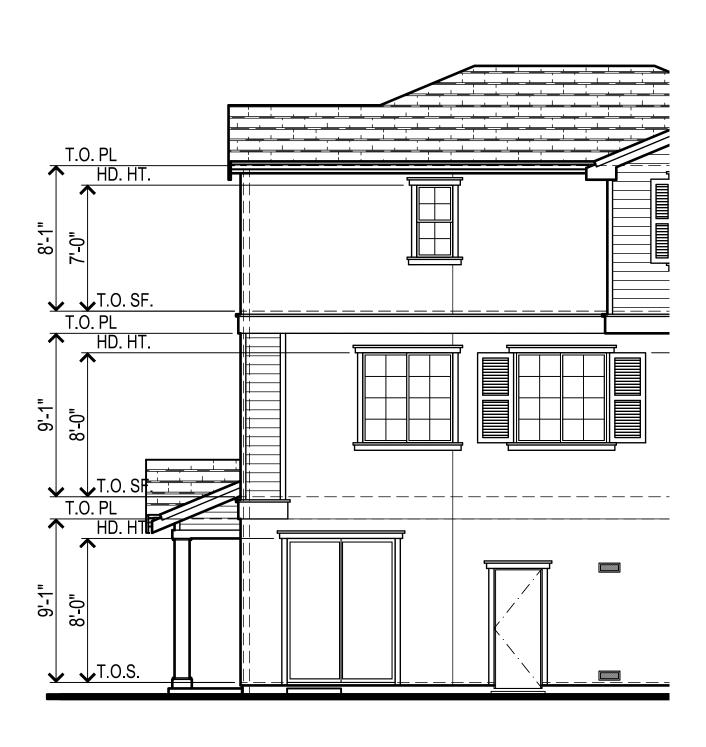


ENHANCED RIGH


Amaral
City of Hayward
Mar 7, 2016


PLAN 2 'A' EN

KBHome

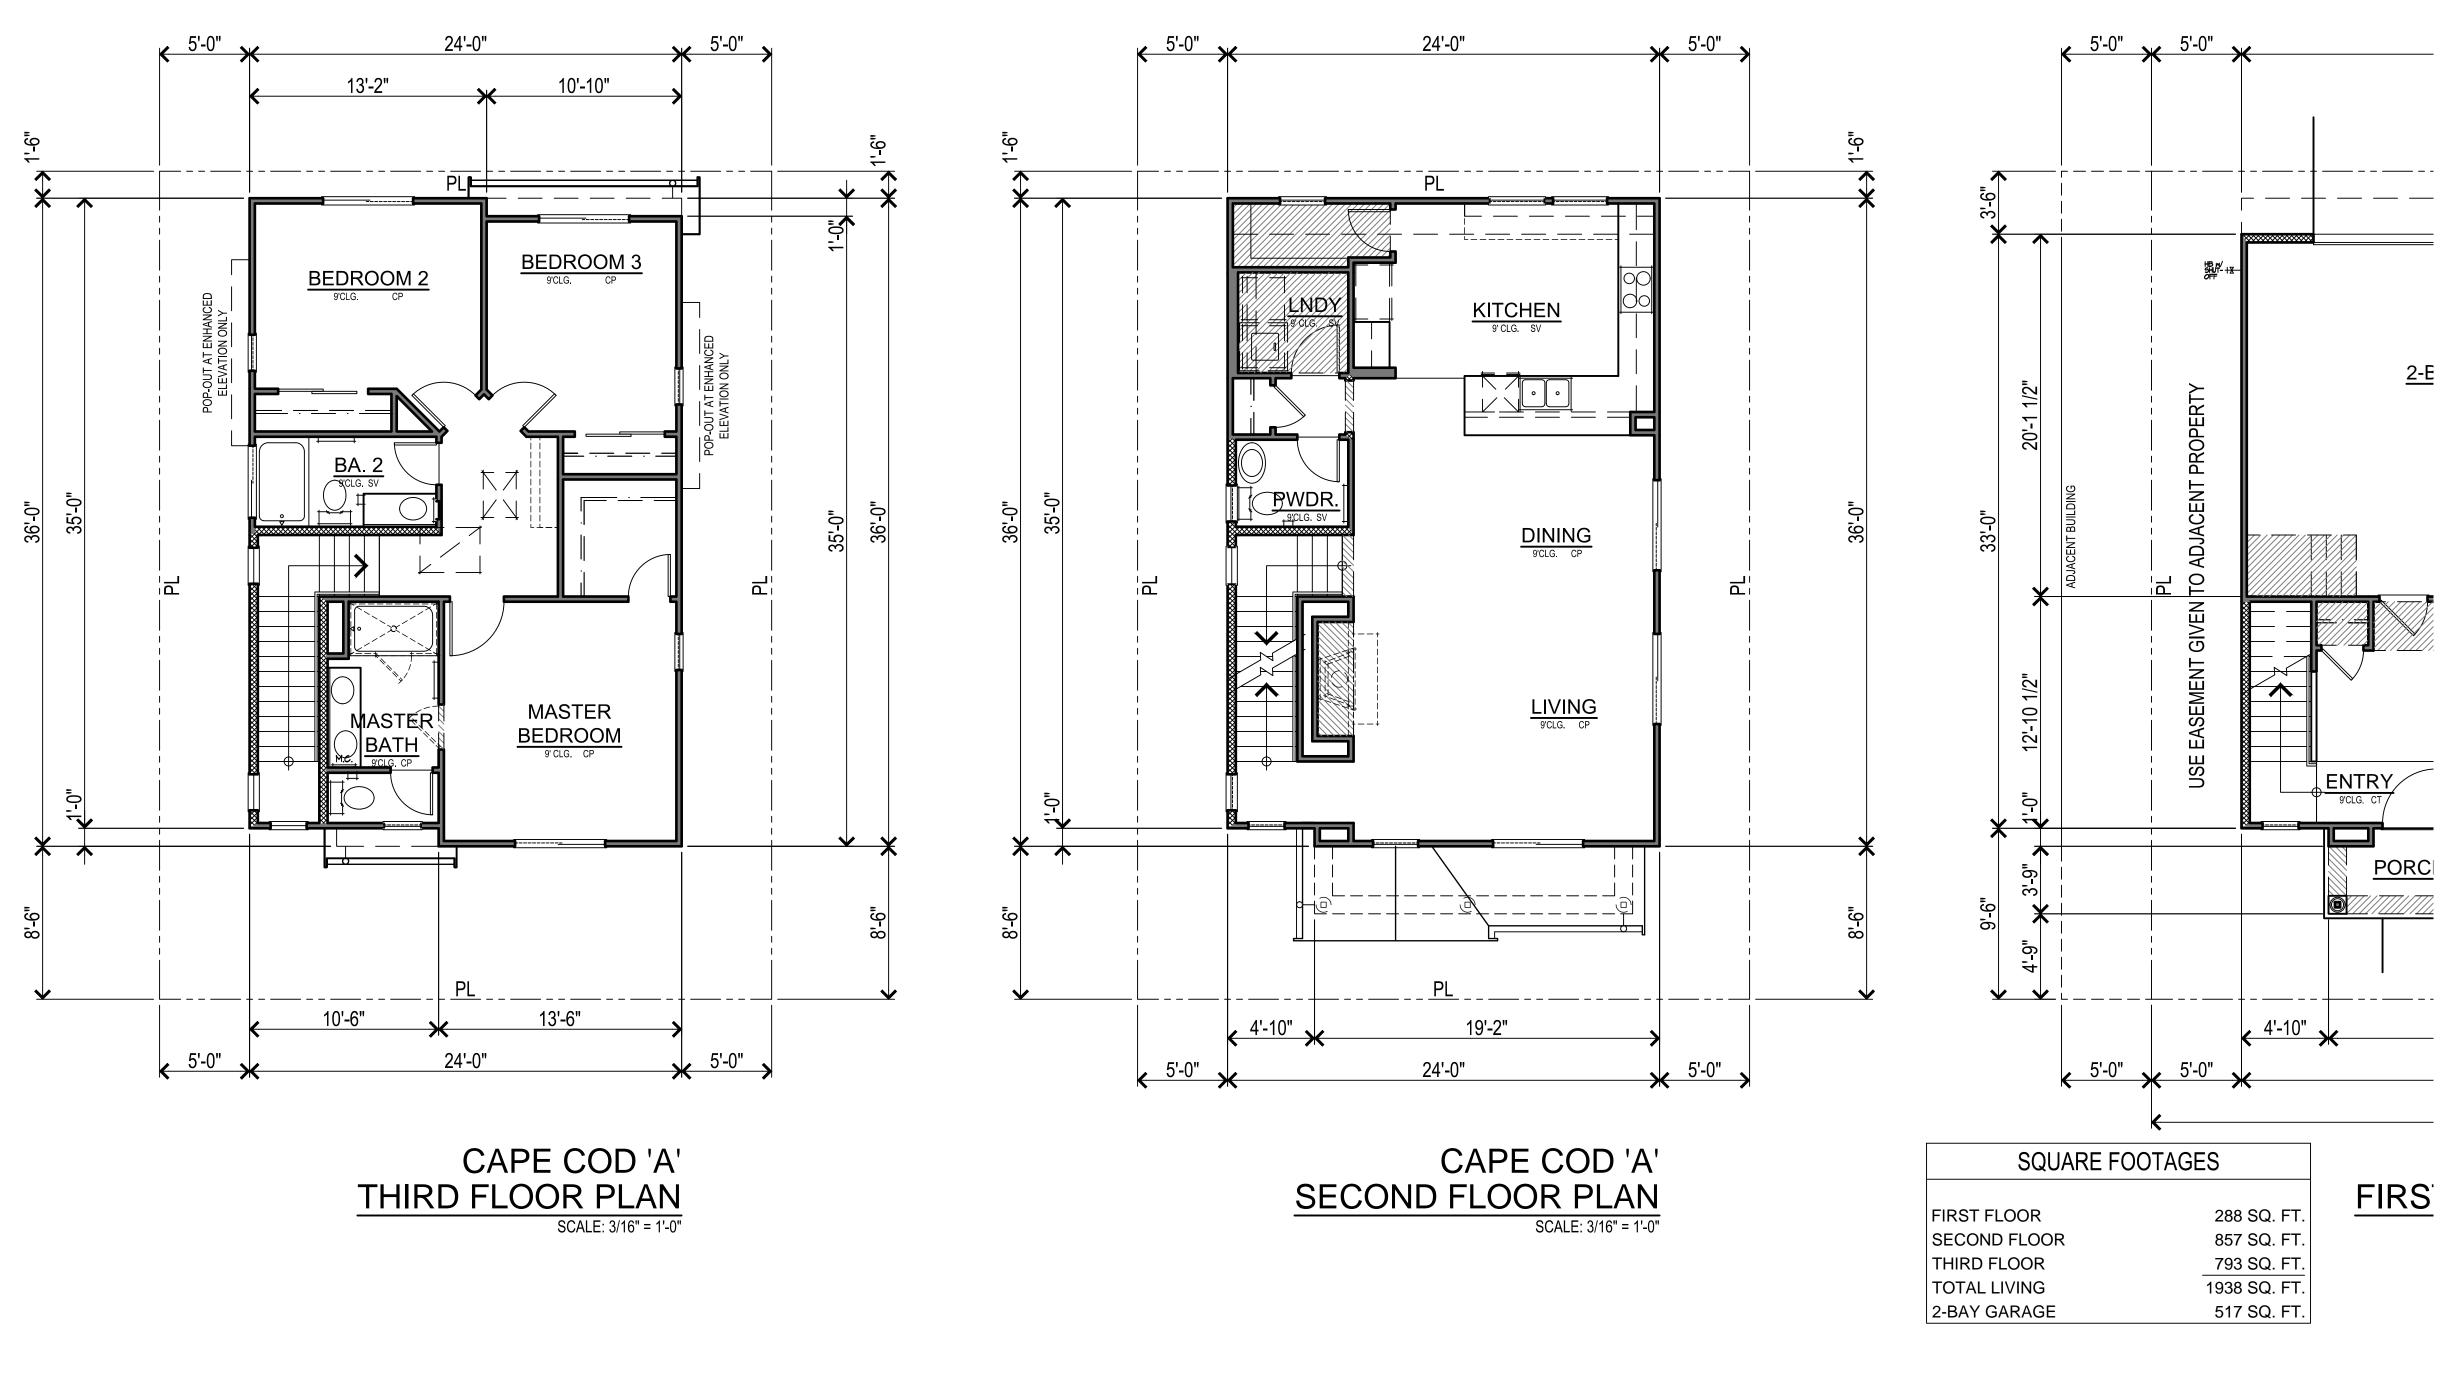

KBHome

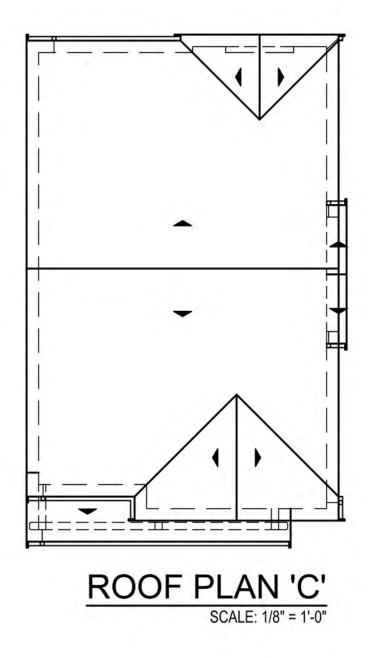

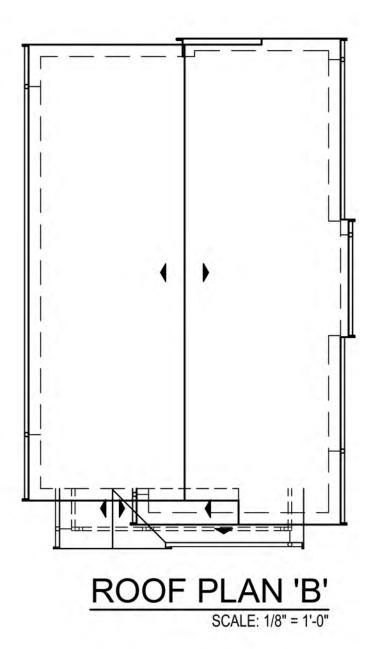

- ADJACENT

BUILDING

OVERALL

7'-0"

T.O. PL

T.O. PL

GRADE

BUILDING

TILE ROOF

RAKE

WOOD TRU


PORCH


FIBER

CEMENT

SIDING


COLUMN

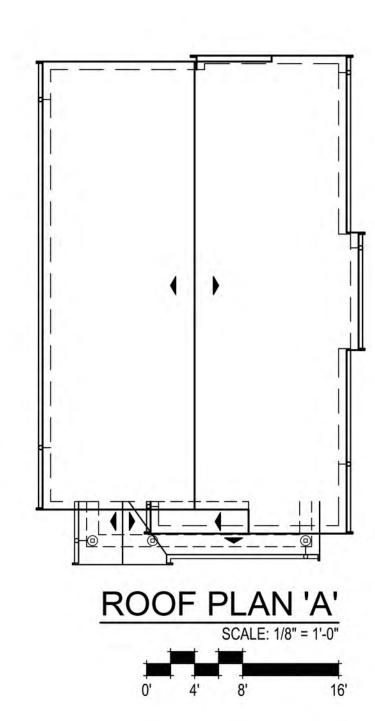

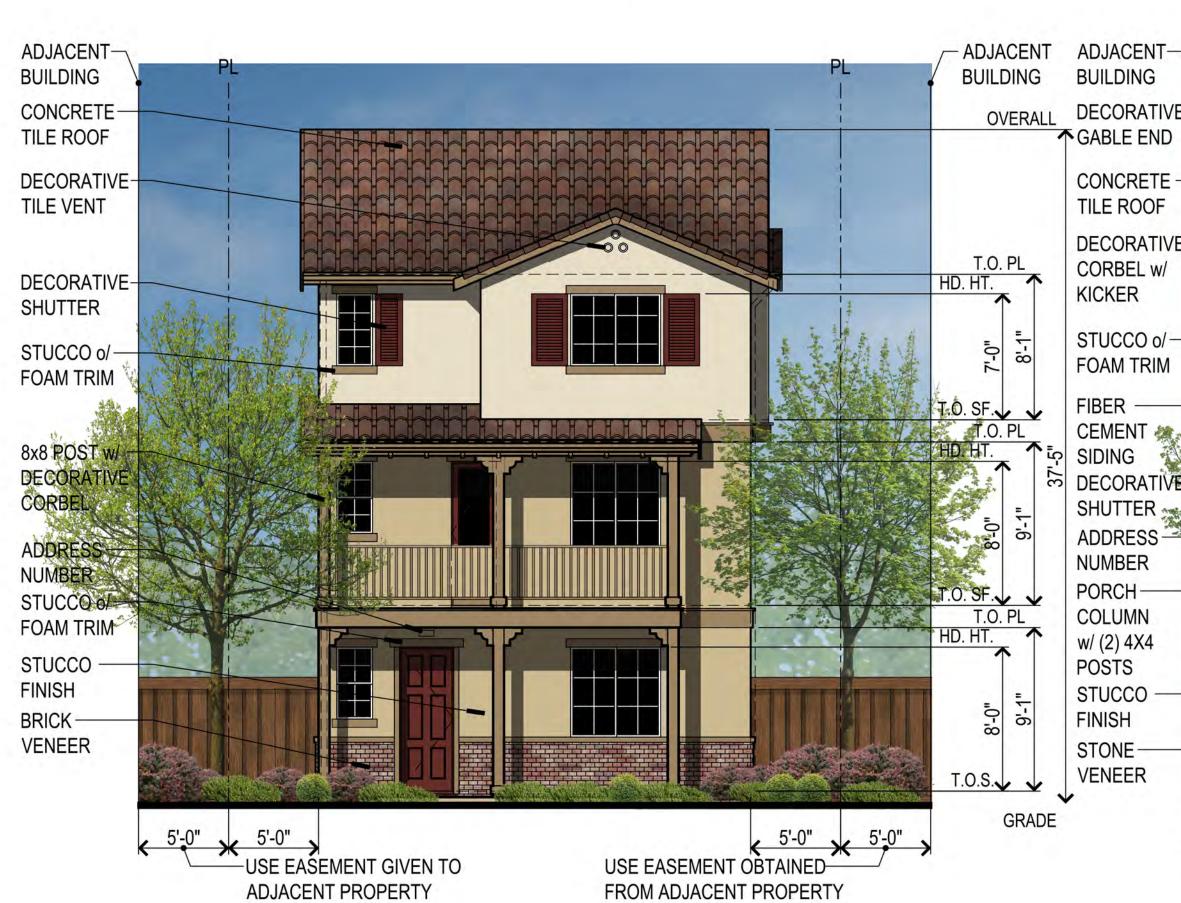


MONTEREY 'C'

SCALE: 3/16" = 1'-0"

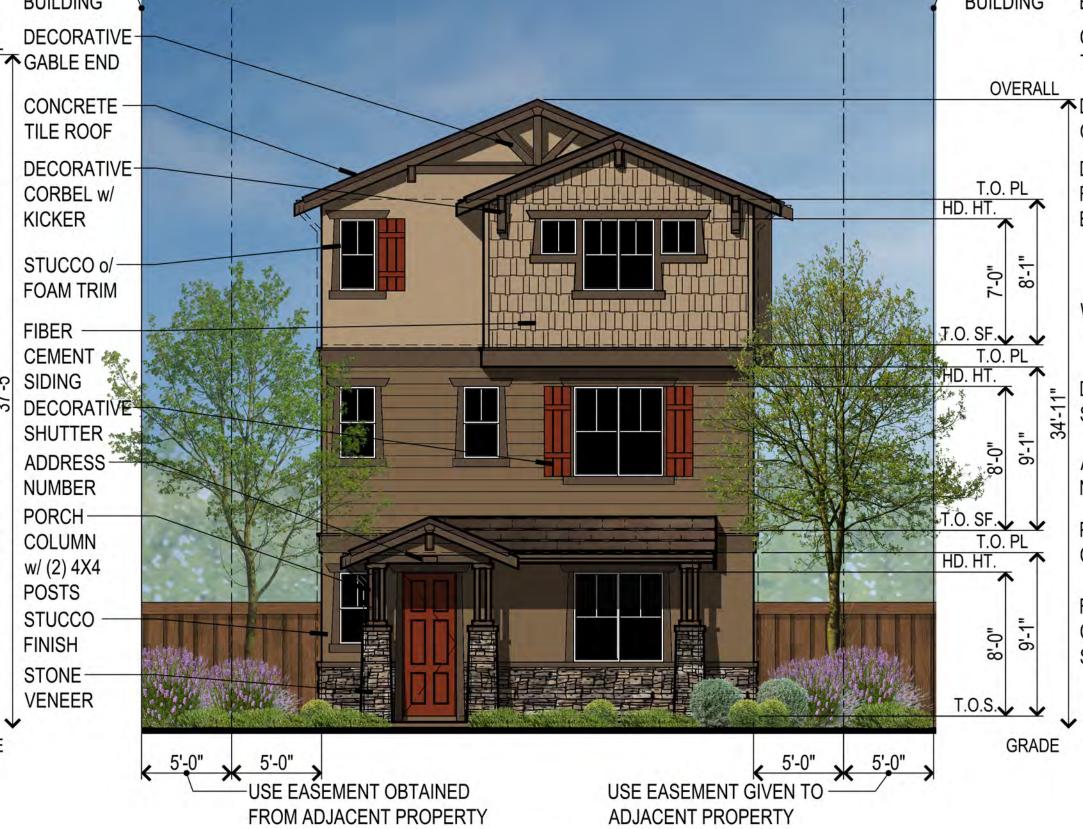

CRAFTSMAN 'B'

SCALE: 3/16" = 1'-0"

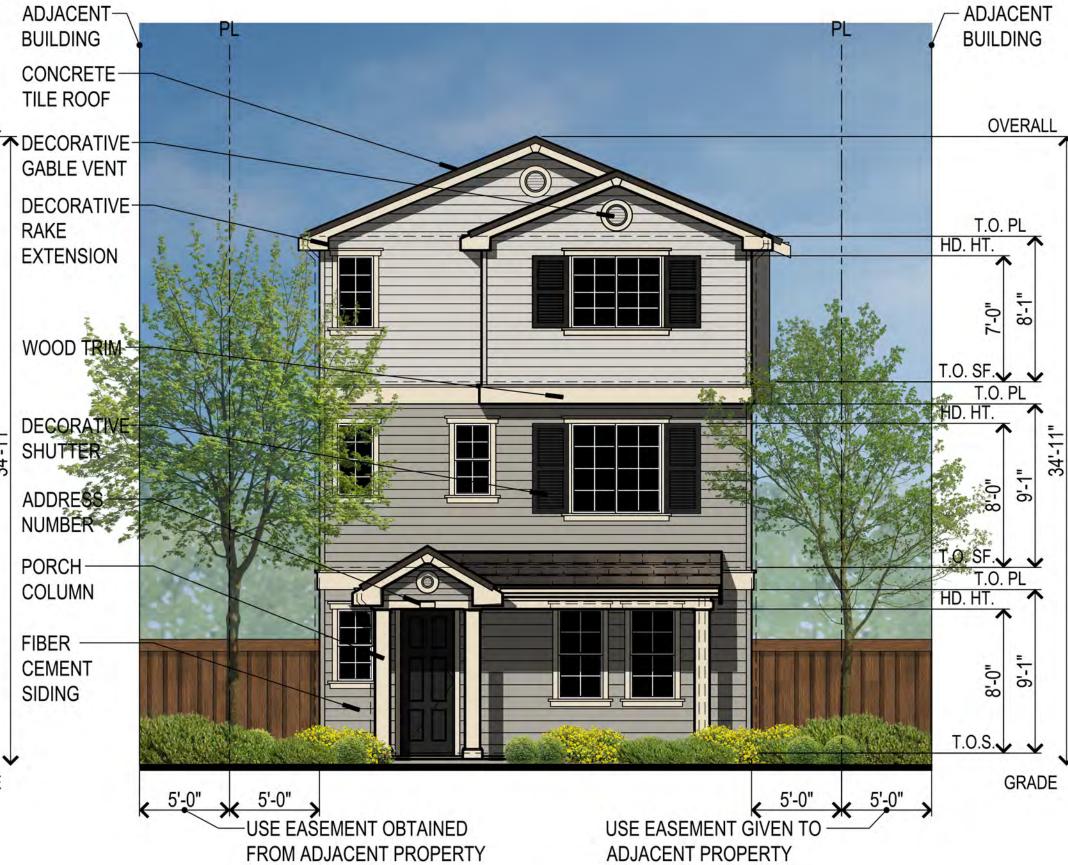


CAPE COD 'A'


SCALE: 3/16" = 1'-0"


Amaral City of Hayward Mar 7, 2016

PLAN 3 FRONT ELEVATIONS & ROOF PLANS

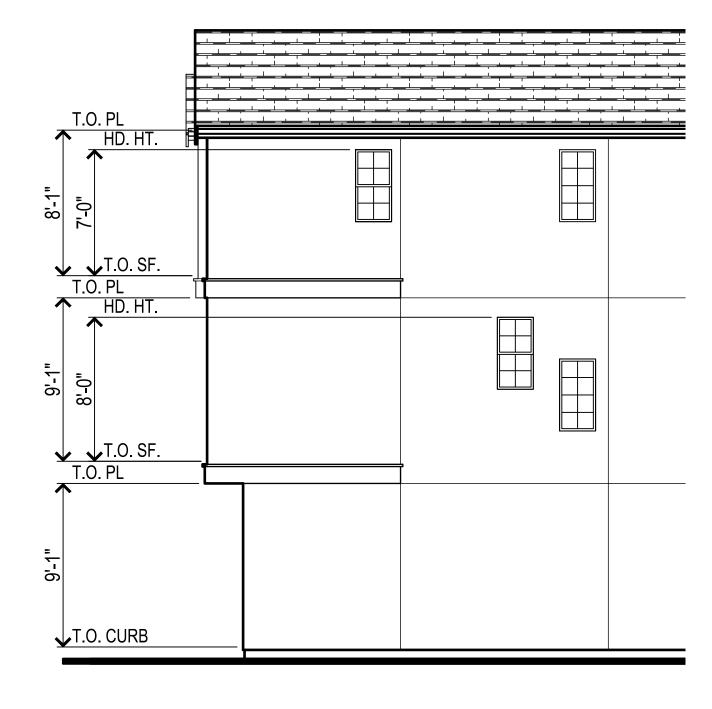

<u>LEF</u>

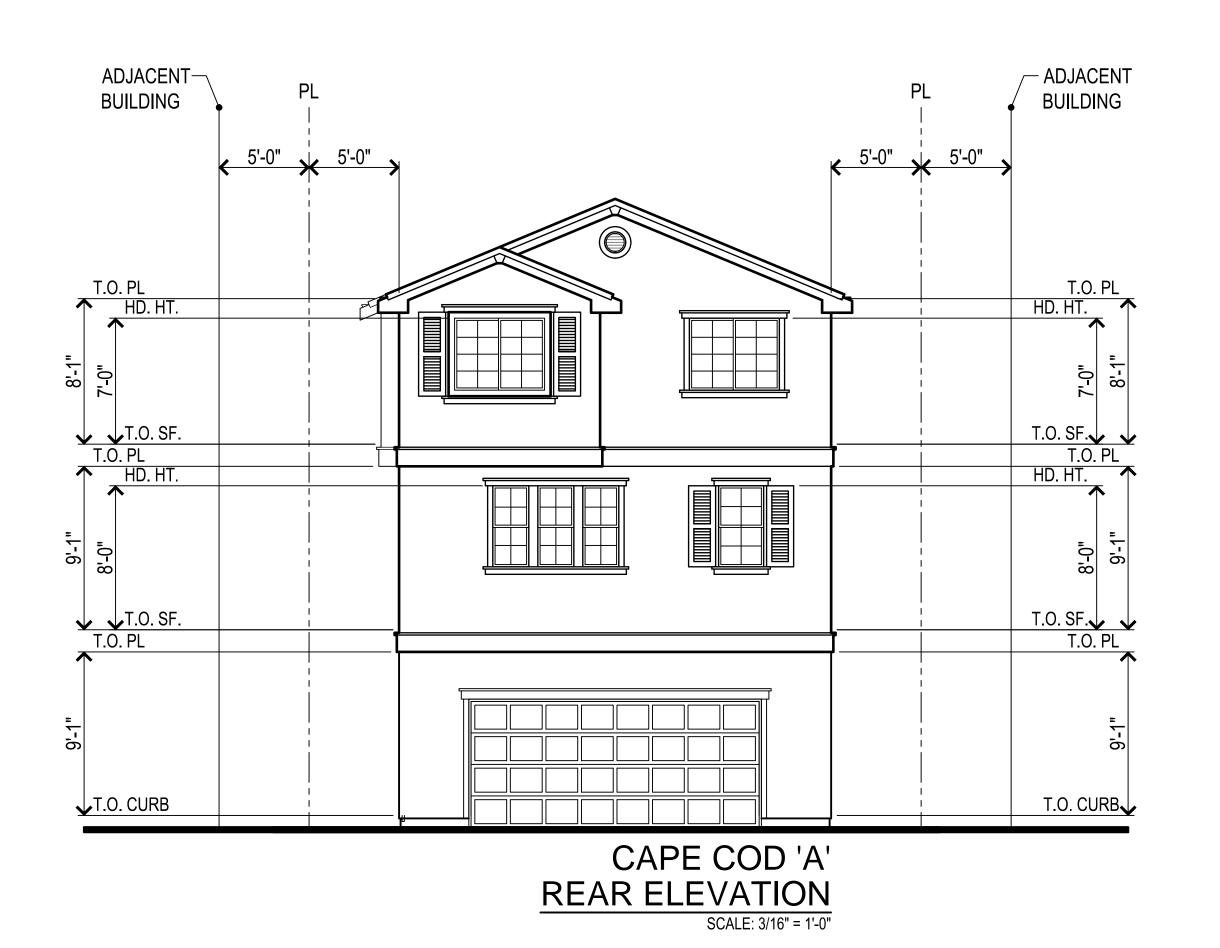

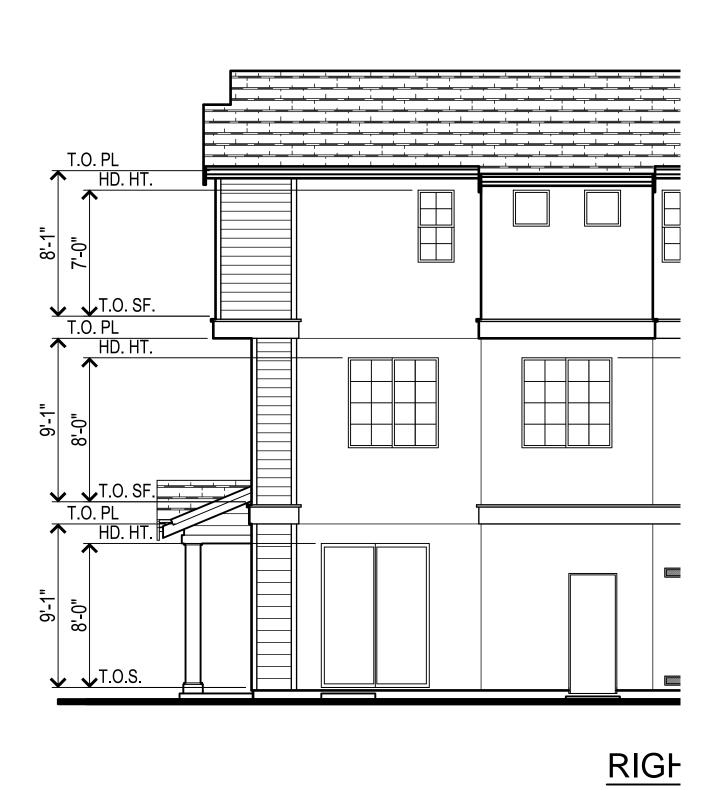



Amaral


City of Hayward
Mar 7, 2016

PLAN 3 'A' ELEVATION

KBHome

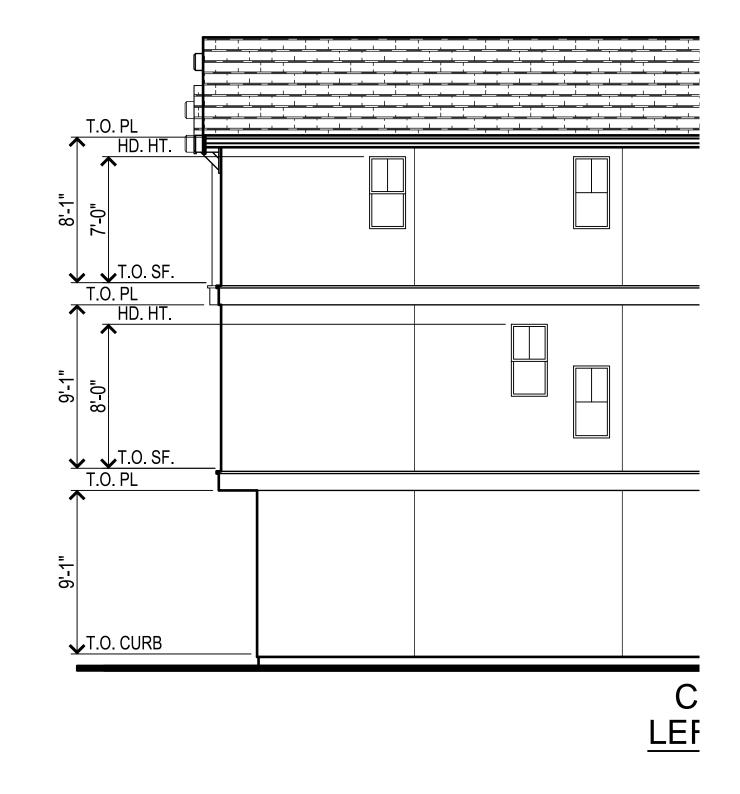


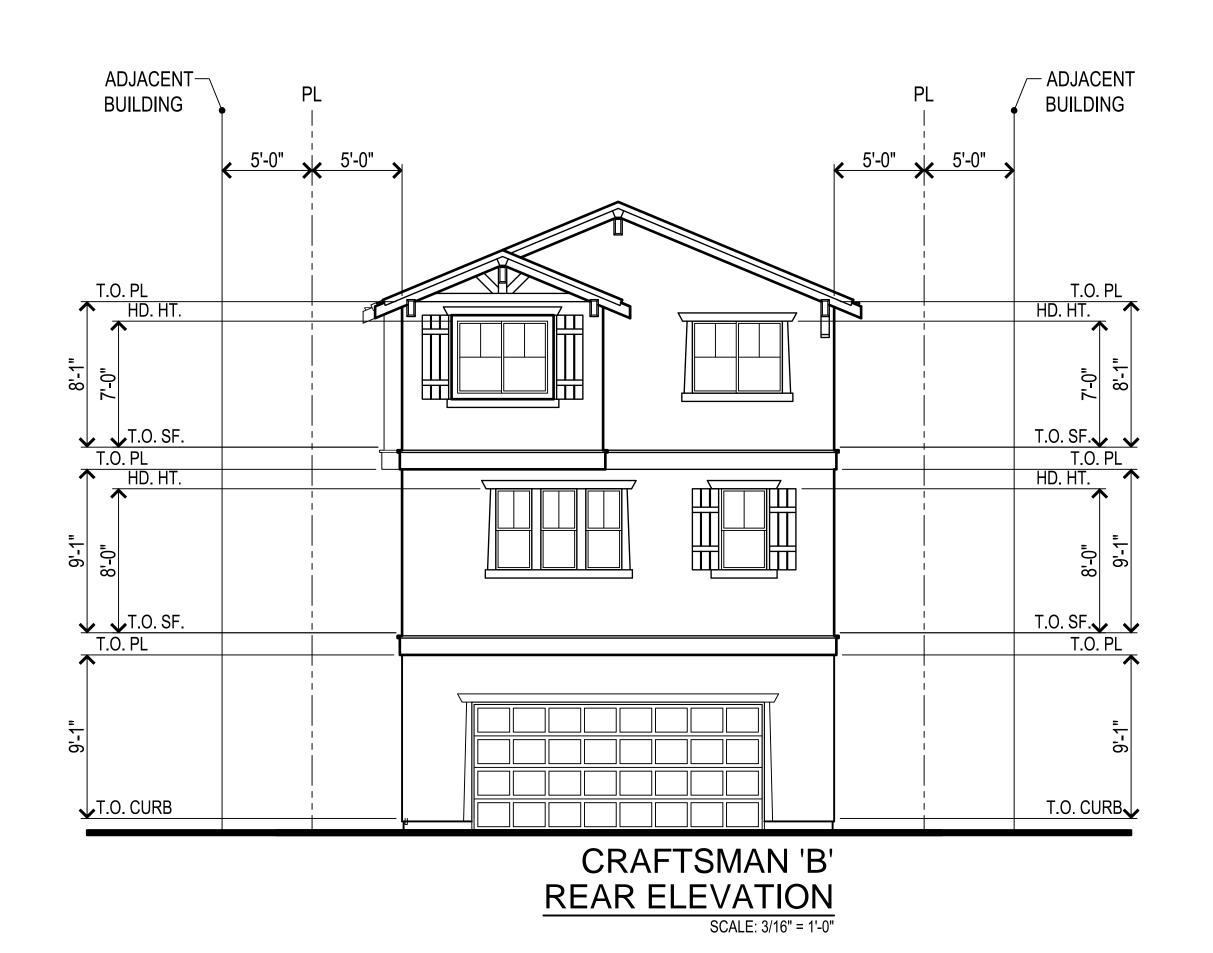


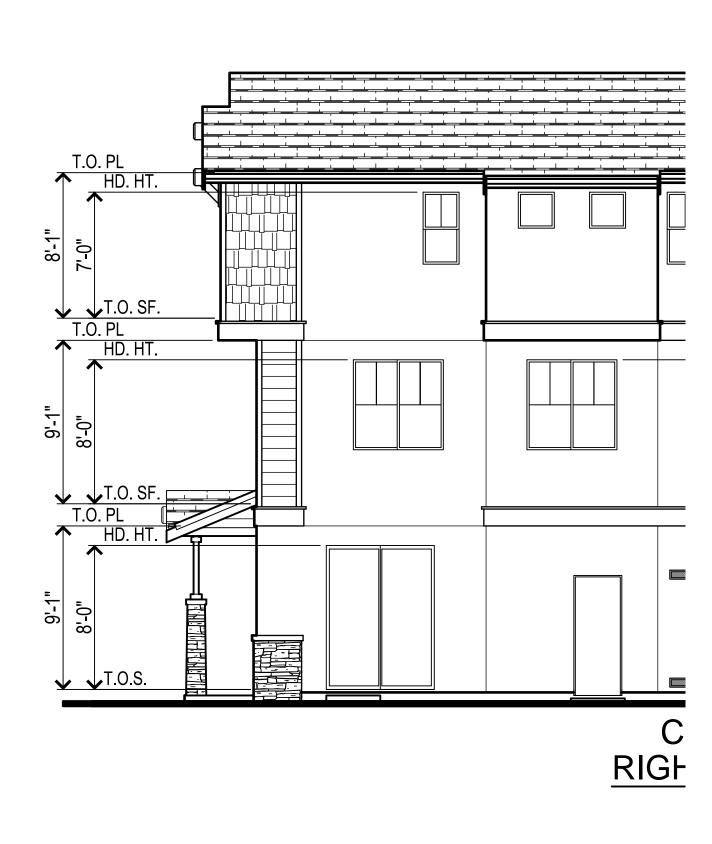


PLAN 3 'B' ELEVATION


K B H o m e

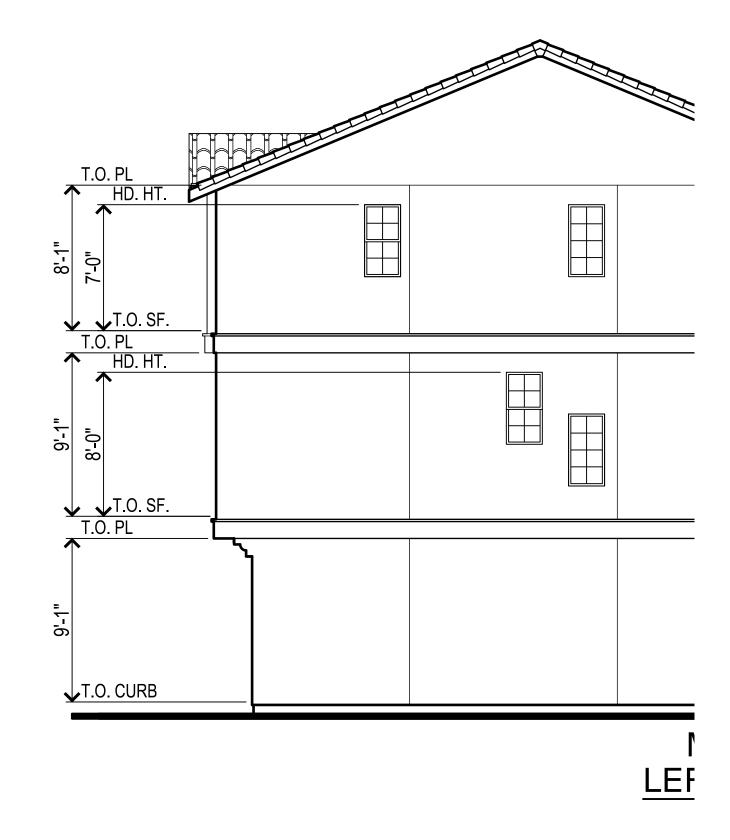


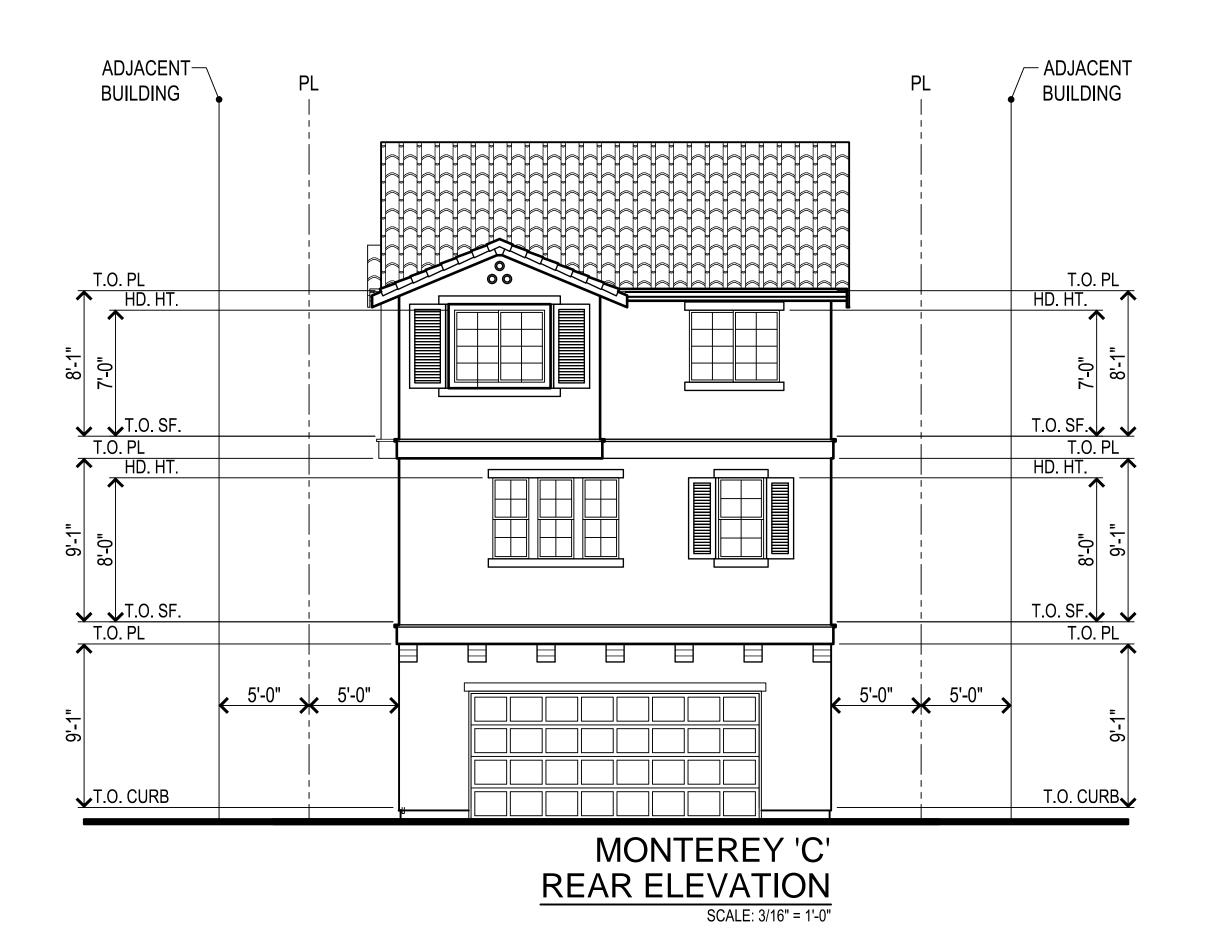


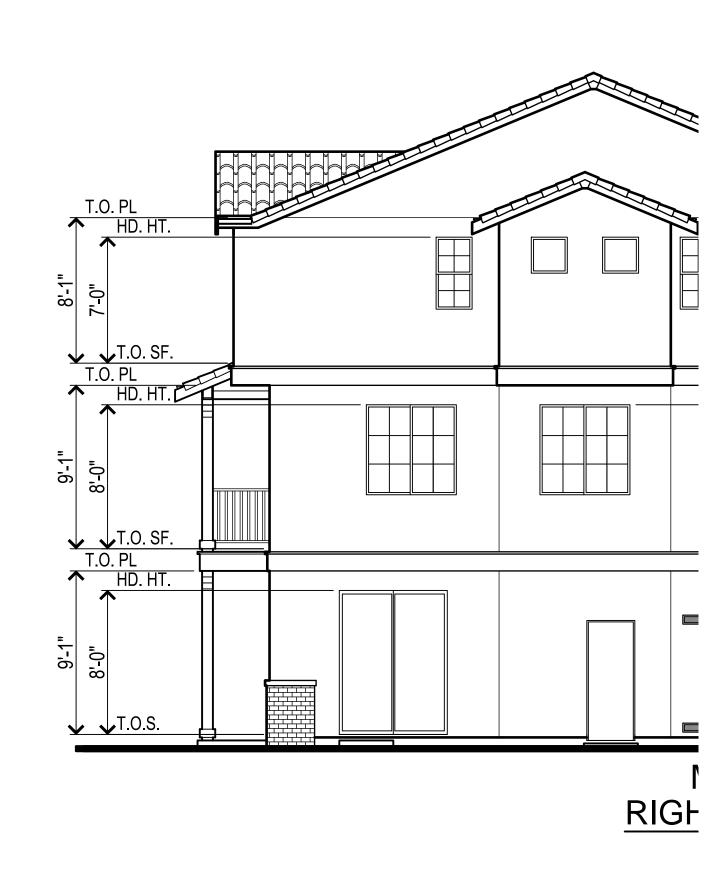

PLAN 3 'C' ELEVATION

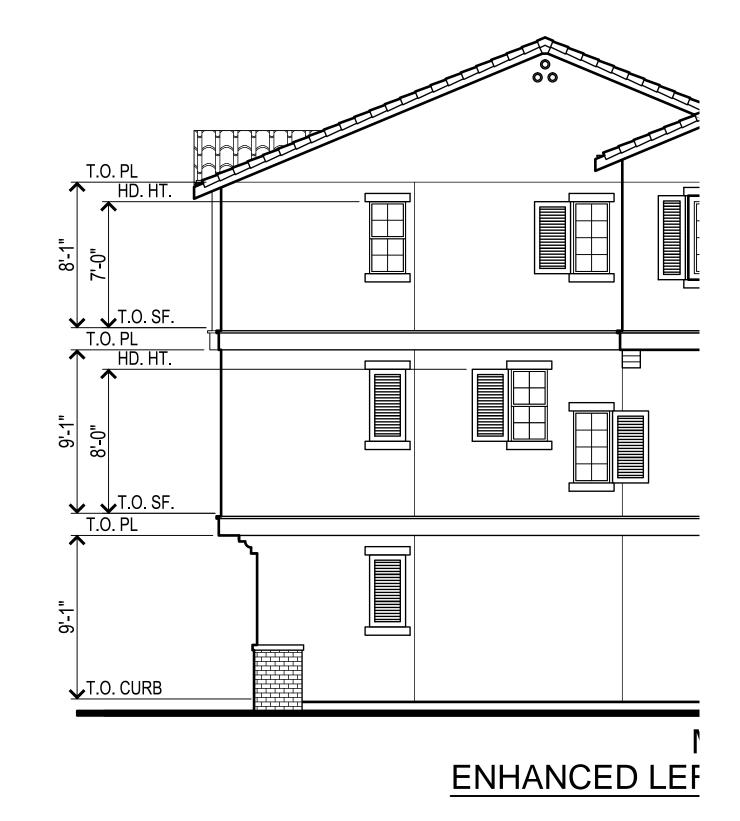


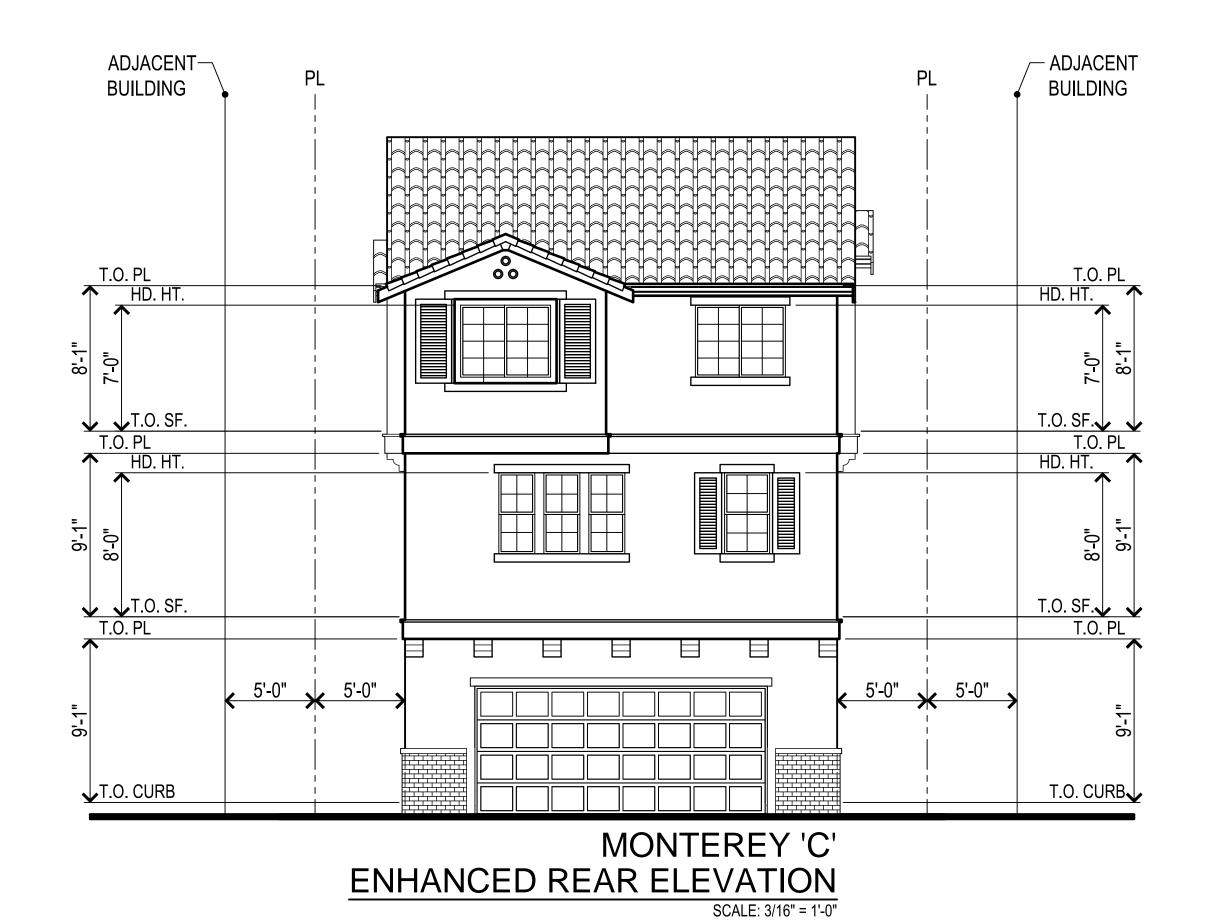

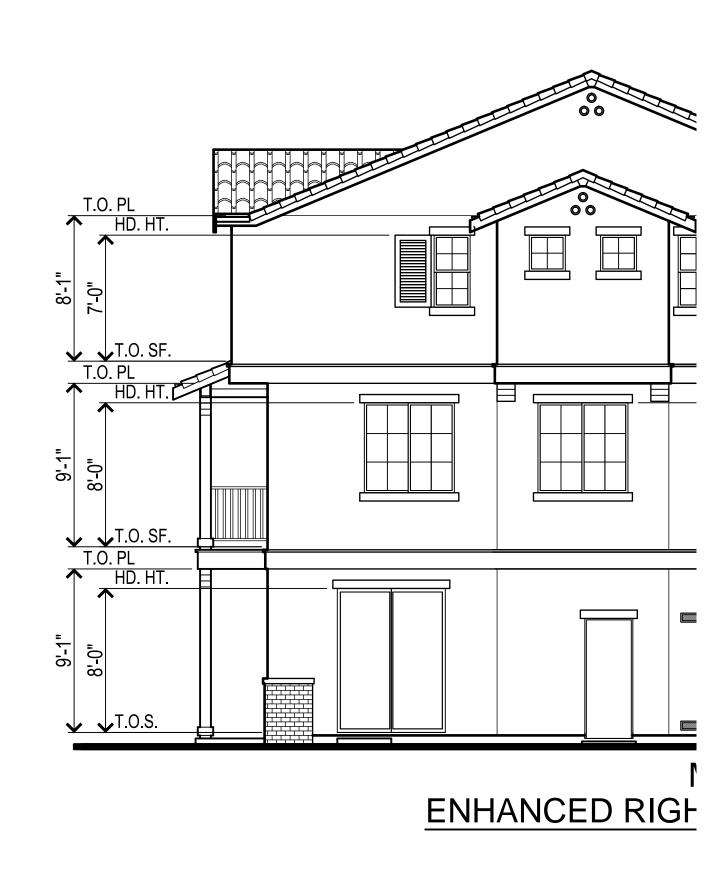

PLAN 3 'C' EN

KBHome

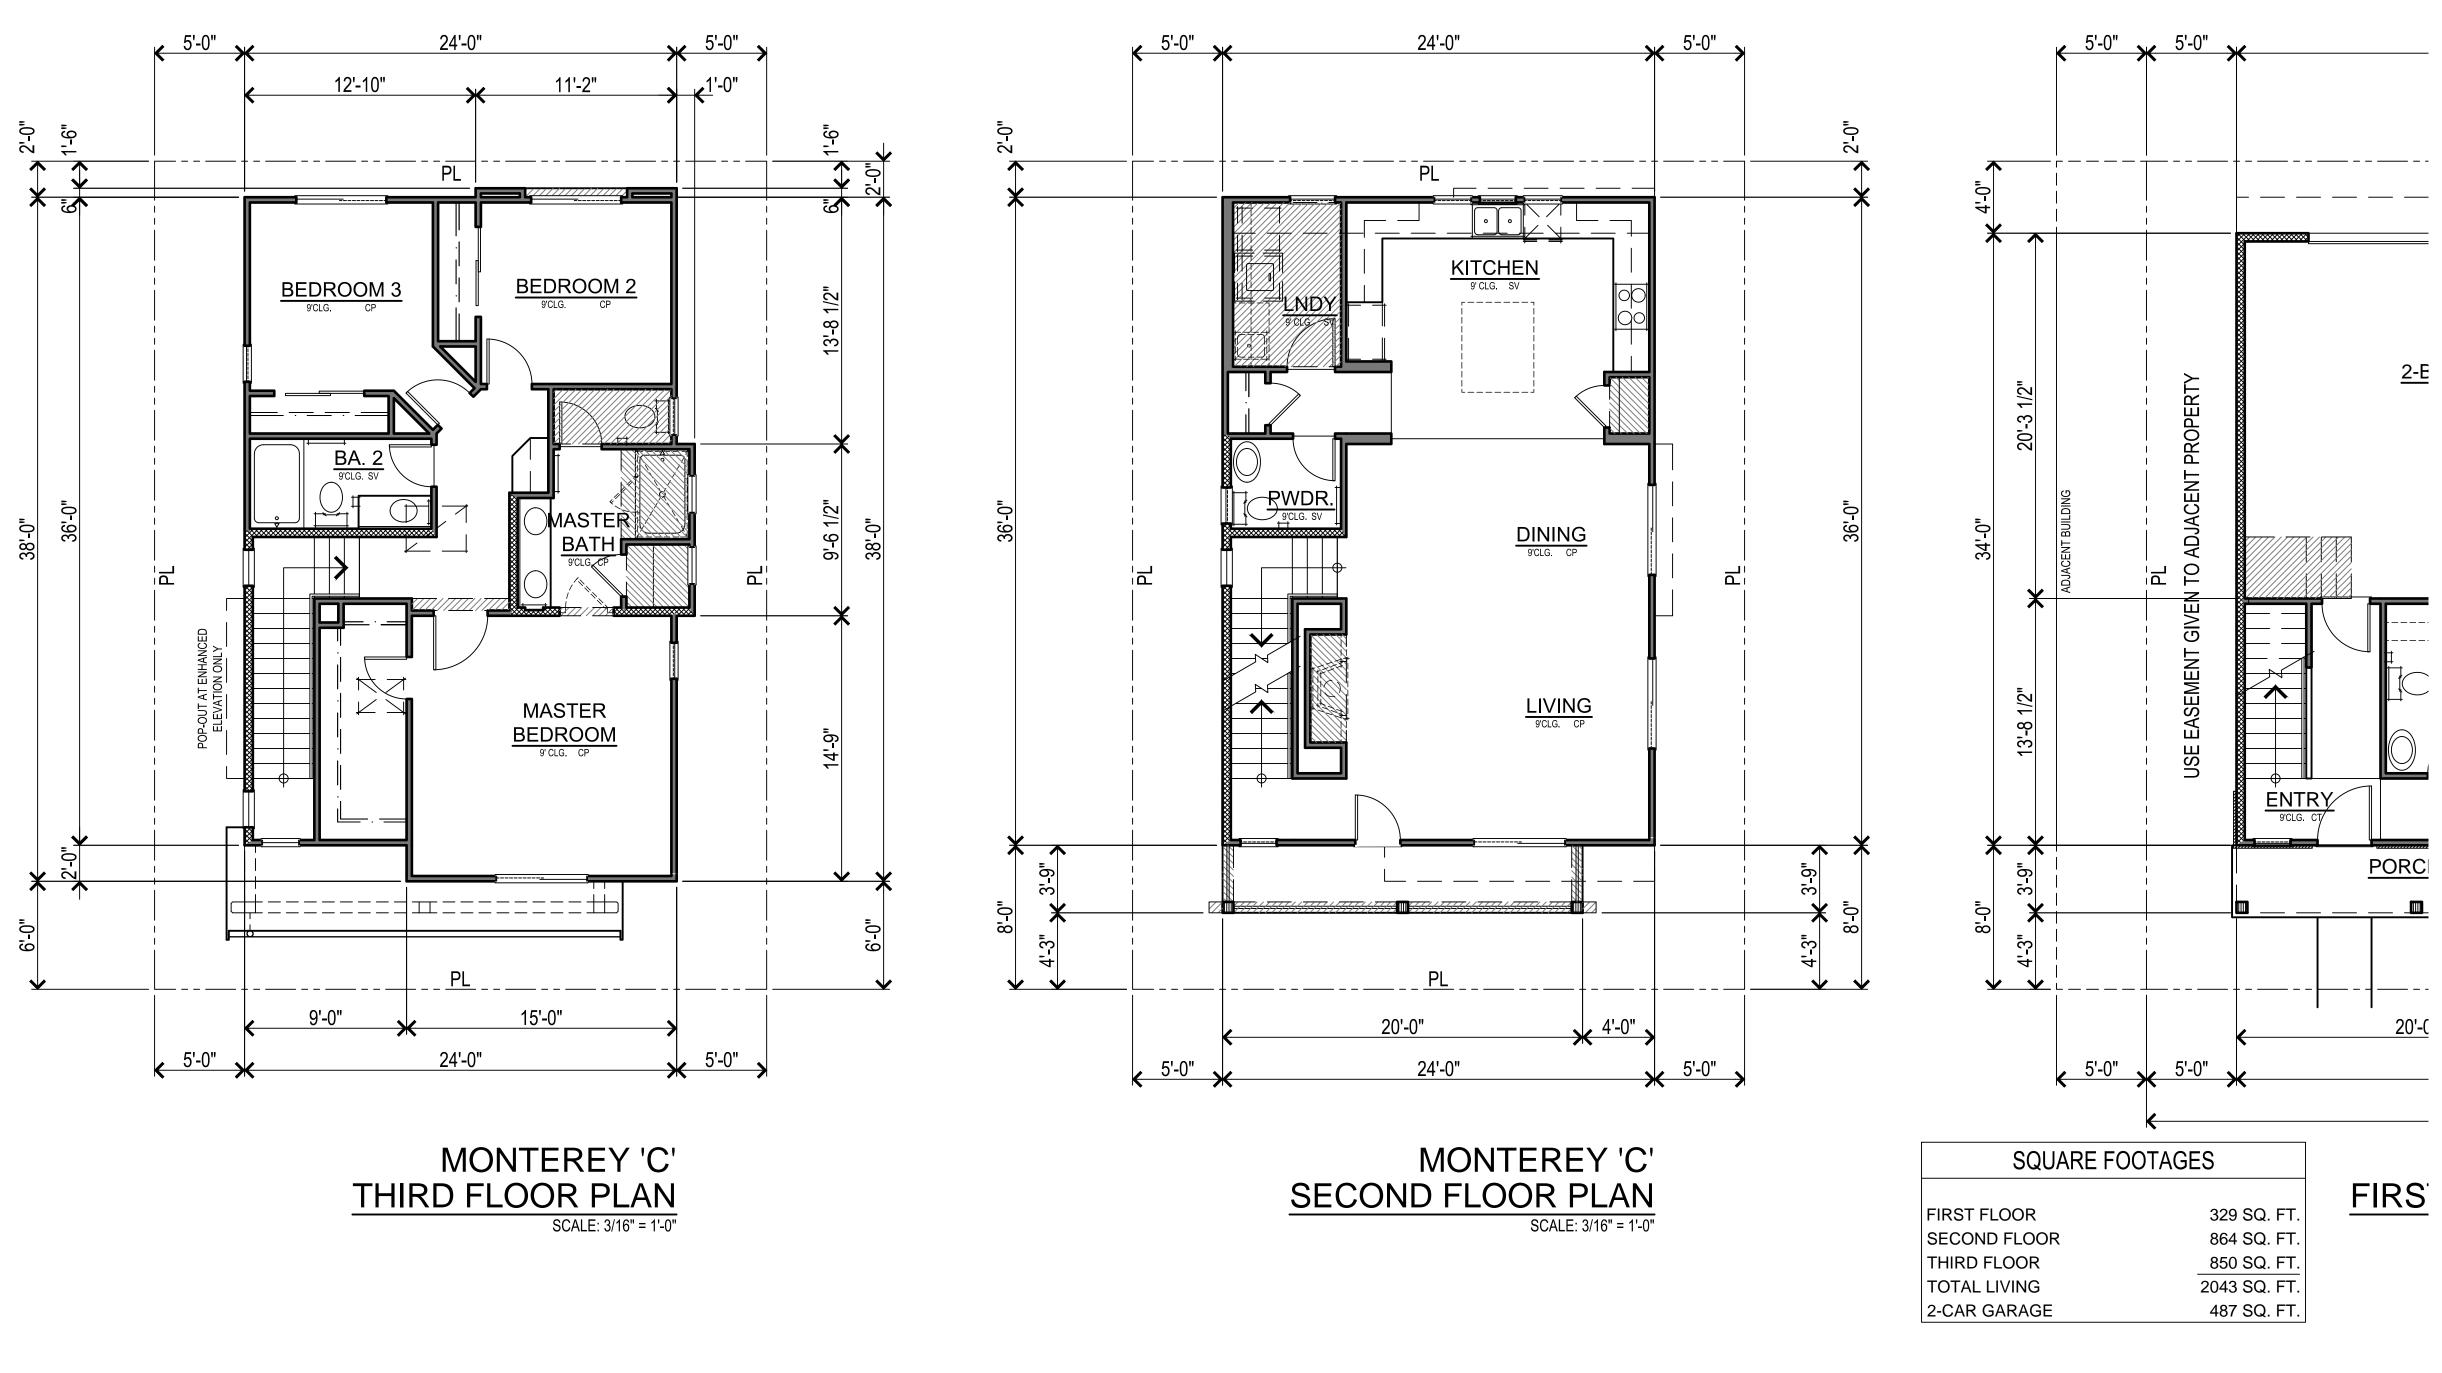


KBHome



KBHome

3361 Walnut Blvd. Suite 120 Brentwood, CA 94513 925.634.7000 www.straussdesign.com

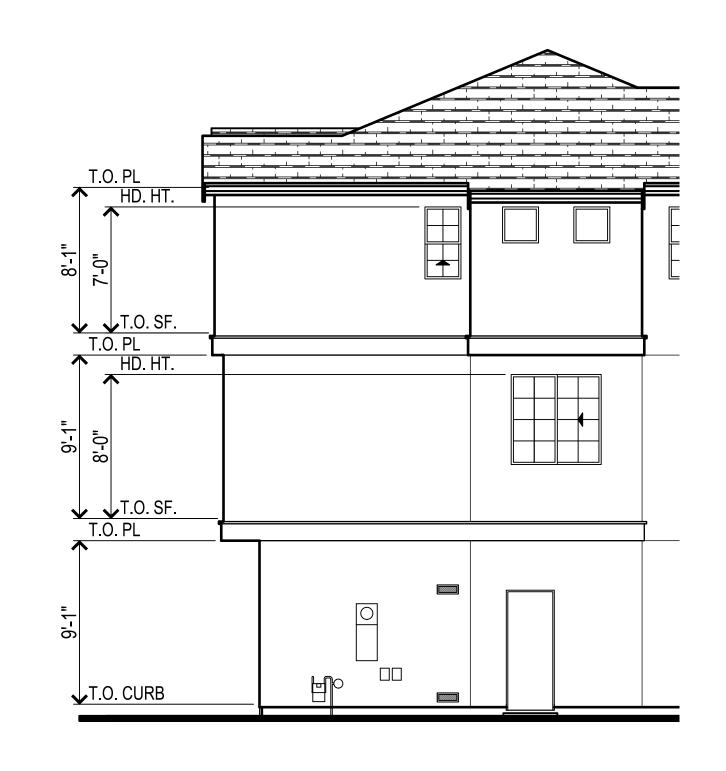



T.O. PL
HD. HT.

T.O. PL
HD. HT.

T.O. PL
T.O. SF.
T.O. PL
T.O. SF.
T.O. PL
T.O. PL

CAPE COD 'A'
REAR ELEVATION

SCALE: 3/16" = 1'-0"


<u>RIGH</u>


<u>LEF</u>

Amaral
City of Hayward
Mar 7, 2016

MULTI-FAMILY DUET ELEVATIONS

KBHome

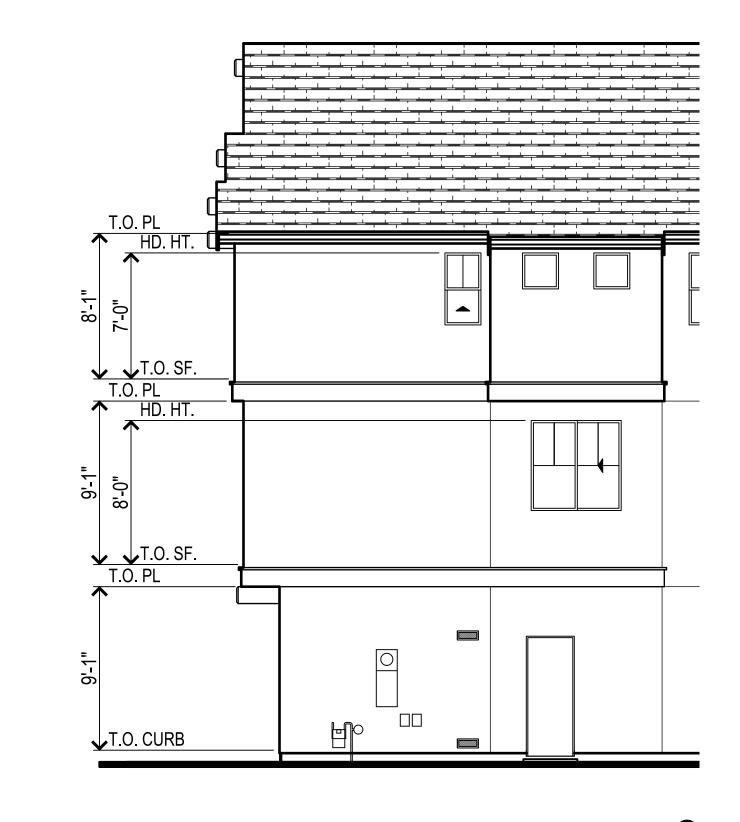

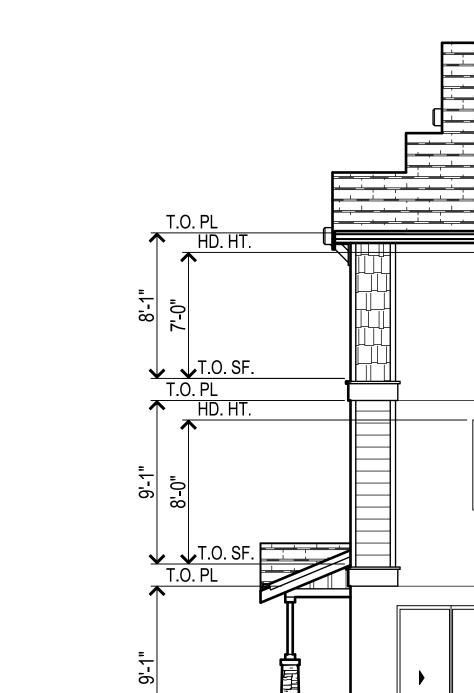

T.O.S.

<u>RIGH</u>

CRAFTSMAN 'B' **REAR ELEVATION** SCALE: 3/16" = 1'-0"

/ ADJACENT

BUILDING

T.O. PL

T.O. SF. T.O. PL HD. HT.

T.O. SF. T.O. PL

T.O. CURB

HD HT.

Amaral City of Hayward Mar 7, 2016

MULTI-FAMILY DUET ELEVATIONS

KBHome

5000 Executive Parkway, San Ramon, Ca 94583 925.983.4500


 $\mathsf{ADJACENT} \mathcal{oldsymbol{ o}}$


BUILDING

T.O. SF. T.O. PL HD. HT.

T.O. PL

T.O. CURB

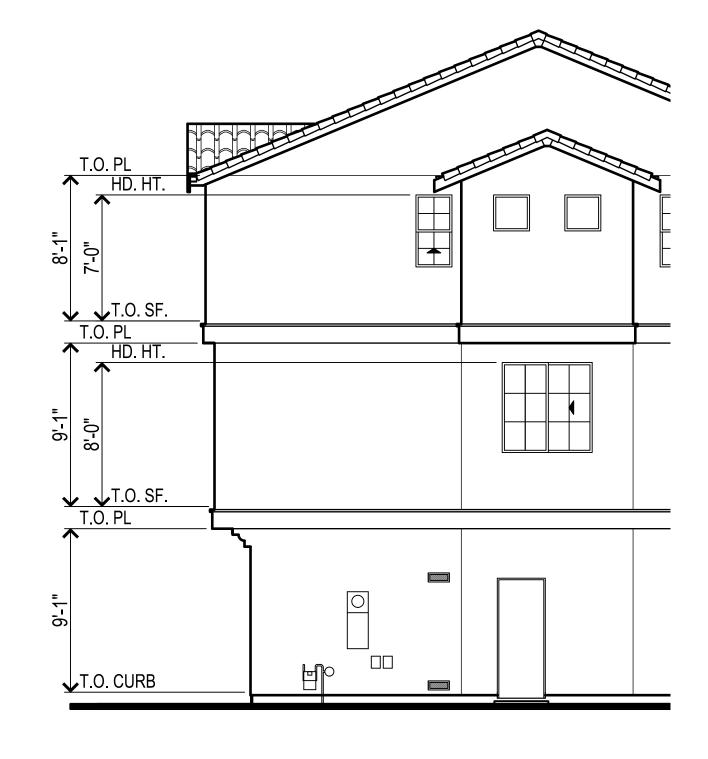

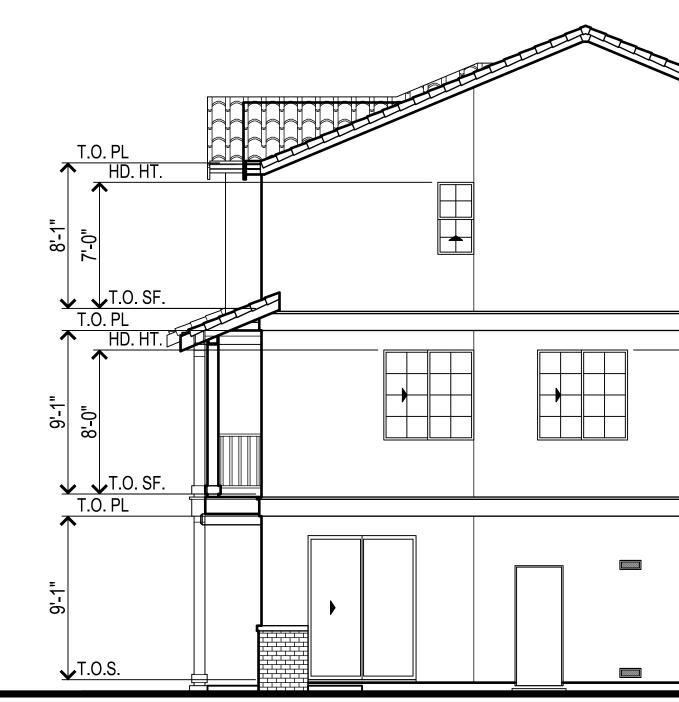

T.O. SF.

T.O. PL

HD. HT.

<u>RIGH</u>

MONTEREY 'C' **REAR ELEVATION** SCALE: 3/16" = 1'-0"

— ADJACENT

BUILDING

HD. HT.

T.O. SF. T.O. PL HD. HT.

T.O. SF. T.O. PL

T.O. CURB

Amaral City of Hayward Mar 7, 2016

MULTI-FAMILY DUET ELEVATIONS

KBHome

5000 Executive Parkway, San Ramon, Ca 94583 925.983.4500

ADJACENT-

BUILDING


T.O. PL HD. HT.

T.O. SF. T.O. PL HD. HT.


T.O. SF.

T.O. CURB

HANANANANA.

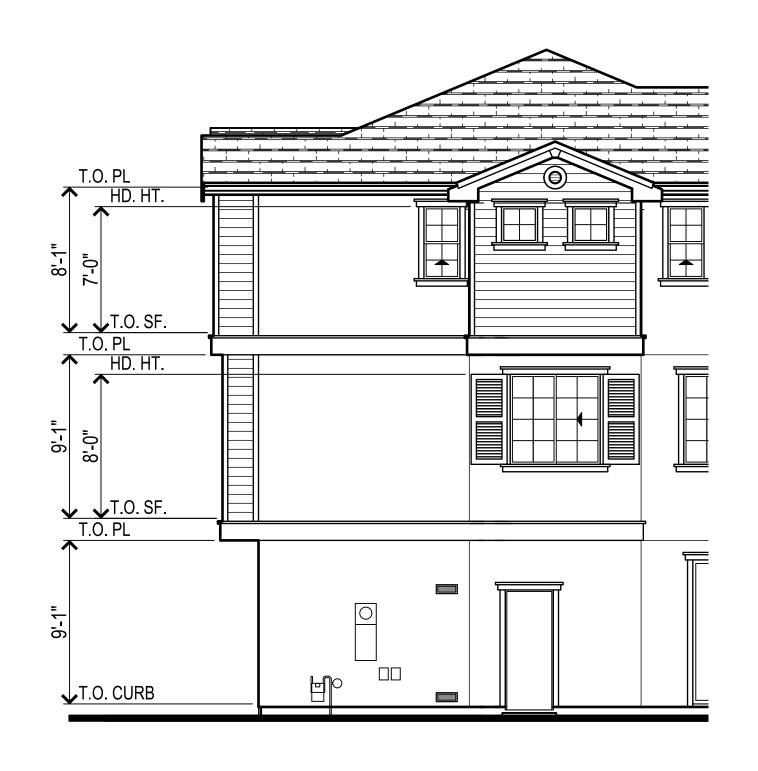

ENHANCED LEF

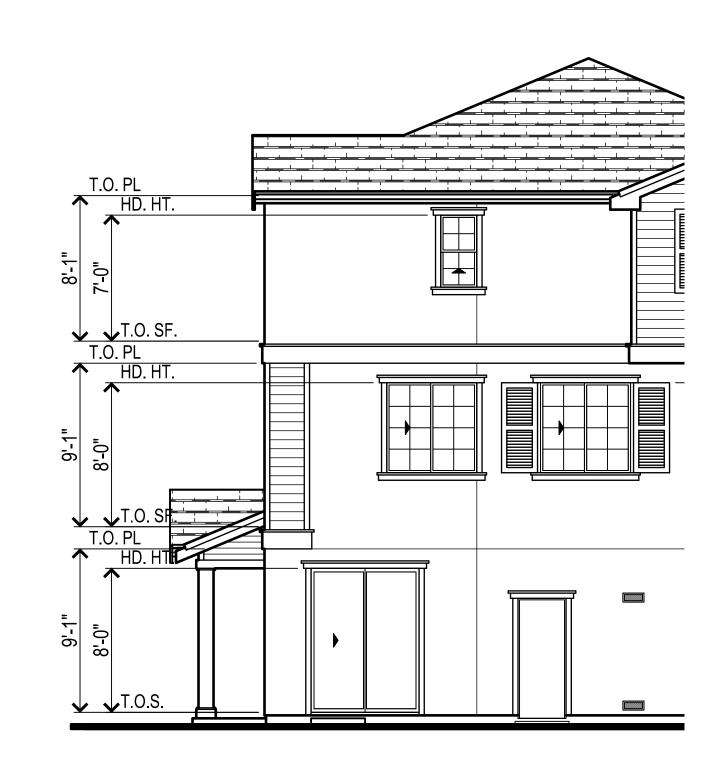

/— ADJACENT BUILDING

T.O. PL HD. HT. ______

T.O. SF. T.O. PL HD. HT.

T.O. SF. T.O. PL

T.O. CURB

CAPE COD 'A'

ENHANCED REAR ELEVATION

SCALE: 3/16" = 1'-0"

ENHANCED RIGH

Amaral

ADJACENT $igcup_{}$ BUILDING

5'-0" 5'-0"

T.O. PL HD. HT.

T.O. SF.

T.O. PL

HD. HT.


T.O. SF.

↓T.O. CURB

MULTI-FAMILY DUET 'A' EN

City of Hayward Mar 7, 2016

KBHome

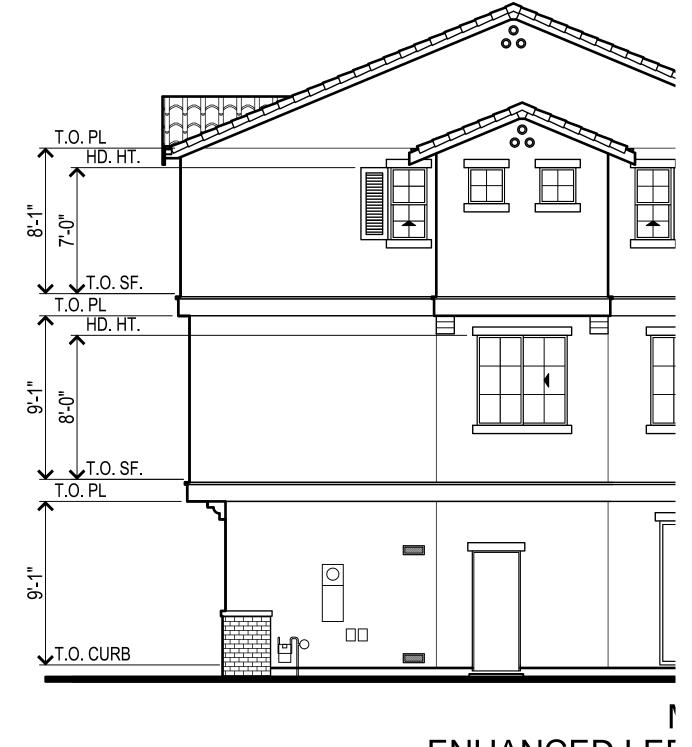

ENHANCED LEF




MONTEREY 'C' ENHANCED REAR ELEVATION SCALE: 3/16" = 1'-0" T.O. PL HD. HT. T.O. SF. T.O. PL HD. HT. T.O. SF. T.O. PL HD. HT.


ENHANCED RIGH


Amaral
City of Hayward
Mar 7, 2016

MULTI-FAMILY DUET 'C' EN

KBHome

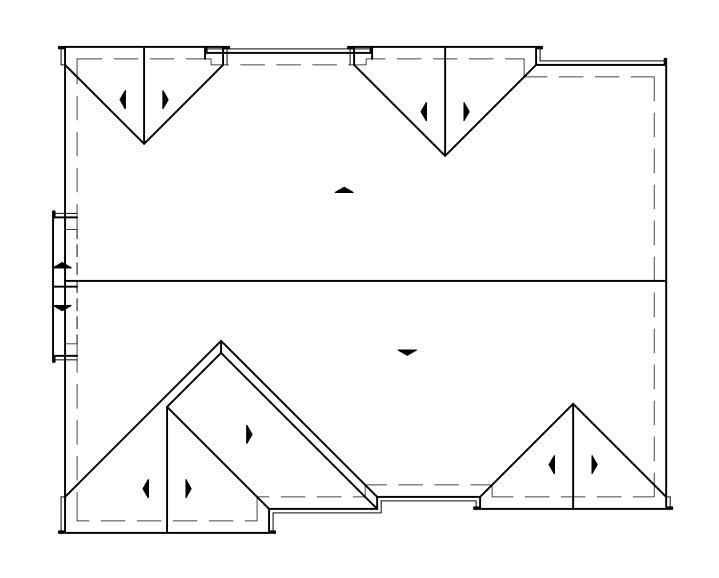

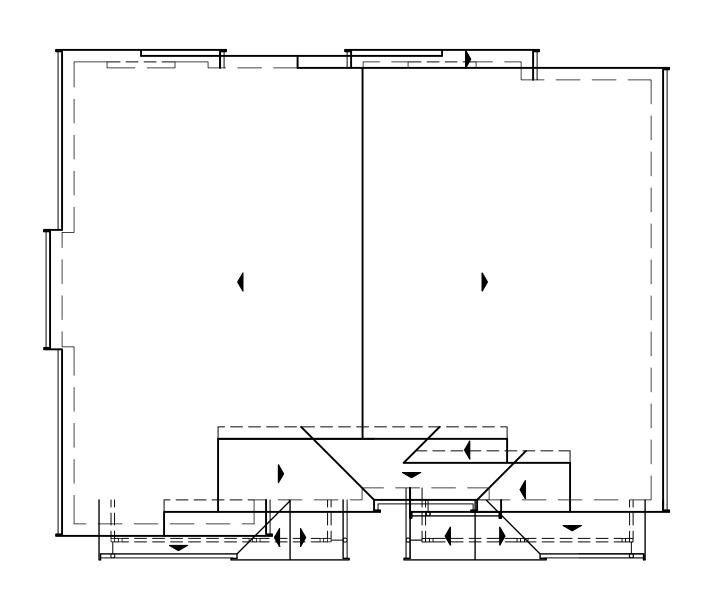

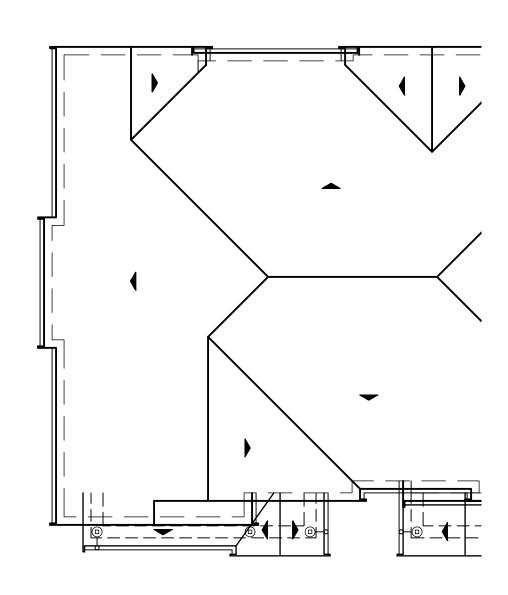

DUET ROOF PLAN 'C'
SCALE: 1/8" = 1'-0"


DUET ROOF PLAN 'B'
SCALE: 1/8" = 1'-0"

DUET ROO

MULTI-FAMIL


Amaral
City of Hayward
Mar 7, 2016

KBHome

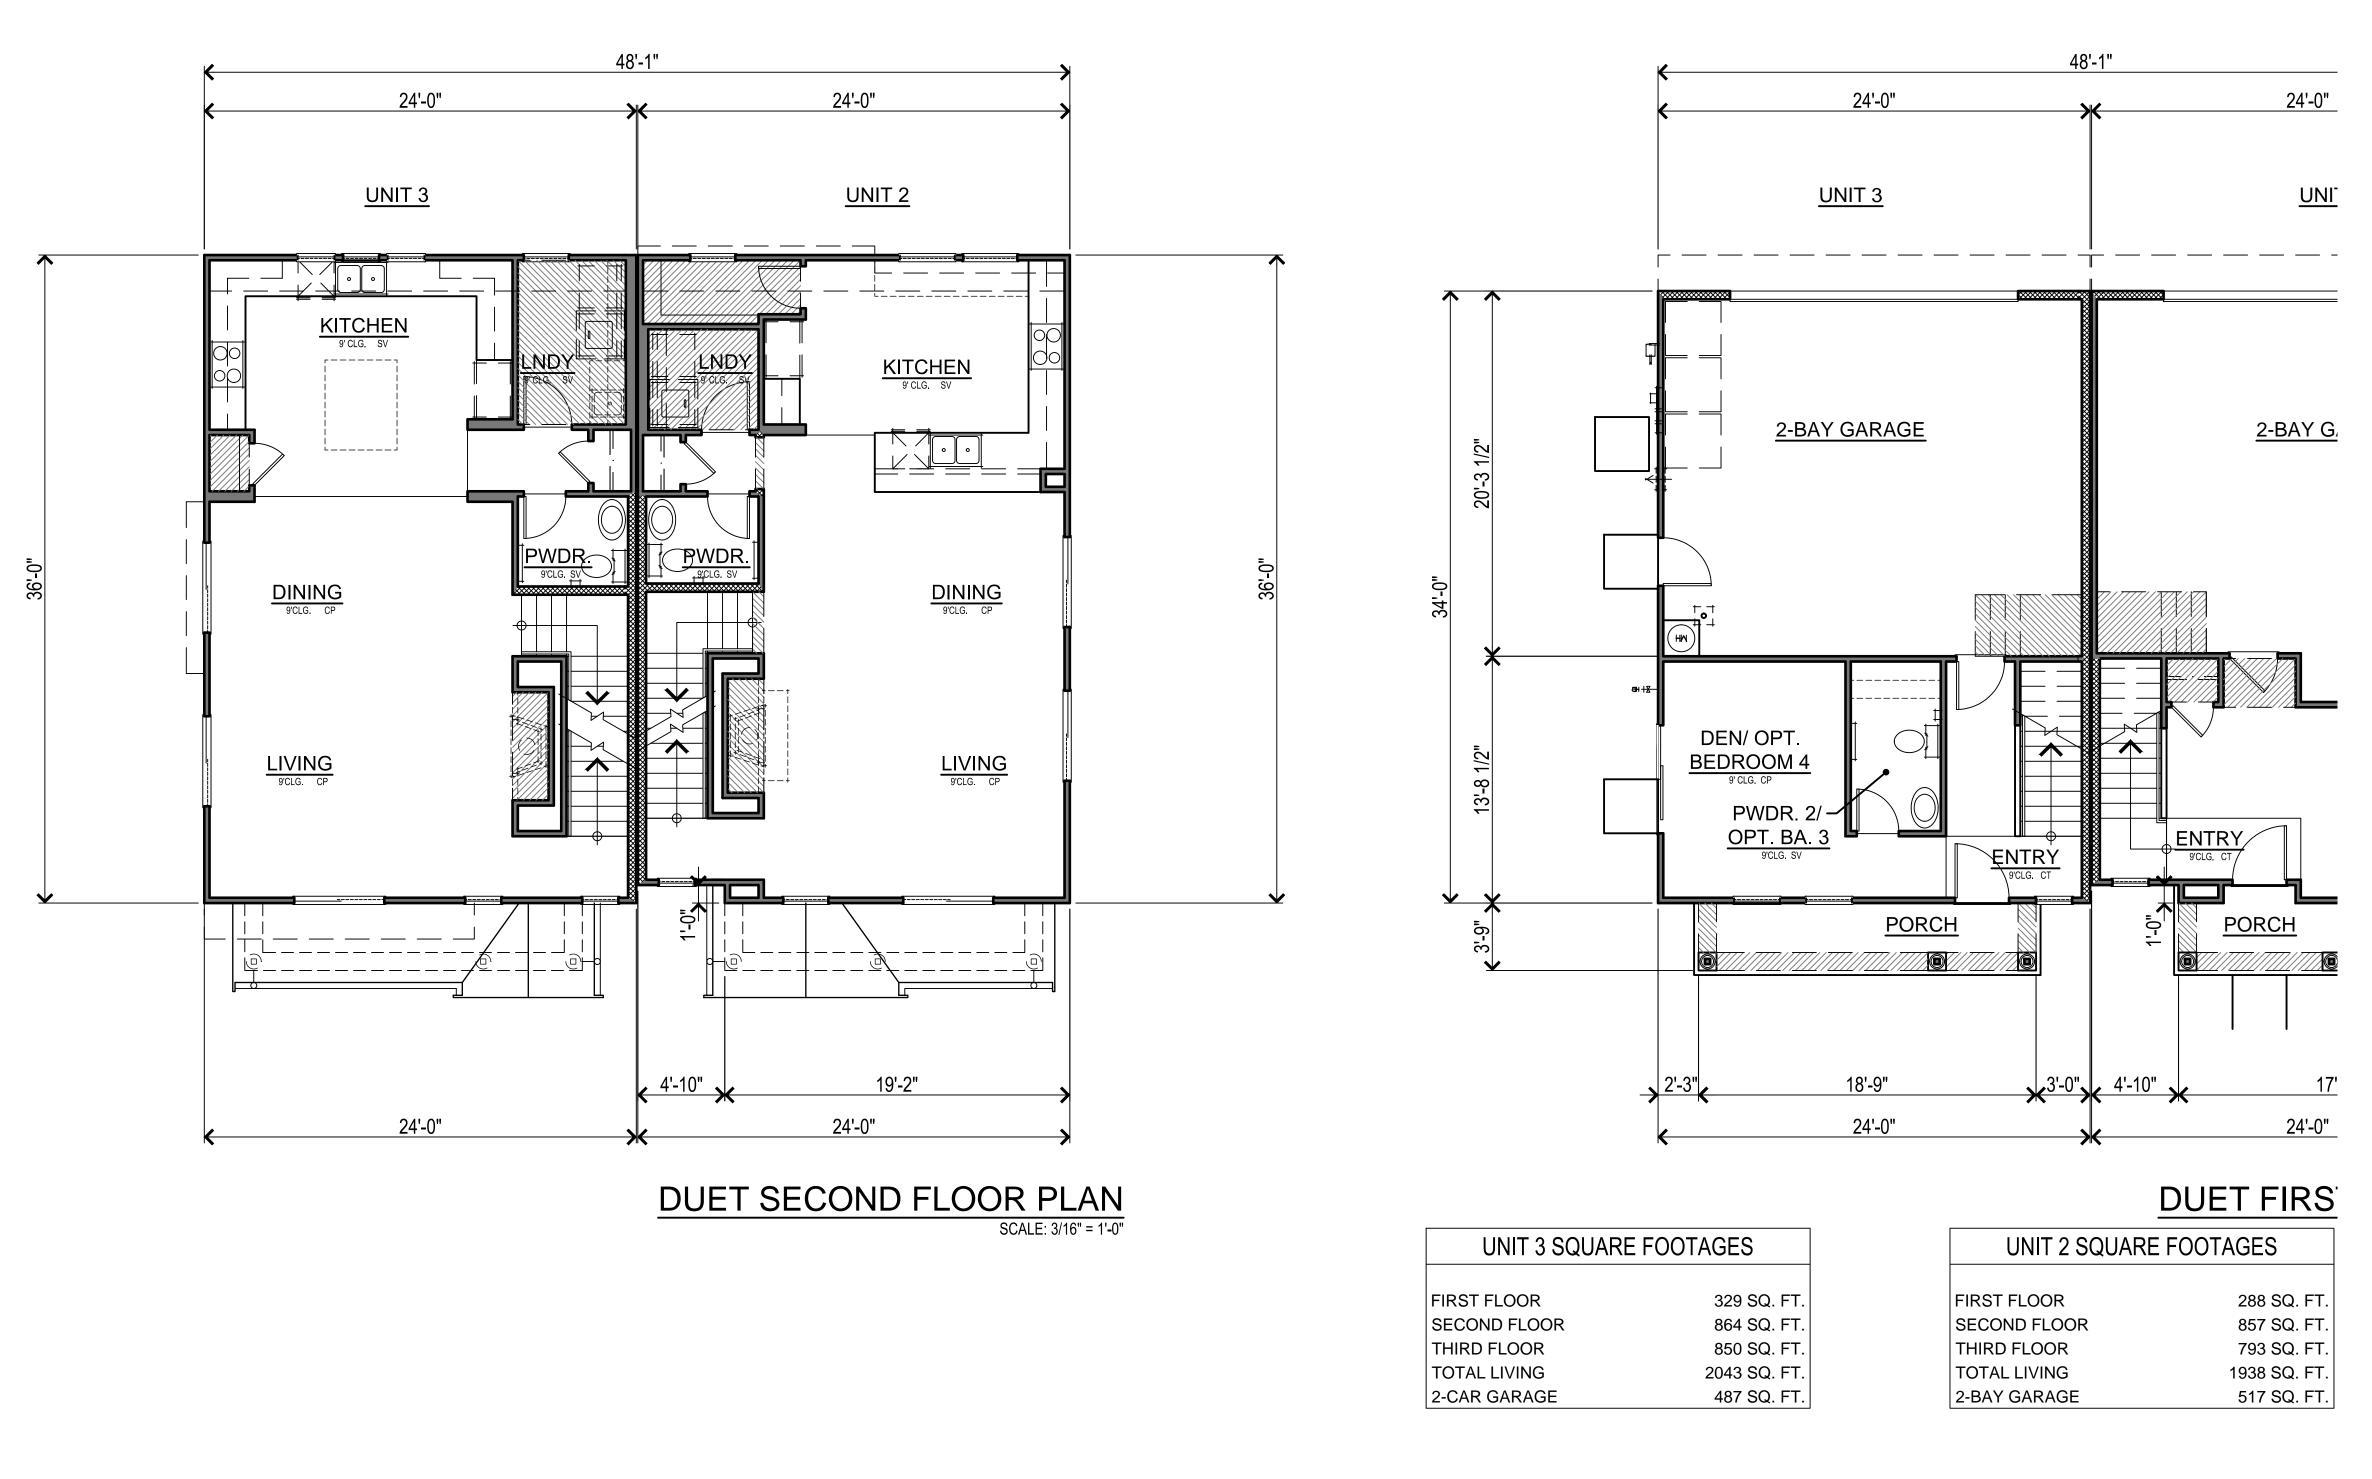

MULTI-FAMILY DUET FIRST AND SE

KBHome

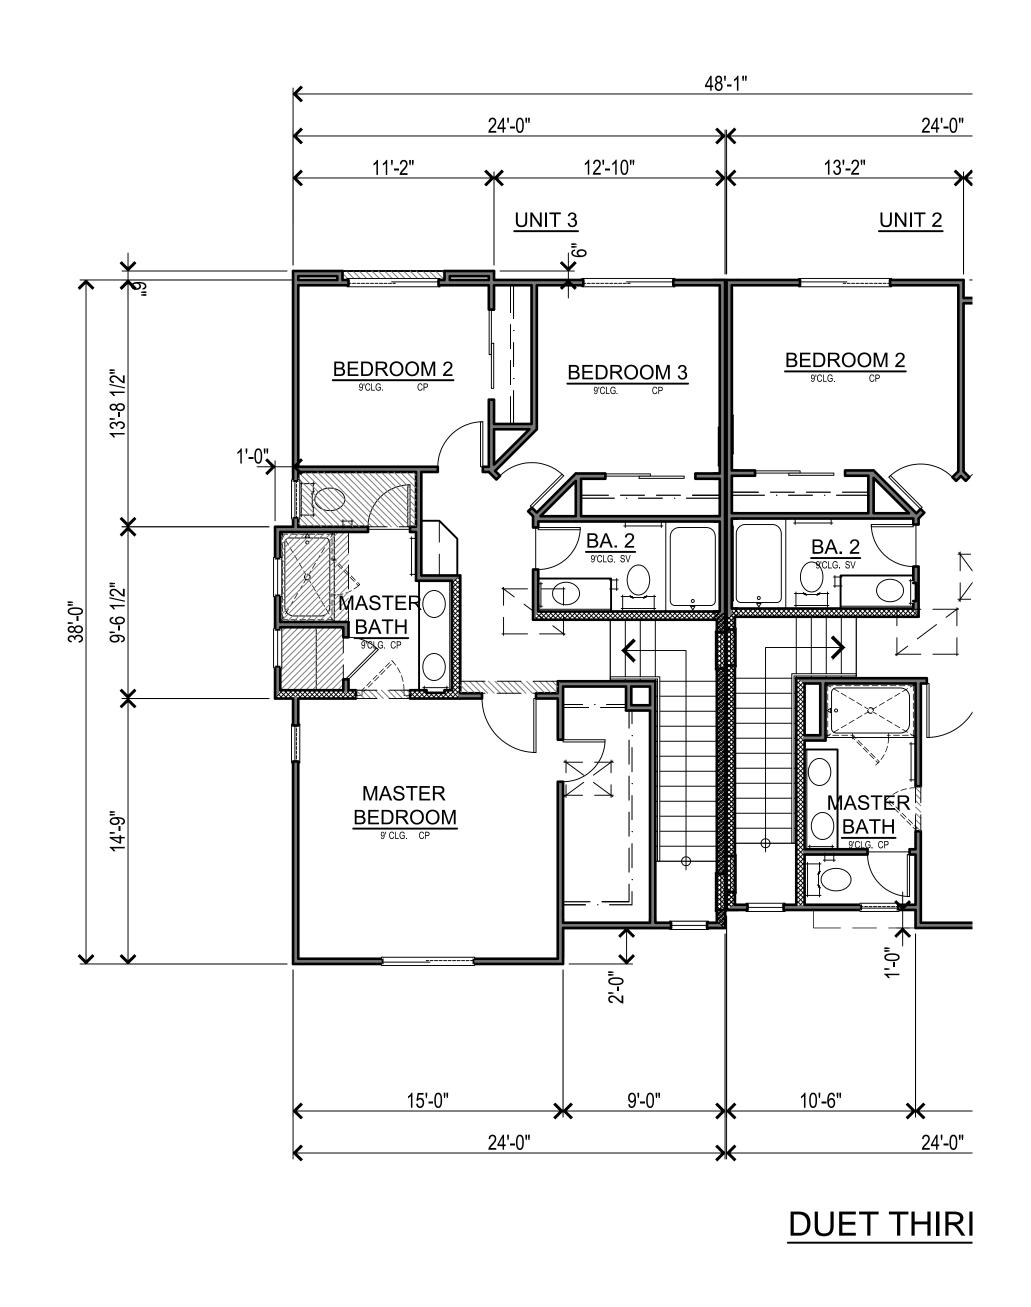

Amaral
City of Hayward
Mar 7, 2016 MULTI-FAMILY DI

KBHome