# SHEET INDEX

NO.

1	COVE	R SHEET - SHEET INDEX
	CIVIL	PLANS
2	TM.1	VESTING TENTATIVE MAP - EXISTING PROPERTY
3	TM.2	VESTING TENTATIVE MAP - SITE PLAN
4	TM.3	VESTING TENTATIVE MAP - GRADING PLAN
5	TM.4	VESTING TENTATIVE MAP - UTILITY PLAN
6	TM.5	VESTING TENTATIVE MAP - OPEN SPACE EXHIBIT

<u>NO.</u>	LAND	SCAPE PLANS
7	L-0	COVER SHEET
8	L-1	LAYOUT AND PLANTING LEGEND
9	L-2	TREE REMOVAL PLAN
10	L-3	LANDSCAPE CONCEPT
11	L-4	CONCEPTUAL ENLARGEMENT PLAN
12	L-5	LANDSCAPE DETAILS
13	L-6	LANDSCAPE DETAILS
14	L-7	LANDSCAPE DETAILS
15	L-8	IRRIGATION CONCEPT
16	L-9	IRRIGATION NOTES AND LEGEND
17	L-10	IRRIGATION DETAILS
18	L-11	IRRIGATION DETAILS

N	<u>O.</u>	<u>ARCHI</u>	TECTURAL PLANS
	19	A01	STREET SCENE
2	20	A02	PLAN 1 FRONT ELEVATIONS AND ROOF PLANS
2	21	A03	PLAN 1 'A' ELEVATIONS AT INTERIOR LOTS
2	22	A04	PLAN 1 'B' ELEVATIONS AT INTERIOR LOTS
2	23	A05	PLAN 1 'C' ELEVATIONS AT INTERIOR LOTS
2	24	A06	PLAN 1 'B' ENHANCED ELEVATIONS
2	25	A07	PLAN 1 FLOOR PLANS
2	26	A08	PLAN 2 FRONT ELEVATIONS AND ROOF PLANS
2	27	A09	PLAN 2 'A' ELEVATIONS AT INTERIOR LOTS
2	28	A10	PLAN 2 'B' ELEVATIONS AT INTERIOR LOTS
1	29	A11	PLAN 2 'C' ELEVATIONS AT INTERIOR LOTS
3	30	A12	PLAN 2 'A' ENHANCED ELEVATIONS
í	31	A13	PLAN 2 FLOOR PLANS

<u>NO.</u>	ARCHI	TECTURAL PLANS
32	A14	PLAN 3 FRONT ELEVATIONS AND ROOF PLANS
33	A15	PLAN 3 'A' ELEVATIONS AT INTERIOR LOTS
34	A16	PLAN 3 'B' ELEVATIONS AT INTERIOR LOTS
35	A17	PLAN 3 'C' ELEVATIONS AT INTERIOR LOTS
36	A18	PLAN 3 'C' ENHANCED ELEVATIONS
37	A19	PLAN 3 FLOOR PLANS

# **ATTACHMENT IV**

# DEVELOPER

KB HOME SOUTH BAY, INC, 5000 EXECUTIVE PARKWAY, SUITE 125 SAN RAMON, CA 94583 (925) 983-4527 CONTACT: RAY PANEK

# CIVIL ENGINEER

CARLSON, BARBEE & GIBSON, INC. 2633 CAMINO RAMON, SUITE 350 SAN RAMON, CA 94583 (925) 866-0322 CONTACT: LEE ROSENBLATT

# LANDSCAPE ARCHITECT

GATES + ASSOCIATES
2671 CROW CANYON RD.
SAN RAMON,CA 94583
(925) 736-8176
CONTACT: MELONIE O' SULLIVAN

# ARCHITECT

SDG ARCHITECTS, INC. 3361 WALNUT BLVD. SUIT 120 BRENTWOOD, CA 94513 (925) 634-7000 CONTACT: RALPH STRAUSS



**SEPTEMBER 28, 2015** 








# AMARAL PROPERTIES-TRACT 8266 PLANNED DEVELOPMENT

HAYWARD, CALIFORNIA


**Page 1 of 37** 

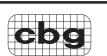



Carlson, Barbee & Gibson, Inc.

CIVIL ENGINEERS ★ SURVEYORS ◆ PLANNERS

2633 CAMINO RAMON, SUITE 350 SAN RAMON, CALIFORNIA 94583 (925) 866-0322 www.cbandg.com

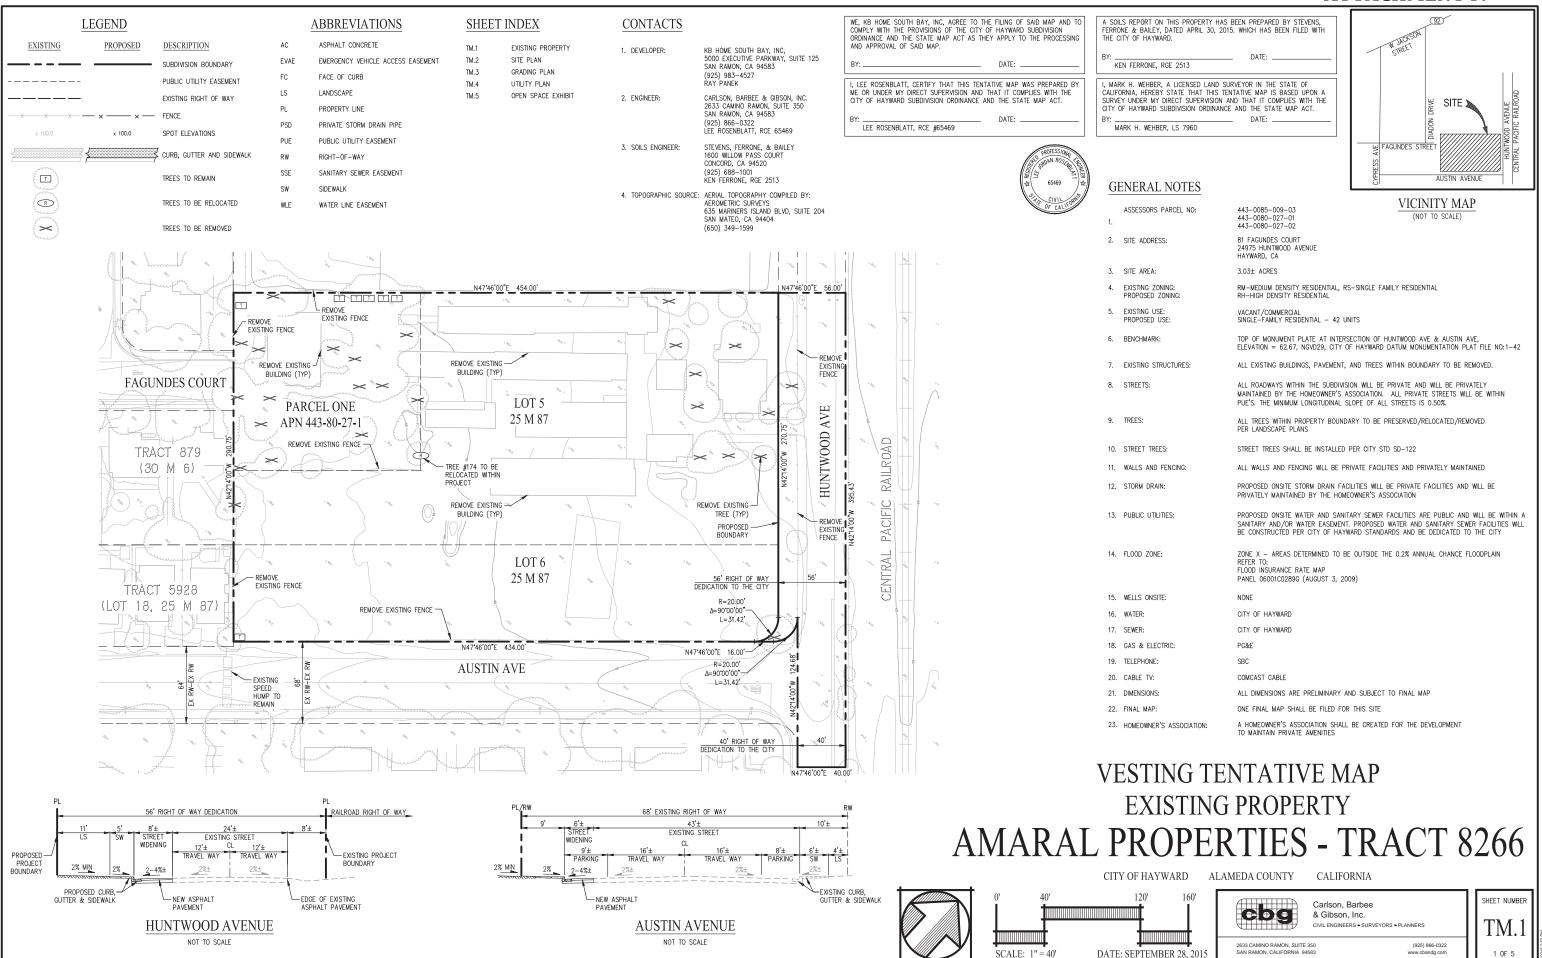


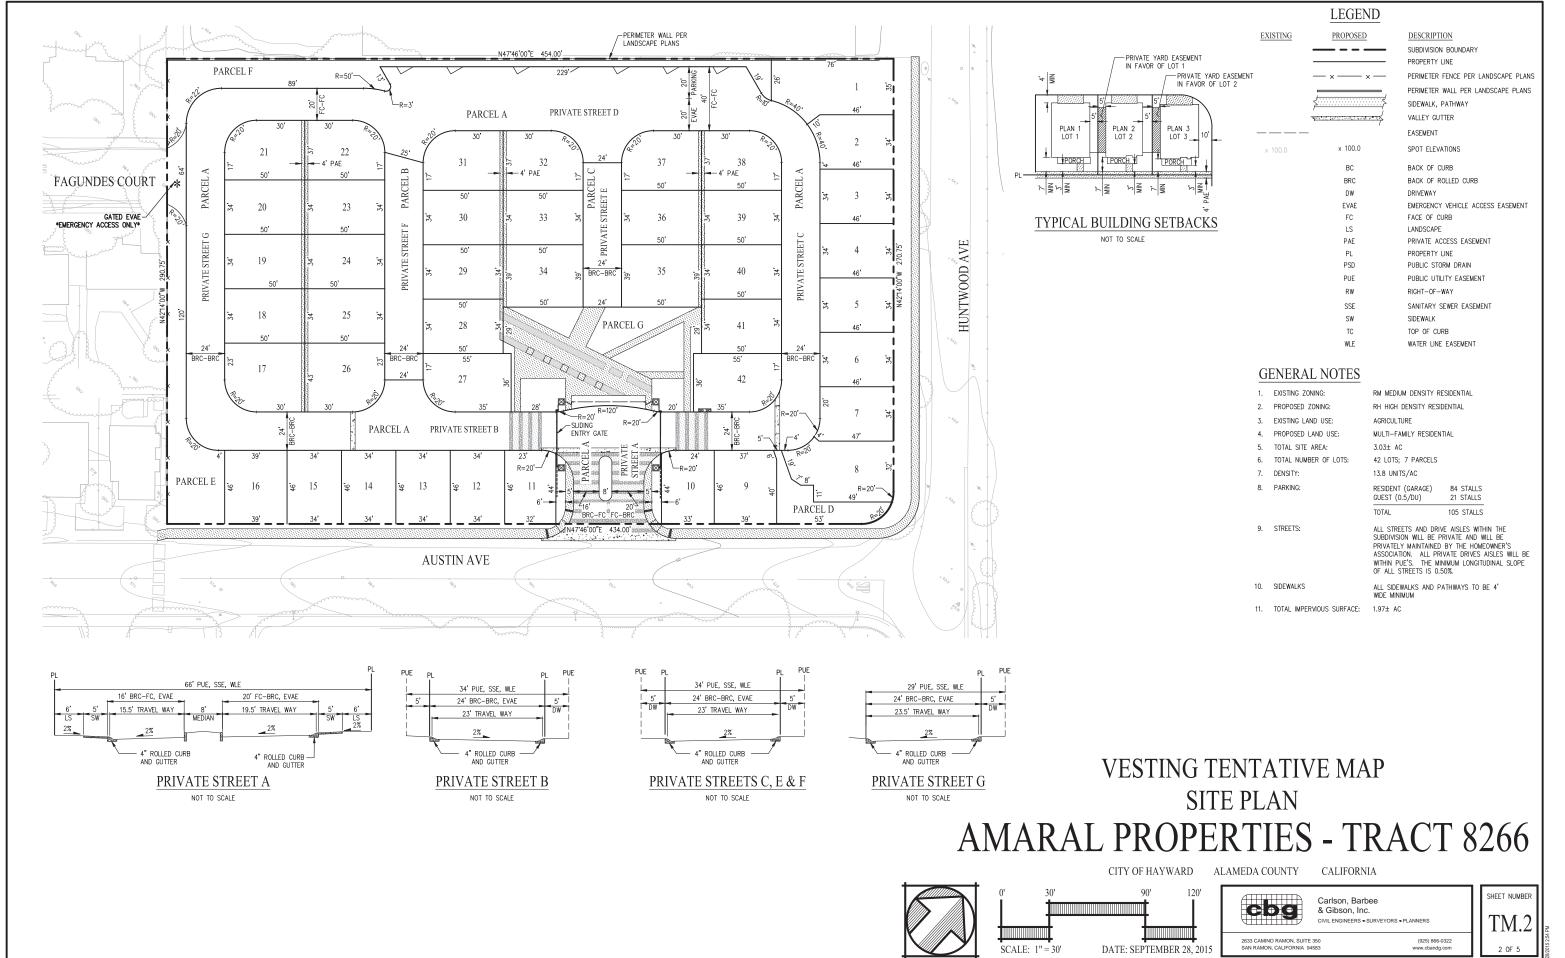


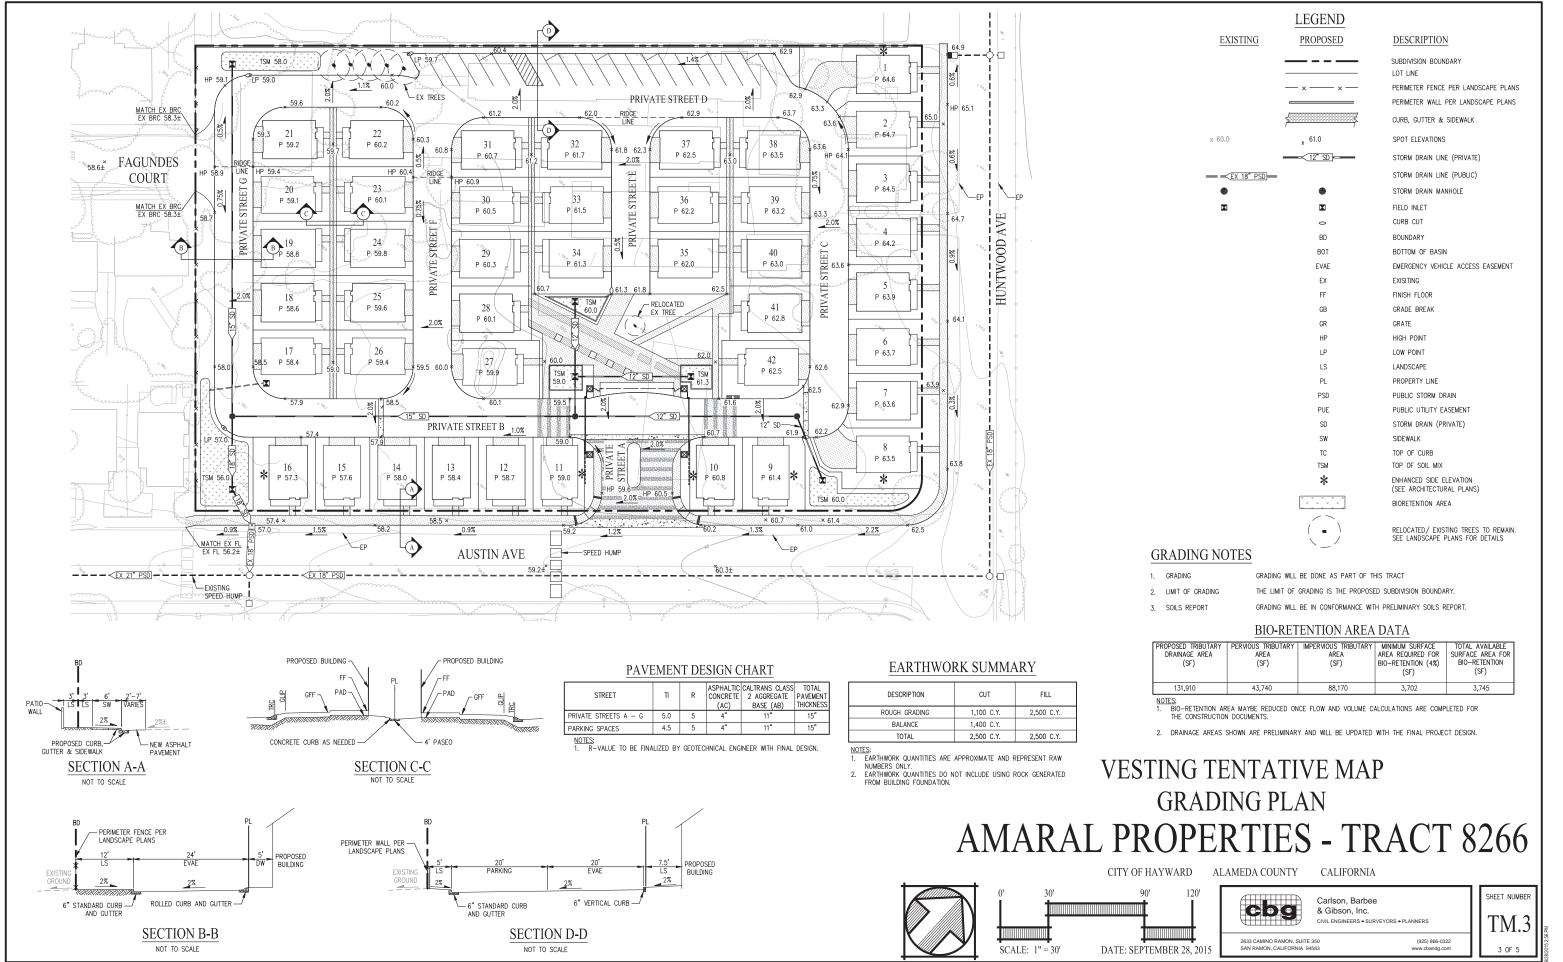

**Page 4 of 37** 

G:\2426-000\ACAD\VTM\TM-3-GRADING PLAN,DWG

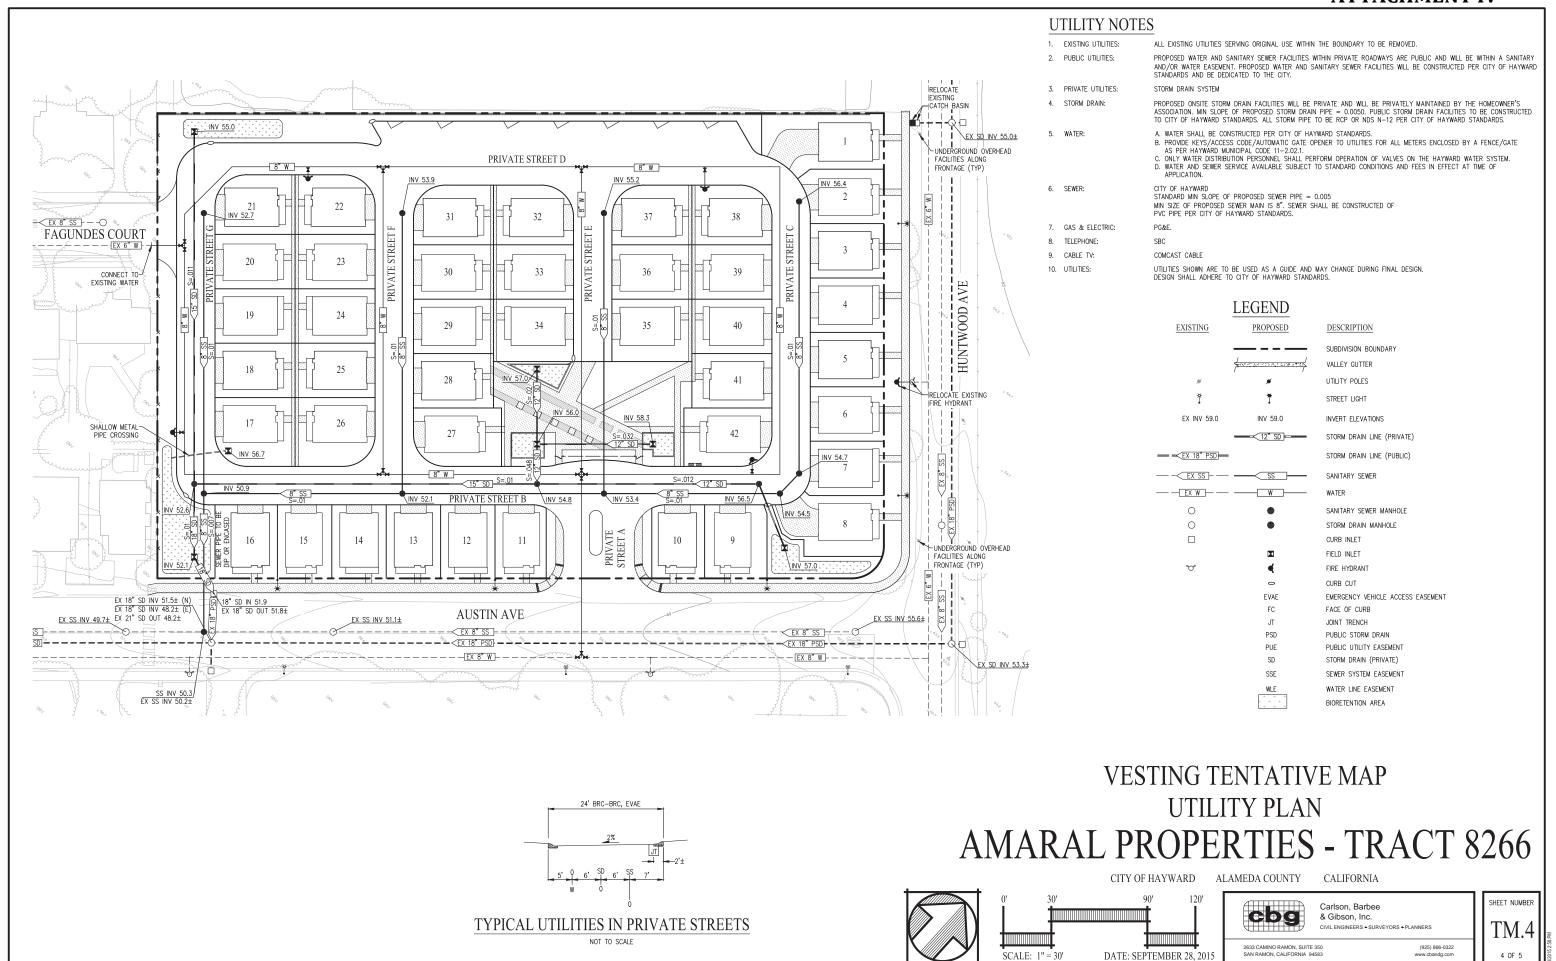

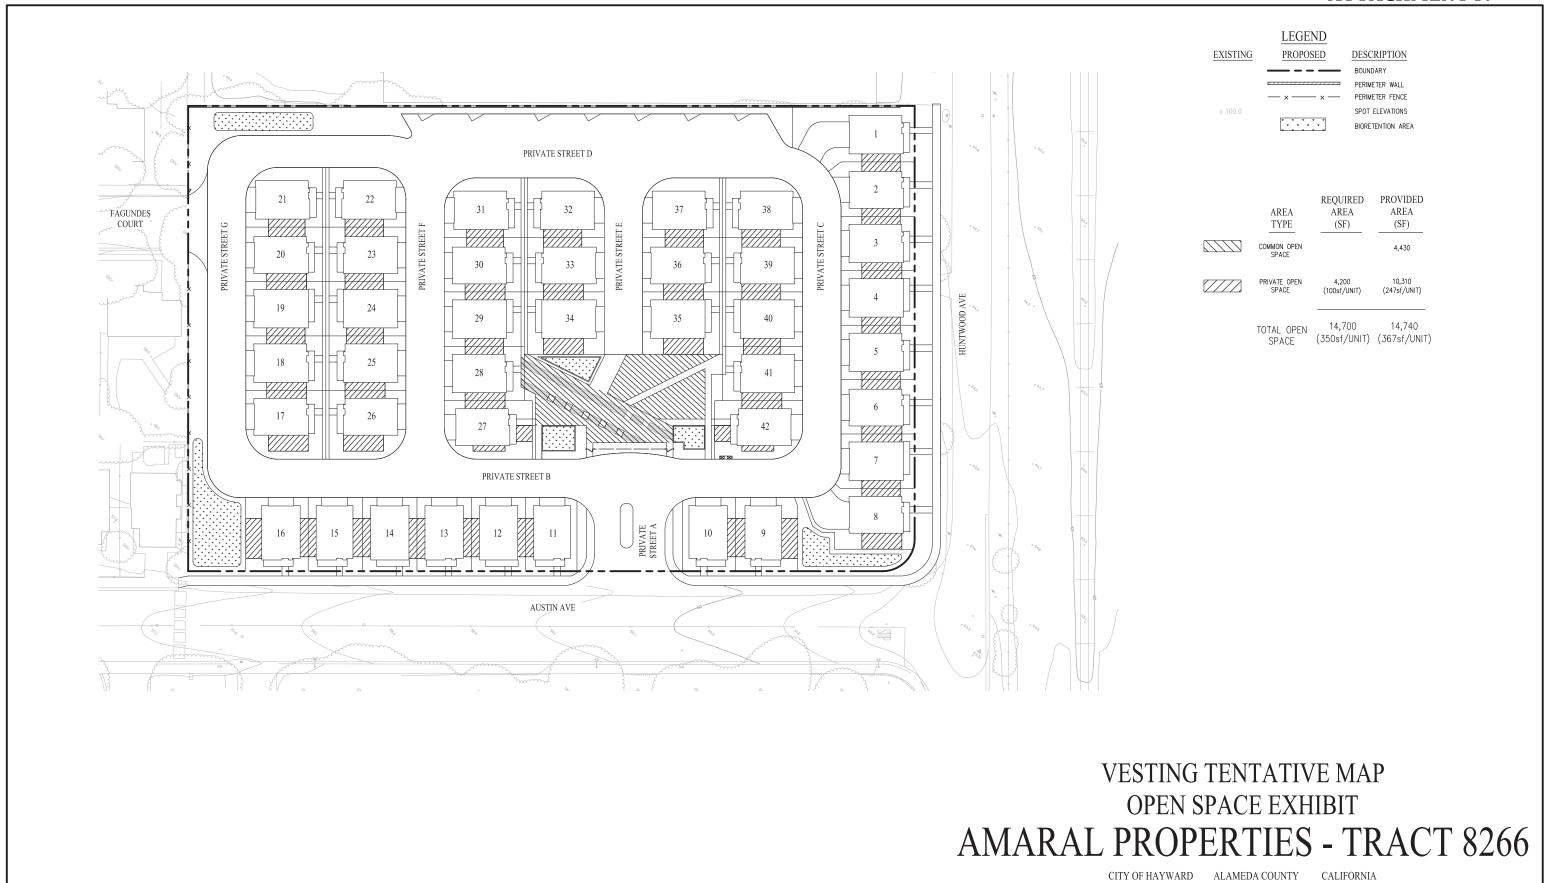

cbg

DATE: SEPTEMBER 28, 2015

2633 CAMINO RAMON, SUITE 350 SAN RAMON, CALIFORNIA 94583

Carlson, Barbee

SHEET NUMBER

TM.5

# **AMARAL PROPERTY**

# PLANNED DEVELOPMENT SUBMITTAL

HAYWARD, CALIFORNIA

13. ALL STREET TREES TO BE INSTALLED IN ACCORDANCE WITH THE STANDARDS AND SPECIFICATIONS OF THE CITY.

14. ALL TREES WITHIN 5' OF PAVING AREAS SHALL HAVE DEEP ROOT BARRIERS INSTALLED. DEEP ROOT BARRIER MODEL NO. UB-36.2. (415) 344,1464.

IS. THE LANDSCAPE CONTRACTOR SHALL AS A PART OF THIS BID PROVIDE FOR A PLANTING ALLOWANCE FOR THE AMOUNT OF \$1,500.00 (ONE THOLISM) FOR HUNDRED DOLLARS, TO BE USED FOR SUPPLYING AND INSTALLING ADDITIONAL PLANT MATERIAL AS DIRECTED BY THE LANDSCAPE ARCHITECT AND APPROVED BY THE OWNER IN WRITING. THE UNUSED PORTION OF THE ALLOWANCE SHALL BE RETURNED TO THE OWNER AT THE BEGINNING OF THE MAINTENANCE PERIOD.

16. CONTRACTOR SHALL EXCAVATE ALL LIME-TREATED SOILS FROM ALL PLANTING AREAS.

17. ADJACENT TO CURBS OR PAVING, CONTRACTOR TO HOLD CENTER

18. THE LANDSCAPE CONTRACTOR IS TO PROVIDE AN AGRICULTURAL

SUITABILITIES ANALYSIS AND PERCOLATION TEST VERIFYING 3" PER

OF PLANTINGS + THE DISTANCE OF THE ON-CENTER SPACING.

HOUR DRAIN RATE FOR ON-SITE AND IMPORTED TOPSOIL RECOMMENDATIONS FOR AND INFOCURED TOPSOIL.

RECOMMENDATIONS FOR ANEIONMENTS AND DRAINAGE SOLUTIONS
CONTAINED IN THIS ANALYSIS, SHALL BE CARRIED OUT BEFORE
PLANTING OCCURS IF DRAINAGE IS FOUND TO NOT AT A PROPER RATE.

# PROJECT DIRECTORY

5000 EXECUTIVE PARKWAY, SUITE 125 SAN RAMON, CA 94583 PH: (925) 983-4521 CONTACT: JOHN COMPAGLIA

### LANDSCAPE ARCHITECT

GATES + ASSOCIATES 271 CROW CANYON ROAD SAN RAMON, CA 94583 PH: (925) 736-8176 CONTACT: LINDA GATES

### **ARCHITECT**

SDG ARCHITECTURE+ENGINEERING 3361 WALNUT BOULEVARD, SUITE 120 BRENTWOOD, CA 94513 PH: (925) 634-7000 CONTACT: RALPH STRAUSS

#### CIVIL ENGINEER

CARLSON, BARBEE & GIBSON 2633 CAMINO RAMON, SUITE 350 PH: (925) 866-0322 CONTACT: LEE ROSENBLATT

LOCATION MAP

# SHEET INDEX

COVER SHEET

NOTES AND LEGENDS

TREE REMOVAL AND PRESERVATION PLAN

CONCEPTUAL LANDSCAPE PLAN

CONCEPTUAL ENLARGEMENT PLAN

**DETAILS** 

L-6 DETAILS

L-7 DETAILS

CONCEPTUAL IRRIGATION PLAN

CONCEPTUAL IRRIGATION NOTES AND LEGEND

L-10 CONCEPTUAL IRRIGATION DETAILS

CONCEPTUAL IRRIGATION DETAILS

PROJECT SITE

- Money Cortolli High School

II. ALL ON-GRADE PLANTING AREAS ARE TO RECEIVE IRON AND

SOIL TO FINISH GRADE.

-- SCHEMATIC CONCEPT PLANS WERE BASE ON CITY OF HAYWARD'S --Schematic Concept Plans were base on City of Haywardus water conservation in Landscaping Regulations Guidelines and Checklist. Following City's Approval of PD Submittal Documents, the Construction Documents shall also Follow City of Haywards water Conservation in Landscaping

# LAYOUT NOTES

- CONDITIONS AND DIMENSIONS IN THE FIELD PRIOR TO COMMENCING WORK ALL DISCREPANCIES OR QUESTIONS SHALL BE BROUGHT TO THE ATTENTION OF THE LANDSCAPE
- ARCHITECT FOR RESOLUTION.
  ALL WRITTEN DIMENSIONS SUPERSEDE ALL SCALED DISTANCES ALL WHIT TEN DIFFERSIONS SUPERSEDE ALL SCALED USI TANCES AND DIMENSIONS. DIMENSIONS SHOWN ARE FROM THE FACE OF THE BUILDING, WALL, BACK OF CUBB, EDGE OF WALK, PROPERTY LINE, OR CENTREUNE OF COLUMIN UNLESS OTHERWISE NOTED ON THE DRAWINGS.

  ALL ANGLES ARE 45 DEGREE, 90 DEGREE, OR 135 DEGREE UNLESS ALL ANGLES ARE 45 DEGREE, 90 TO SERVE.
- SEE IRRIGATION SCHEMATIC FOR GENERAL SYSTEM REQUIREMENTS AND FOR LOCATION OF IRRIGATION MAINLINE PIPING. SLEEVES TO ACCOMMODATE IRRIGATION PIPING. SIZED AS NEEDED, SHALL BE PLACED UNDER AND THROUGH SLABS
- WIDTH OF THE WALKWAY, UNLESS OTHERWISE SHOWN.

- THE SEAT WALL AND THE LAWN AREA, AS WELL AS ALONG THE EDGE OF THE RUBBER SURFACING PLAY AREA.
- 10. HANDRAILS ARE ONLY REQUIRED AT EACH RESIDENCE WHEN

# PLANTING NOTES

I. ALL WORK SHALL BE PERFORMED BY PERSONS FAMILIAR WITH PLANTING WORK AND UNDER THE SUPERVISION OF A QUALIFIED

2. PLANT MATERIAL LOCATIONS SHOWN ARE DIAGRAMMATIC AND MAY BE SUBJECT TO CHANGE IN THE FIELD BY THE LANDSCAPE ARCHITECT.

3. ALL TREES ARE TO BE STAKED AS SHOWN ON THE TREE

4. PLANT COUNT IS FOR THE CONVENIENCE OF THE CONTRACTOR. IN CASE OF DISCREPANCIES, THE PLAN SHALL GOVERN.

5. PLANT LOCATIONS ARE TO BE ADJUSTED IN THE FIELD AS NECESSARY TO SCREEN UTILITIES BUT NOT TO BLOCK WINDOWS NOR IMPEDE ACCESS.

7. BRANCHING HEIGHT OF TREES SHALL BE A 6'-0" MINIMUM ABOVE FINISH GRADE.

8. ALL TREES IN A FORMAL GROUP PLANTING SHALL BE MATCHING IN SIZE AND SHAPE.

9 LANDSCAPE CONTRACTOR SHALL HIRE AN ACCREDITED SOILS ANALYSIS FIRM TO TEST SOIL AND ABIDE BY RECOMMENDATIONS CONTAINED WITHIN FOR PROPER PLANT GROWTH.

10. ON GRADE PLANTING BACKFILL MIX SHALL CONSIST OF 50% IMPORTED TOPSOIL, 50 % NATIVE SOIL (WITH NO ROCKS LARGER THAN 2" DIAMETER).

6 CUBIC YARDS/1000 SQUARE FEET, EVENLY TILLED 6" DEEP INTO THE

12. ALL PLANTING AREAS SHALL BE TOP-DRESSED WITH 3" LAYER OF SALT WATER FREE FIR BARK MULCH HAVING A MAXIMUM SIZE OF 3/4" DIAMETER.

# **GENERAL NOTES**

-FOR BIO-RETENTION AREA CROSS-SECTION, SEE CIVIL DRAWINGS

- ALL CURVES AND ALL TRANSITIONS BETWEEN CURVES AND STRAIGHT EDGES SHALL BE SMOOTH.
- AND WALLS, PRIOR TO POURING. SCORE LINES IN SIDEWALKS SHALL BE SPACED TO EQUAL THE
- WIDTH OF THE WALKWAY, UNLESS OTHERWISE SHOWN. EXPANSION, JOINTS IN SIDEWALKS SHALL BE 30" ON CENTER MAXIMUM AND AS SHOWN ON THE PLANS. EXPANSION JOINTS SHALL BE PLACED AT THE INTERFACE OF WALLS AND BUILDINGS AND AT THE CHANGE OF DIRECTION OF TRAVEL. BUILDING LAYOUT AND LOCATION, SIDEWALK, CURB AND GUTTER, GRADING AND DRAINAGE IS BASED ON DRAWINGS PREPARED BY THE ARCHITECT AND THE CIVIL ENGINEER.
- SEE FLECTRICAL ENGINEER'S PLANS AND LIGHTING PLAN FOR
- 6" CONCRETE MOW BAND SHALL BE INSTALLED IN BETWEEN

# WATER EFFICIENT LANDSCAPE STATEMENT

THE IRRIGATION SYSTEM SHALL BE DESIGNED TO MEET CURRENT WATER EFFICIENCY STANDARDS AND STATE MODEL WATER EFFICIENT LANDSCAPE ORDINANCE AB 1881 AS REQUIRED BY LOCAL JURISDICTIONS WHILE ACHIEVING THE GOAL OF EFFECTIVELY AND EFFICIENTLY PROVIDING THE LANDSCAPE WITH WATER BY MEANS OF HIGH EFFICIENCY SPRAY IRRIGATION TO THE TURE AND GROUND COVER AREAS AND DRIP IRRIGATION BUBBLERS TO RESTRICTED SHRUB PLANTING AND SHRUB MASS PLANTING AREAS AS APPLICABLE.

IRRIGATION SYSTEMS FOR LANDSCAPES GREATER THAT 5,000 SF SHALL HAVE A DEDICATED WATER METER FOR IRRIGATION.

A WATER EFFICIENT LANDSCAPE WORKSHEET SHALL BE INCLUDED WITH HYDROZONE INFORMATION TABLE, WATER BUDGET CALCULATIONS AND IRRIGATION OPERATION SCHEDULES.

A STATE OF THE ART ET BASED SELF ADJUSTING IRRIGATION CONTROLLER SHALL BE SPECIFIED FOR THIS PROJECT TO AUTOMATICALLY CONTROL. THE WATER ALLOCATED TO EACH VALVE GROUPED PER INDIVIDUAL HYDROZONE (BASED ON PLANT TYPE AND EXPOSUES). THIS SHALL INCLUDE RAIN AND FLOW SENSORS AS PPLICABLE FOR A HIGHER LEVEL OF WATER CONSERVATION.

TREE BUBBLERS SHALL BE INCLUDED ON SEPARATE CIRCUITS TO ISOLATE THE IRRIGATION TO THE TREES AND PROVIDE DEEP WATERING TO PROMOTE A DEEPER ROOT STRUCTURE

SPRAY IRRIGATION SYSTEMS FOR GROUNDCOVER AREAS GREATER THAN 8 WIDE IN ANY DIRECTION SHALL BE STANT INMUNITION 33 37 EPIS YOU AND CONTROLLED BY A STAND AND THE THINK YOU AND THE MINISTER STAND STAND. BE DESIGNED WITH COMMERCIAL SERIES SPRAY HEADS WITH HIGH EFFICIENCY NOZZIES THAT INCLIDE STAND. CHECK VALVES AND PRESSURE COMPENSATION EDVICES. THE HEADS SHALL BE DESIGNED IN 3 HE HEAD TO HEAD LAYOUT TO A CHIEVE AN EVEN LEVEL OF PRESIDENT AND OF THE REPORT OF STAND OF THE NEW TO THE PROZEST OF THE PROPERTY OF THE PROPER DELIVER WATER AT MINIMUM 70% EFFICIENCY WITH A LOW PRECIPITATION RATE THAT MATCHES THE INFILTRATION RATE OF THE SOIL

THE DRIP SYSTEM WILL INCORPORATE PRESSURE COMPENSATING DRIP BUBBLERS WITH 1/4" DRIP TUBES TO EACH PLANT WHICH DELIVERS WATER AT 90% EFFICIENCY AT AN APPLICATION RATE THAT MATCHES THE SOIL TYPE.

# **GATES** +ASSOCIATES

**ATTACHM** 

LANDSCAPE ARCHITECTURE LAND PLANNING . URBAN DESIGN

2671 CROW CANYON RD. SAN RAMON, CA 94583

**AMARAL PROPERTY** 

HAYWARD, CA

ISSUE: DESCRIPTION ISSUE I SITE REVIEW ISSUE 2 SITE REVIEW

DATE: 05/27/2015



PROJECT NUMBERS


CHECK: DATE: SCALE:

05/27/2014

MNO



**COVER SHEET** 

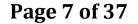

# LAYOUT LEGEND

6' ORNAMENTAL IRON FENCE AND GATES

6' LATTICE TOP FENCE

	PEDESTRIAN CONCRETE PAVING FINISH: MEDIUM BROOM COLOR: STANDARD GREY		SCORELINE
	ALL PEDESTRIAN CONCRETE PAVING AT PATIO SHALL BE STANDARD GREY COLOR WITH SALT FINISH.	EI	EXPANSION JOINT
	INTEGRAL COLOR CONCRETE PAVING FINISH: SALT COLOR: TBD	*	POINT OF BEGINNING
		TYP.	TYPICAL
	STAMPED ASPHALT PAVING MFR: STREETPRINT BY IPC (Integrated Paving Concept) (888) 581-2899	EQ.	EQUAL
H H	PATTERN: TBD COLOR: TBD	s.c.d.	SEE CIVIL'S DRAWINGS
		S.A.D.	SEE ARCHITECT'S DRAWINGS
	PERVIOUS CONCRETE PAVERS MFR: BASALITE	S.E.D.	SEE ELECTRICAL'S DRAWINGS
لنخت	MODEL: TBD COLOR: TBD	SIM	SIMILAR
	DECOMPOSED GRANITE PAVING WITH BINDER	R	RADIUS - ALL RADII GIVEN FOR WALLS ARE DIMENSIONED TO OUTSIDE OF WALLS.
Tree Pro	COLOR: CALIFORNIA GOLD	A	ALIGN
		£	CENTER LINE
:	LOOP BIKE RACK MFR: DUMOR	SP.	SPACING
•	MODEL: 83 COLOR: BLACK	F.O.C.	FACE OF CURB
	CONTACT: WWW.DUMOR.COM INSTALL PER MFG SPECS		BIO-RETENTION IN PLANTING AREAS, S.C.D
MMM	MAILBOX CLUSTER MFR: CUSTOM HOME ACCESSORIES PH: (916) 987-7787 MODEL: REGENCY KIT CLUSTER BOX UNITS STYLE: SALSBURY 3300 SERIES (WITHOUT PEDESTAL COVER) COLOR: BLACK INSTALL PER MFG SPECS	PA	PLANTING AREA
Ò	ACQUIRE APPROVAL FROM POST OFFICE PRIOR TO ORDERING.  TABLE  MFR: LANDSCAPE FORMS PH: (800) 521-2546  MODEL: CHARLIE - ADA COMPLIANT 67" TABLE WITHOUT UMBRELLA HC COLOR: BLACK INSTALL PER MFG SPECS	DLE	

# PLANT LIST

					O.C.	WATER REQ.	5	CA NATIVE/
JANTITY	SYMBOL	BOTANICAL NAME	COMMON NAME	SIZE	SPACING		REF.	MED.
	AM	Arbutus 'Marina'	NCN	15 Gal.	As Shown	OCC-INF	EBMUD	Mediterranean
	AR	Acer rubrum 'Red Sunset'	Red Maple	15 Gal.	As Shown	MOD	WUCOLS	
	CR	Ceanothus 'Ray Hartman' (Std.)	Ceanothus	15 Gal.	As Shown	LOW	WUCOLS	
	ED	Elaocarpus dicipens	Japanese Blueberry	15 Gal.	As Shown	MOD	WUCOLS	44
	LM	Lagerstroemia indica 'Muskogee' (Std.)	Crape Myrtle	15 Gal.	As Shown	LOW	WUCOLS	
	LN	Lagerstroemia indica 'Natchez' (Std.)	Crape Myrtle	15 Gal.	As Shown	LOW	WUCOLS	
	PC	Pistachia chinensis	Chinese Pistache	15 Gal.	As Shown	LOW	WUCOLS	
	TC	Tilia cordata	Little Leaf Linden	15 Gal.	As Shown	MOD	WUCOLS	
	ZE	Zelkova s. 'Musaschino'	Sawleaf Zelkova	15 Gal.	As Shown	MOD	WUCOLS	**
HRUB/ PEREN	NNIALS				O.C.	WATER REO.		CA NATIVE/
JANTITY	SYMBOL	BOTANICAL NAME	COMMON NAME	SIZE	SPACING		REF.	MED.
	AT	Achillea tomentosa 'King George'	Woolly Yarrow	I Gal.	1'-6"	OCC-INF	EBMUD	Mediterranean
	- AW	Agapanthus 'Rancho White'	Lily-of-the-Nile	I Gal.	1'-6"	OCC	EBMUD	Mediterranear
	BU	Buxus sempervirens 'Green Mountain'	Boxwood	I Gal.	3'-0"	INF-NONE	EBMUD	CA Native
	CO	Coleonema 'Sunset Gold'	Pink Breath of Heaven	I Gal.	2'-6"	MOD	WUCOLS	
	* CP	Coprosma hybrids 'Tequila Sunrise'	Mirror Plant	I Gal.	4'-0"	OCC-INF	EBMUD	Mediterranean
	. CS	Cistus x. argentius 'Silver Pink'	Rockrose	I Gal.	4'-0"	OCC-INF	EBMUD	Mediterranean
	CU	Cuphea hyssopifolia 'Caribbean Sunset'	False Heather	I Gal.	2'-0"	OCC-INF	EBMUD	Mediterranear
	DG	Dietes grandiflora 'Variegata'	Variegated Fortnight Lily	I Gal.	3'-0"	LOW	WUCOLS	
	EG	Euonymus fortunei 'Golden Prince'	NCN	I Gal.	3'-6"	LOW	WUCOLS	
	* HA	Hebe x andersonii	Hebe	I Gal.	5'-0"	MOD	WUCOLS	***
	* HO	Hebe odora	Boxleaf Hebe	I Gal.	5'-0"	MOD	WUCOLS	
	HR	Hemerocallis Terra Cotta Baby	Evergreen Daylily	I Gal.	2'-0"	LOW	WUCOLS	-
	HY	Hemerocallis hybrids 'Yellow'	Evergreen Daylily	I Gal.	2'-6"	MOD	WUCOLS	***
	HS	Helictotrichon sempervirens	Blue Oat Grass	I Gal.	2'-6"	MOD-OCC	EBMUD	CA Native
	* LI	Liriope gigantea	Giant Lily Turf	I Gal.	2'-6"	LOW	WUCOLS	
	LA	Lavatera assurgentifolia	Tree Mallow	5 Gal.	6'-0"	LOW	WUCOLS	Mediterranear
	LT	Lavatera thuringiaca 'Red Rum'	Tree Mallow	I Gal.	4'-0"	LOW		Mediterranear
	* MC	Myrtus communis	Myrtle	I Gal.	2'-0"	LOW	WUCOL	
	* MC	Myrtus communis 'Compacta'	Dwarf Myrtle	I Gal.	4'-0"	LOW	WUCOL	
	ND	Nandina domestica 'Plum Passion'	Heavenly Bamboo	I Gal.	4'-0"	LOW	WUCOLS	
		Phormium 'lester'	New Zealand Flax	l Gal.	1'-6"	LOW	WUCOLS	
	- PJ	Phormium 'Yellow Wave'	New Zealand Flax	I Gal.	4'-0"	LOW	WUCOLS	
	SL	Salvia leucantha 'Santa Barbara'	Mexican Bush Sage	I Gal.	4'-0"	OCC	EBMUD	

	* EG	Euonymus fortunei 'Golden Prince'	NCN	I Gal.	3'-6"	LOW	WUCOLS	**
	: HA	Hebe x andersonii	Hebe	I Gal.	5'-0"	MOD	<b>WUCOLS</b>	
	* HO	Hebe odora	Boxleaf Hebe	I Gal.	5'-0"	MOD	WUCOLS	
	HR	Hemerocallis Terra Cotta Baby	Evergreen Daylily	I Gal.	2'-0"	LOW	WUCOLS	
	HY	Hemerocallis hybrids 'Yellow'	Evergreen Daylity	I Gal.	2'-6"	MOD	WUCOLS	
	HS	Helictotrichon sempervirens	Blue Oat Grass	I Gal.	2'-6"	MOD-OCC	EBMUD	CA Native
	* LI	Liriope gigantea	Giant Lily Turf	I Gal.	2'-6"	LOW	WUCOLS	
	LA	Lavatera assurgentifolia	Tree Mallow	5 Gal.	6'-0"	LOW		Mediterranean
	LT	Lavatera thuringiaca 'Red Rum'	Tree Mallow	I Gal.	4'-0"	LOW		Mediterranean
	* MC	Myrtus communis	Myrtle	I Gal.	2'-0"	LOW	WUCOLS	
	* MC	Myrtus communis 'Compacta'	Dwarf Myrtle	I Gal.	4'-0"	LOW	WUCOLS	CA Native
	ND	Nandina domestica 'Plum Passion'	Heavenly Bamboo	I Gal.	4'-0"	LOW	WUCOLS	
	· PJ	Phormium 'Jester'	New Zealand Flax	I Gal.	1'-6"	LOW	WUCOLS	
	PY	Phormium 'Yellow Wave'	New Zealand Flax	I Gal.	4'-0"	LOW	WUCOLS	***
	SL	Salvia leucantha 'Santa Barbara'	Mexican Bush Sage	I Gal.	4'-0"	OCC	EBMUD	
	SV	Salvia leucophylla Figueroa'	Purple Sage	5 Gal.	6'-0"	OCC	EBMUD	CA Native
	TF	Teucrium fruticans 'Compactum'	Bush Germander	I Gal.	2'-6"	OCC	EBMUD	Mediterranean
GROUNDCOV	/ERS				200			
	200000000000000000000000000000000000000	and the second s		14114	O.C.	WATER REQ.		CA NATIVE/
QUANTITY	SYMBOL	BOTANICAL NAME	COMMON NAME	SIZE	SPACING			MED.
	• FC	Erigeron karvinskainus Festuca californica	Santa Barbara Daisy California Fescue	I Gal. I Gal.	3'-0" 1'-6"	OCC-INF LOW	WUCOLS	CA Native CA Native
	. GZ	Gazania	Gazania	I Gal.	12"	OCC	EBMUD	***
	HM	Heuchera micrantha 'Painted Lady	Coral Bells	Gal.	2'-0" 3'-0"	MOD-OCC	EBMUD	CA Native
	RR	Rosa 'Carpet Rose Red'	Red Carpet Rose			LOW	WUCOLS	
	RW	Rosa 'Carpet Rose White'	White Carpet Rose	I Gal.	3'-0"	LOW	WUCOLS	
	RY	Rosa 'Carpet Rose Yellow'	Yellow Carpet Rose	I Gal.	3"-0"	LOW	WUCOLS	***
	TL	Teucrium lucidrys 'Prostratum'	Germander	I Gal.	3'-6"	OCC-INF	EBMUD	Mediterranean
CDASS								

GRASS		U DOSEMICO (MARIO)		2822	O.C.	WATER REQ.	Dick.	CA NATIVE/
QUANTITY	SYMBOL	BOTANICAL NAME	COMMON NAME	SIZE	SPACING		REF.	MED.
	CH	Chondropetalum tectorum	Cape Rush	I Gal.	3'-6"	MOD	EBMUD	44
	CT	Carex tumulicola	Berkeley Sedge	I Gal.	2'-0"	OCC	EBMUD	CA Native
	IP	Juncus patens	California Gray Rush	I Gal.	2'-0"	OCC	EBMUD	CA Native
	ST	Stipa tenuissima	Mexican Feather Grass	I Gal.	2'-6"	MOD-OCC	EBMUD	
VINES								
				0.000	O.C.	WATER REQ.		CA NATIVE/
QUANTITY	SYMBOL	BOTANICAL NAME	COMMON NAME	SIZE	SPACING		REF.	MED.
	GS	Gelsemium sempervirens	Carolina Jessamine	5 Gal.	as shown	MOD	WUCOL	S
	* ML	Mandevilla laxa	Chilean Jasmine	5 Gal.	as shown	MOD	WUCOLS	S
	SI	Solanum jasminoides	Potato Vine	5 Gal.	as shown	MOD	WUCOLS	S
	PT	Parthenocissus tricuspidata	Boston Ivy	I Gal.	as shown	MOD	WUCOLS	5

NOTE: \*\*\* ARE PLANTS APPROPRIATE FOR SHADE LOCATIONS.

SC	D	_				
•		+		•		BIOFILTRATION SOD
			ē		~]	AVAILABLE FROM DELTA BLUE GRAS
			٠			(800) 637-8873 OR APPROVED EQUA

# WATER USE RATING LEGEND

	GORIES OF WATER NEEDS FROM: DSCAPES FOR SUMMER DRY CLIMATES	WUCOLS III CATEGORIES OF WATER NEEDS FROM: UNIVERSITY OF CALIFORNIA COOPRATIVE EXTENSION.
OF THE SAN FI	RANCISCO BAY REGION IAY MUNICIPAL UTILITY DISTRICT, 2004	CALIFORNIA DEPARTMENT OF WATER RESOURCES, UNITED STATES BUREAU OF RECLAMATION
MOD	MODERATE WATER	HIGH
occ	OCCASIONAL WATER	MODERATE
INF	INFREQUENT WATER	LOW

NF	INFREQUENT WAT	ER	LOW
NONE	NO ADDITIONAL W	/ATER	VERY LOW
ON-SITE	TOTAL PLANTS		TS WITH OCC/INF/NO

N-SITE	TOTAL PLANTS	SUBTOTAL PLANTS WITH OCC/INF/NONE /LOW/VERY LOW WATER REQUIREMENTS
	×	×

# PLANTING LEGEND

XX	TREE NAME QUANTITY	
(xx)	SHRUB NAME QUANTITY	
$\left\langle \begin{array}{c} \times \times \\ - \end{array} \right\rangle$	GROUNDCOVER QUANTITY	
\xx x	VINE QUANTITY	

# E LEGEND

CALIFORNIA NATIVE PLANTS (CNP) FOR THE GARDEN, 2005 BY CAROL BORNSTEIN, DAVID FROSS,, BART O'BRIEN

MOD MODERATE WATER OCC OCCASIONAL WATER INF INFREQUENT WATER

Botanical Name	Common Name
Lagerstroemia i. 'N	Natchez' Crape Myrtle
Tilia cordata	Little Leaf Linden
Pistachia chinensis	Chinese Pistache
Elaocarpus diciper	Japanese Blueberry
Acer rubrum 'Red	Sunset' Red Maple
Ceanothus 'Ray H	artman Std. California Wild Lilac
Arbutus 'Marina'	NCN



**GATES** 

LANDSCAPE ARCHITECTURE LAND PLANNING · URBAN DESIGN

2671 CROW CANYON RD. SAN RAMON, CA 94583

**AMARAL PROPERTY** 

HAYWARD, CA

ISSUE: DESCRIPTION: ISSUE I SITE REVIEW ISSUE 2 SITE REVIEW



DATE: 05/27/2015

MNO

DG

PROJECT NUMBER:

CHECK: DATE: SCALE:

LAYOUT AND PLANTING LEGEND

STREET TREE MITIGATION SUMMARY CHART:

ATTACHMENT IV

\*

TREES TO BE REMOVED

TREES TO BE PRESERVED IN PLACE

0

TREES TO BE RELOCATED

			Condition					Driplines (ft)				
			1=Poor	Suitability for								
Tree No. Species	Trunk Diameter (in)	Protected	S=Excellent	Preservation	Comments	North	South	East	West	Height (ft)		
163 Fig	12,11,10,9,8,8	yes	4	Moderate	Multiple attachments at 4'; topped; trunk wounds	8	10	12	9			
164 Fig	15, 13, 10, 10	yes	4	Moderate	Multiple attachments at 4'; topped; trunk wounds	15	15	12	17	13		
165 Plum	6	no	3	Moderate	Upright form; Low branch E	10	10	12	- 5			
166 Mulberry	18	yes	3	Moderate	Multiple attachments at 6'; topped; crown formed by epicormics	10	15	12	15			
167 Australian Brush Cherry	8	yes	3	Moderate	Large Hedge	5	5	5	5			
168 Grecian Bay	6,5,4,3,2	yes	4	Moderate	Stump sprouts; many small stems	15	15	15	15			
169 Callery Pear	7,5,5	yes	3	Low	Multiple attachments at 6'; moderate dieback	10	15	10	. 8			
170 Persimon	6,6,5	yes	4	High	Multiple attachments at 4'; good form and structure	10	15	15	12	1		
171 Plum	16	yes	3	Moderate	Multiple attachements at 6'; growing against garage; topped	15	.5	10	12	11		
172 Orange	14,12,11,4	yes	5	High	Multiple attachments at 3'; good form and structure	15	15	15	15			
173 Box Elder	13,12	yes	2	Low	Codominant trunks at base; dead top	12	15	10	18	1		
174 Coast Live Oak	7	yes	5	High	Good young tree	12	10	10	12			
175 Apple	8,7,7	yes	2	Low	Multiple attachements at 3'; dead top; epicormics	18	10	15	10			
176 Coast Live Oak	6,4	yes	5	High	Good young tree	10	10	10	12	1		
177 Blue Oak	12,9,6,4	yes	4	Moderate	Multiple attachments at 4'; one sided E; dieback	18	18	20	8	11		
178 Japanese Maple	8,7,5,4	yes:	4	Moderate	Multiple attachments at 4'; growing in atrium; leans N; high crown	15	10	15	15	2		
179 Coast Redwood	22	yes	4	High	Good form and structure; canopy a little thin.	10	10	10	10	50		
180 Sweetgum	12	yes	3	Low	Lost top; poor form and structure	10	10	10	12			
181 Deodar Cedar	15	yes	3	Moderate	Multiple attachements at 7; poor structure	12	8	125	15	25		
182 Coast Redwood	27	yes	4	High	Good form and structure; canopy a little thin.	10	10	10	10	65		
183 Coast Redwood	31	yes	4	Moderate	Codominant trunks at base; upright form	10	10	10	10			
184 Coast Redwood	24	yes	4	Moderate	Crowded; narrow form	10	10	5	5	70		
185 Coast Redwood	27	yes	4	Moderate	Crowded; narrow form	10	10	5	5	7		
186 Coast Redwood	28	yes	4	Moderate	Crowded; narrow form	10	10	5	5	7		
187 Coast Redwood	31	yes	4	High	Good form and structure; one sided 5	5	13	10	10	7		
188 Buckeye	15, 12, 10, 10, 10, 9, 9, 8, 7	yes	4	Moderate	Mutiple attachements at base; spreading form; 16" stem losing bark	25	20	20	15			
189 Valley Oak	9	yes	5	Hìgh	Good young tree	13	13	12	12	2		
190 White Fir	8	yes	4	Moderate	Sweeps E. from base; low branching	5	5	5	10	1		
191 Coast Redwood	26	yes	4	Moderate	Good form and structure; thin upper canopy	12	10	12	10	4		
192 Australian Brush Cherry	10,9	yes	3	Moderate	Codominant trunks at base; dieback in upper canopy	10	10	10	5			
193 Coast Redwood	19	yes	3	Moderate	Very thin canopy; engulfed in ivy	10	10	10	10	4		
194 Ginkgo	9	yes	4	High	Slight lean SE; low branching	13	10	15	10	4		
195 Blue Gum	57	yes	4	High	Multiple attachments at 5'; good form and structure; trumpet vine in canopy	15	15	15	15	5		
196 Privet	5,5	yes	3	Moderate	Off-site, no tag; codominant trunks at base; extends 10' N over fence	8	8	8	8	1		
197 Chinese Pistache	7	no	4	Moderate	Off-site, no tag; multiple attachments at 5'; extends 5' N over fence	8	8	8	8	10		

	QUANTITY	APPRAISED VALUE	MITIGATION MEASURE
POOR CONDITION/ LOW SUITABILITY TREES/TREE TO BE REMOVED	3	NOT APPRAISED BY ARBORIST	MITIGATION PER CITY
HERITAGE TREES TO BE REMOVED	26	\$97,550 (Total APPRAISED VALUE)	MITIGATION PER CITY
RELOCATED TREES	1	N/A	N/A
TREES TO BE PRESERVED IN PLACE	5	\$44,600	N/A
TOTAL MITIGATION TREES	35		

NOTE: REFER TO ARBORIST TREE ASSESSMENT AND APPRAISAL REPORT DATED MAY 2015 PREPARED BY HORT SCIENCE FOR DETAILED INFORMATION ON TREE ASSESSMENT CHART, TREE APPRAISAL AND TREE PROTECTION PLAN.



**GATES** 

LAND SCAPE ARCHITECTURE LAND PLANNING • URBAN DESIGN 2671 CROW CANYON RD. SAN RAMON, CA 94583

> PROPERTY HAYWARD, CA

HAT WARD, CA

ISSUE: DESCRIPTION:

ISSUE 1 SITE REVIEW
ISSUE 2 SITE REVIEW




**DATE:** 05/27/2015

PROJECT NUMBER: DRAWN: CHECK:

AWN: IECK: .TE: ALE:

0 10 20

TREE REMOVAL PLAN

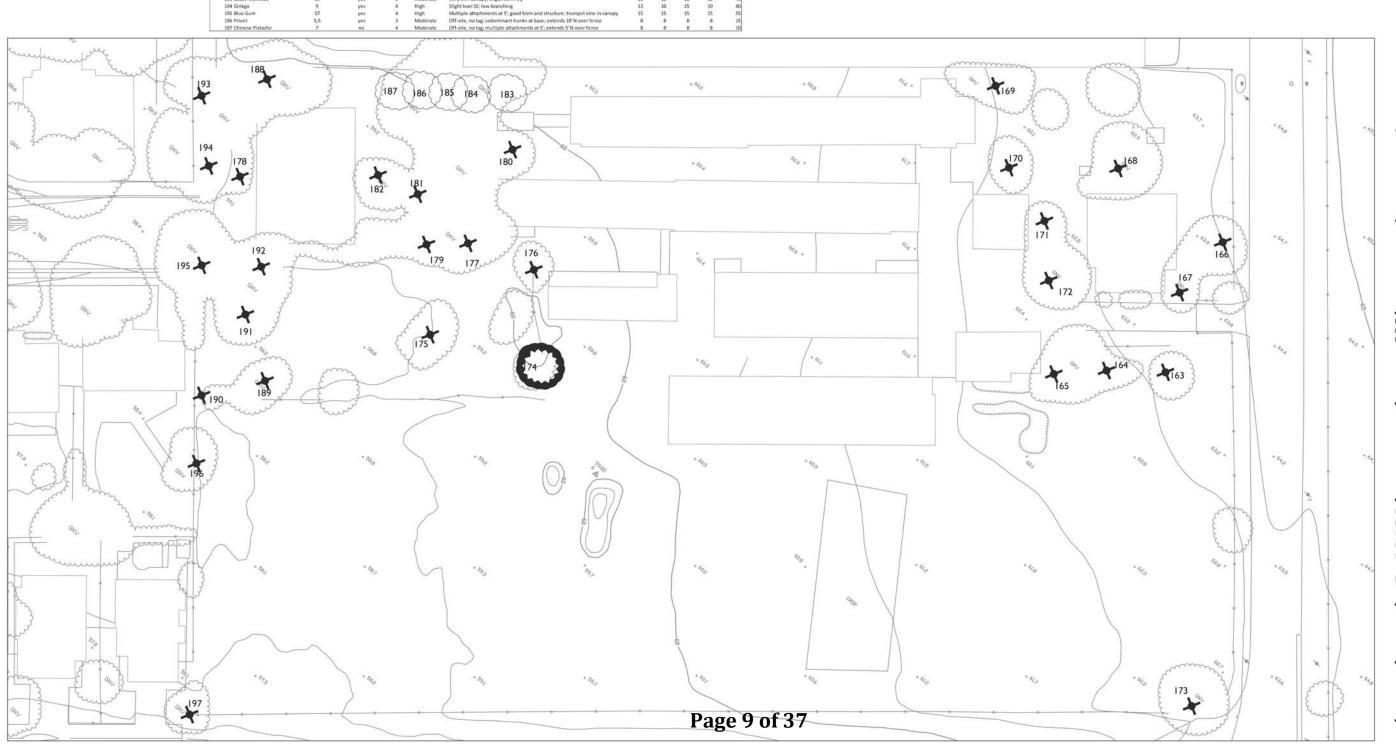



GATES

LANDSCAPE ARCHITECTURE LAND PLANNING • URBAN DESIGN

2671 CROW CANYON RD. SAN RAMON, CA 94583 T 925.736.8176 \_\_www.dgates.com

AMARAL PROPERTY

HAYWARD, CA

ISSUE: DESCRIPTION: ISSUE I SITE REVIEW ISSUE 2 SITE REVIEW

DATE: 05/27/2015 08/06/2015




PROJECT NUMBER: DRAWN: CHECK:

05/ I' 0 10' 20'

© 0 10 20 20 E

LANDSCAPE CONCEPT

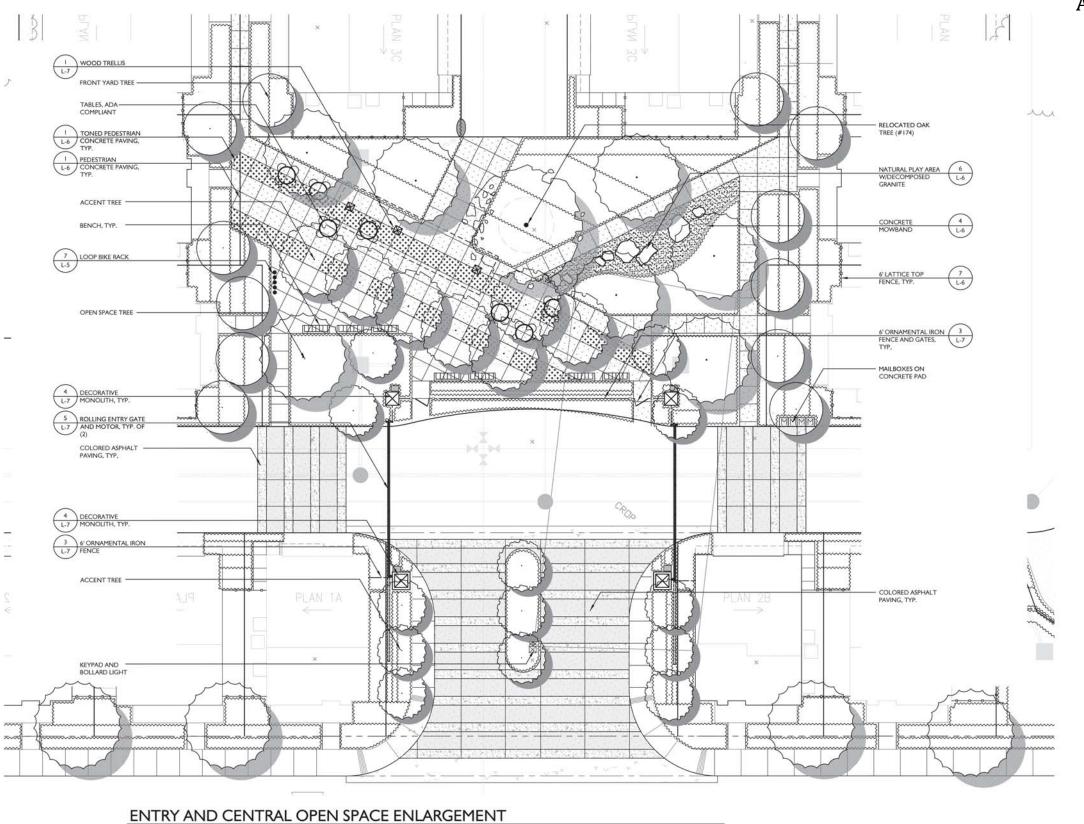

GATES +ASSOCIATES

LANDSCAPE ARCHITECTURE LAND PLANNING · URBAN DESIGN

2671 CROW CANYON RD. SAN RAMON, CA 94583

AMARAL PROPERTY

HAYWARD, CA

ISSUE: DESCRIPTION: ISSUE I SITE REVIEW ISSUE 2 SITE REVIEW



PROJECT NUMBER: DRAWN:


DRAWN: CHECK: DATE: SCALE:

05/27/2

**DATE:** 05/27/2015



CONCEPTUAL ENLARGEMENT PLAN

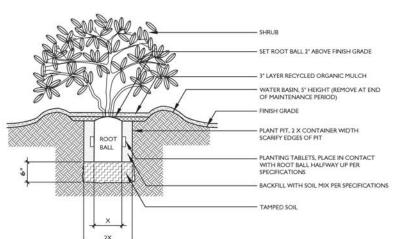

PLANTING LOCATION

Spacing

8° o.c.

12" o.c. 18" o.c. 24" o.c. 30" o.c.

Plant Quantity Chart

# of Plants/S.F.

2.60

SHRUB PLANTING


A. S = PLANT SPACING DISTANCE ON CENTER, SEE CHART

PLANT SPACING


SCALE: N.T.S.

B. FOR USE AS A GUIDE FOR SHRURS AND

GROUNDCOVER WHEN PLANTS ARE SPACED EQUIDISTANT FROM EACH OTHER.

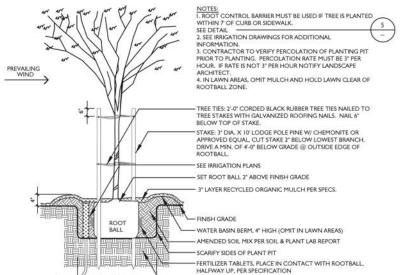

COLOR: BLACK SEE SHEET L-X FOR MFR. INFORMATION

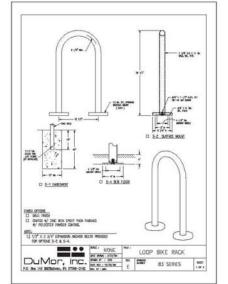



# **GATES** +ASSOCIATES

LANDSCAPE ARCHITECTURE LAND PLANNING . URBAN DESIGN 2671 CROW CANYON RD. SAN RAMON, CA 94583

# **AMARAL PROPERTY**

HAYWARD, CA

ISSUE: DESCRIPTION

05/27/2015

ISSUE I SITE REVIEW ISSUE 2 SITE REVIEW

PROJECT NUMBER DRAWN:


CHECK: DATE:

MNO 05/27/2014

DG

LANDSCAPE DETAILS

TREE STAKING DETAIL - ON SITE

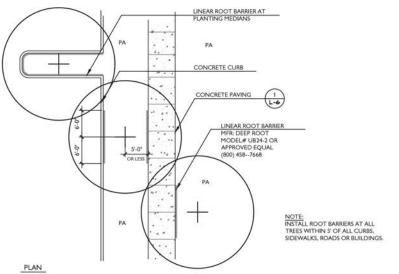


LOOP BIKE RACK SCALE: N.T.S.

SEE SHEET LL0.2 FOR MFR. INFORMATION COLOR: BLACK

**CLUSTER MAILBOX** 

RENAISSANCE STYLE

SCALE: N.T.S.

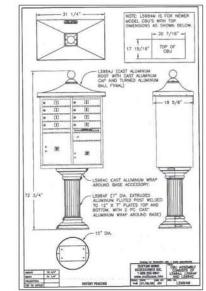

#4 8405 0 24"s.b.m. STEEL TURING IN COLUMN SET CHART.


SECTION A-A

SECTION D-D

SECTION B-B SCALE: 3/8" = 1'-0"

S-1

LINEAR ROOT BARRIER SCALE: 1" = 10'-0"

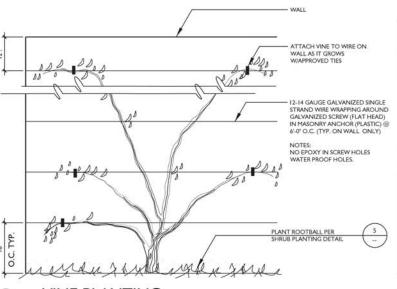

2X4X18° SPLICE BLK @ CORNER SPLICE 2X4 STAKES ALIGN W/SPICE BLK. 2X4X18" SPLICE BLK @ X"x4" RWD LAMINATES ON STRONG CURVED RUNS STAKES 2'-0" O.C. AROUND RADIUS RADIUS

LAMINATED SECTION


SHALL EXTEND 4'-0" MIN
INTO TANGENT 2X4X18 SPLICE BLK. 2" BELOW I" CLEARANCE @ TURF X\* @ SEEDED LAWN 2X4X18° PRESSURE TREATED DOUG FIR STAKES 4'-0" O.C. ON STRAIGHT RUNS, CHAMFER TOP.


VINE PLANTING Page 12 of 37


REDWOOD HEADER

ELEVATION VIEW SECTION C-C

> PRECAST WALL SCALE: N.T.S.

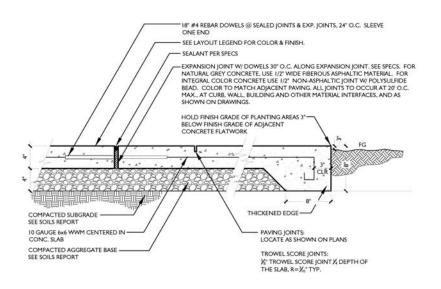

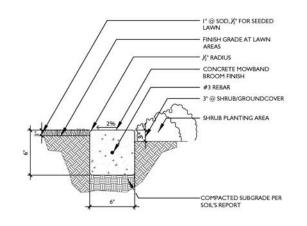

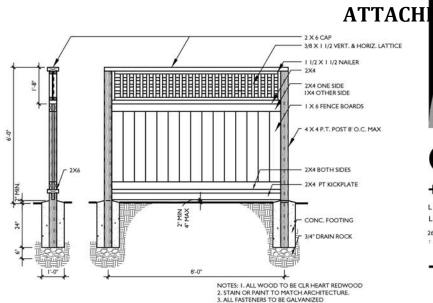

WOOD PRIVACY FENCE W/ LATTICE

EXPANSION JOINT AT SEAT WALL

- I/2" W EXPANSION JOINT — PREMOLDED JT. FILLER MATERIAL RECESS TO ALLOW FOR CAULKING COLOR: TO MATCH SEATWALL COLOR

STOP REBAR @ JOINT

#5 DOWEL, 18" LONG @ 12" O.C. PVC SLIP JT, @ ONE END



+ASSOCIATES

LANDSCAPE ARCHITECTURE LAND PLANNING - URBAN DESIGN 2671 CROW CANYON RD. SAN RAMON, CA 94583

# **AMARAL PROPERTY**

HAYWARD, CA

ISSUE: DESCRIPTION: DATE: ISSUE I SITE REVIEW 05/27/2015 ISSUE 2 SITE REVIEW 08/06/2015

SECTION

SCALE: 3"=1'-0"

CONSTRUCTION JTS. @


CORNERS. 30° O.C. MAX.

CORNER PLAN


PROJECT NUMBER: MNO DRAWN: CHECK: DG DATE: 05/27/2014

LANDSCAPE DETAILS

# PEDESTRIAN CONCRETE PAVING

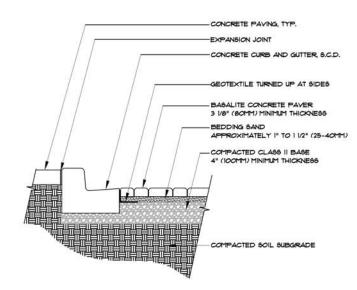


6" CONCRETE MOWBAND

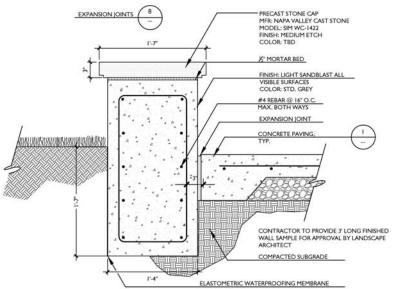

CONCRETE SEATWALL 5


VEHICULAR CONCRETE PAVERS

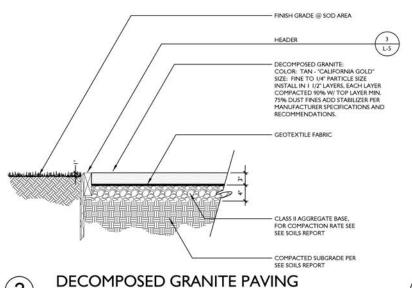


NATURAL PLAY AREA 6

Page 13 of 37

SCALE: I" = I'-0"

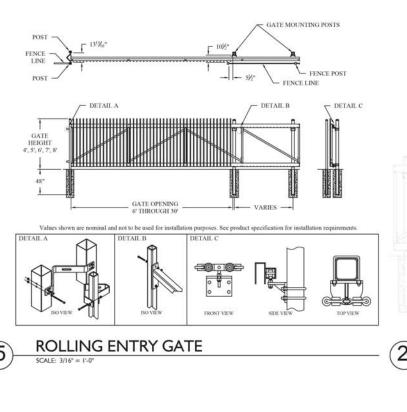

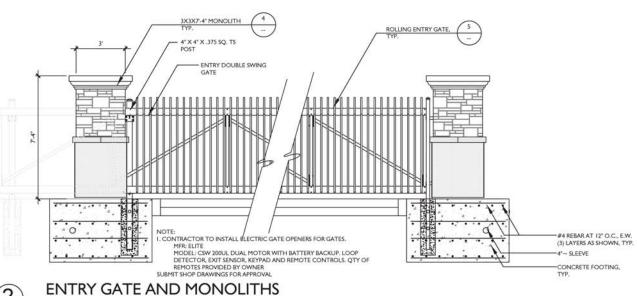

TUBULAR STEEL FENCE TO MATCH ROLLING ENTRY GATES

3X3X7-4" MONOLITH

4" X 4" X .375 SQ. TS

\*\*\*\*\*\* 0 4

8' MAX

**AMARAL PROPERTY** 

**GATES** 

+ASSOCIATES

LANDSCAPE ARCHITECTURE

LAND PLANNING . URBAN DESIGN 2671 CROW CANYON RD. SAN RAMON, CA 94583

**ATTACHMENT IV** 

HAYWARD, CA


ISSUE: DESCRIPTION: DATE: ISSUE I SITE REVIEW 05/27/2015 ISSUE 2 SITE REVIEW 08/06/2015


-#4 REBAR AT 12" O.C., E.W. (3) LAYERS AS SHOWN, TYP. -4"~ SLEEVE



PROJECT NUMBER: MNO DRAWN: CHECK: DG DATE: 05/27/2014

LANDSCAPE DETAILS

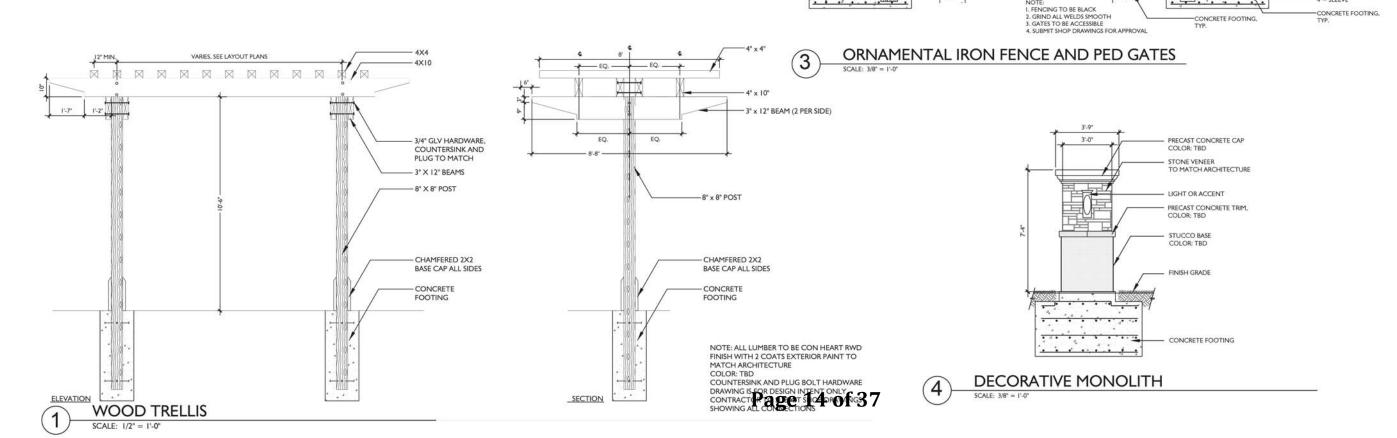

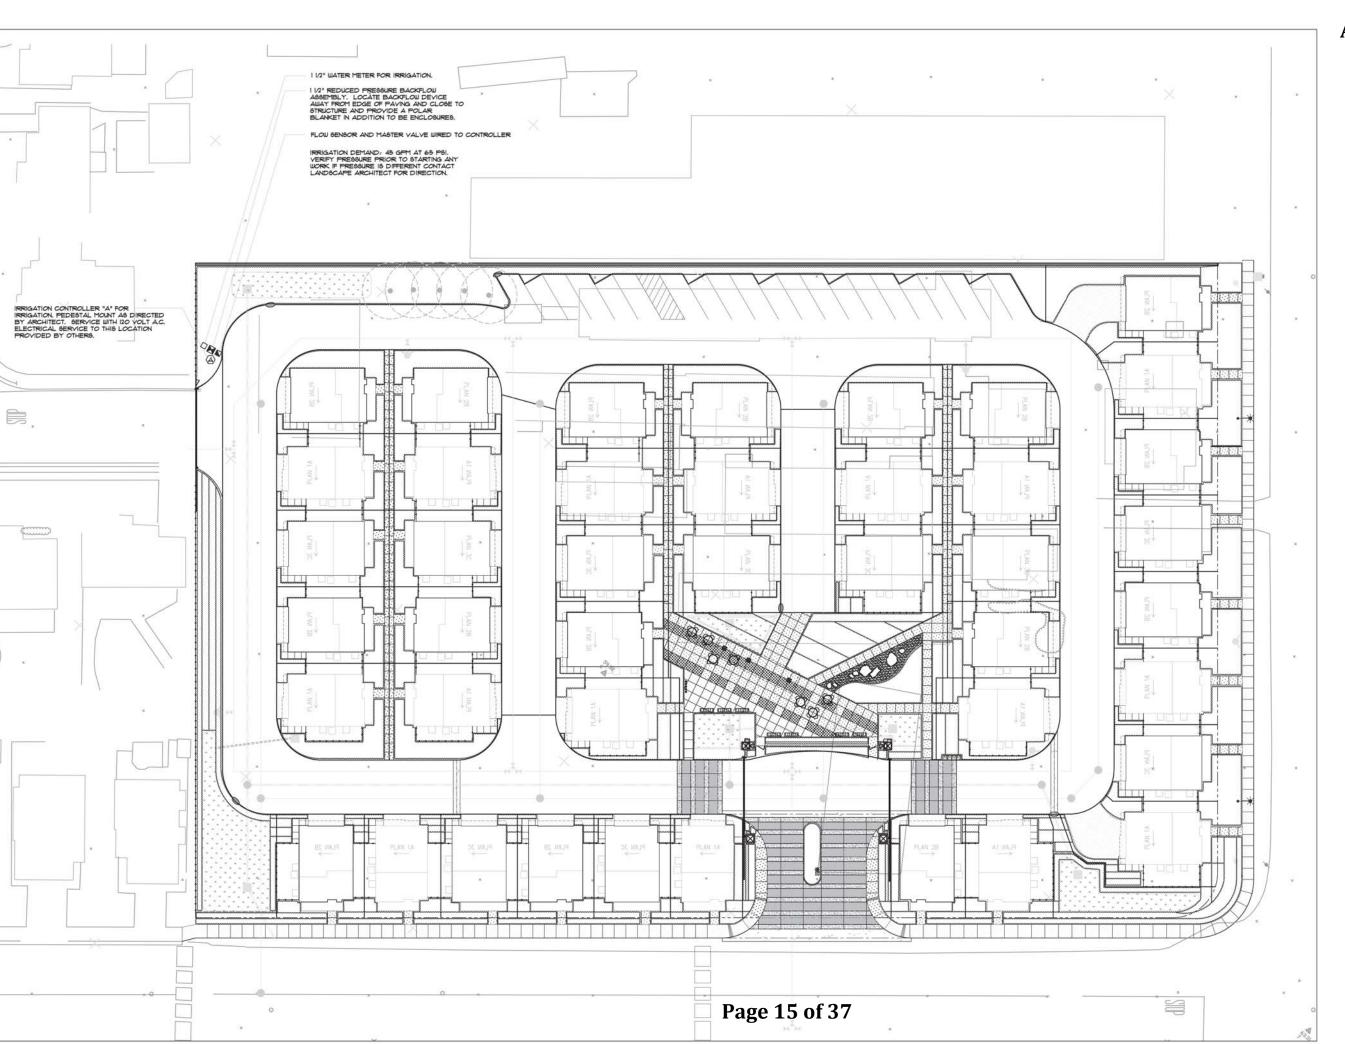



# **GATES** +ASSOCIATES

LANDSCAPE ARCHITECTURE LAND PLANNING . URBAN DESIGN 2671 CROW CANYON RD. SAN RAMON, CA 94583

# **AMARAL PROPERTY**


HAYWARD, CA

ISSUE: DESCRIPTION: ISSUE I SITE REVIEW
ISSUE 2 SITE REVIEW 05/27/2015 08/06/2015

DATE:



PROJECT NUMBER: DRAWN: CHECK: DATE: 1" = 20'-0"

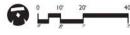

IRRIGATION CONCEPT

#### **IRRIGATION NOTES**

- 1. THIS DESIGN IS DIAGRAMMATIC. ALL PIPING, VALVES, ETC. SHOWN WITHIN PAVED AREAS IS FOR DESIGN CLARIFICATION ONLY AND SHALL DE INSTALLED IN PLANTING AREAS WHERE POSSIBLE. AVOID ANY CONFLICTS BETWEEN THE SPRINKLER SYSTEM, PLANTING AND ARCHITECTURAL FEATURES.
- 2. DO NOT WILLFULLY INSTALL THE SPRINKLER SYSTEM AS SHOWN ON THE DRAWINGS WHEN IT IS OBVIOUS IN THE FIELD THAT OBSTRUCTIONS, GRADE DIFFERENCES OR DIFFERENCES IN THE AREA DIMENSIONS EXIST THAT MIGHT NOT HAVE BEEN CONSIDERED IN THE ENGINEERING. SUCH OBSTRUCTIONS OR DIFFERENCES SHOULD BE BROUGHT TO THE ATTENTION OF THE OWNER'S AUTHORIZED REPRESENTATIVE. IN THE EVENT THAT THIS NOTIFICATION IS NOT PERFORMED, THE IRRIGATION CONTRACTOR SHALL ASSUME FULL RESPONSIBILITY FOR ANY REVISIONS NECESSARY.
- 3. IT IS THE RESPONSIBILITY OF THE IRRIGATION CONTRACTOR TO FAMILIARIZE HIMSELF WITH ALL GRADE DIFFERENCES, LOCATION OF WALLS, RETAINING WALLS, ETC. HE SHALL COORDINATE HIS WORK WITH THE GENERAL CONTRACTOR AND OTHER SUBCONTRACTORS FOR THE LOCATION AND THE INSTALLATION OF PIPE SLEEVES THROUGH WALLS, UNDER ROADWAYS, PAVING, STRUCTURES, ETC.
- 4. DUE TO THE SCALE OF THE DRAWINGS, IT IS NOT POSSIBLE TO INDICATE ALL OFFSETS, FITTINGS, SLEEVES, ETC., WHICH MAY BE REQUIRED. THE CONTRACTOR SHALL CAREFULLY INVESTIGATE THE STRUCTURAL AND FINISHED CONDITIONS AFFECTING ALL OF HIS WORK AND PLAN HIS WORK ACCORDINGLY, FURNISHING SUCH FITTINGS, ETC., AS MAY DE REQUIRED TO MEET SUCH CONDITIONS. DRAWINGS ARE GENERALLY DIAGRAMMATIC AND INDICATIVE OF THE WORK TO DE INSTALLED. THEN WORK SHALL DE INSTALLED IN SUCH A MANNER AS TO AVOID CONFLICTS BETWEEN IRRIGATION SYSTEMS, PLANTING, AND ARCHITECTURAL FEATURES.
- 5. ELECTRICAL CONTRACTOR TO SUPPLY 120 VOLT A.C. (2.5 AMP) SERVICE TO CONTROLLER LOCATION. IRRIGATION CONTRACTOR TO MAKE FINAL CONNECTION FROM ELECTRICAL STUB-OUT TO CONTROLLER.
- 6. EACH CONTROLLER SHALL HAVE ITS OWN INDEPENDENT GROUND WIRE.
- 7. VALVE LOCATIONS SHOWN ARE DIAGRAMMATIC. INSTALL IN GROUND COVER/SHRUB AREAS WHERE POSSIBLE (NOT IN LAWN AREA).
- 8. SPLICING OF 24 VOLT WIRES WILL NOT DE PERMITTED EXCEPT IN VALVE BOXES. LEAVE A 24" COIL OF EXCESS WIRE AT EACH SPLICE AND 100 FEET ON CENTER ALONG WIRE RUN. TAPE WIRE IN BUNDLES 10 FEET ON CENTER. NO TAPING PERMITTED INSIDE SLEEVES.
- 9. INSTALL FOUR (4) SPARE CONTROL WIRES ALONG THE ENTIRE MAIN LINE. LOOP 36" EXCESS WIRE INTO EACH SINGLE VALVE BOX AND INTO ONE VALVE BOX IN EACH GROUP OF VALVES. SPARE WIRES SHALL BE YELLOW, COMMON WIRES SHALL BE WHITE AND CONTROL WIRES SHALL BE RED.
- 10. THE IRRIGATION CONTRACTOR SHALL FLUSH AND ADJUST ALL DRIP TUBES FOR OPTIMUM PERFORMANCE.
- 11. NOTIFY ARCHITECT OF ANY ASPECTS OF LAYOUT WHICH WILL PROVIDE INCOMPLETE OR INSUFFICIENT WATER COVERAGE OF PLANT MATERIAL AND DO NOT PROCEED UNTIL HIS INSTRUCTIONS ARE OBTAINED.
- 12. ALL SPRINKLER HEADS SHALL BE SET PERPENDICULAR TO FINISH GRADE OF THE AREA TO BE IRRIGATED UNLESS OTHERWISE DESIGNATED ON THE PLANS.
- 13. INSTALL A VALCON 5000 SERIES SPRING LOADED CHECK VALVE BELOW DRIP BUBBLERS WHERE LOW HEAD DRAINAGE WILL CAUSE EROSION AND EXCESS WATER.
- 14. INSTALL VALVE BOXES 12" FROM AND PERPENDICULAR TO WALK, CURB, BUILDING OR LANDSCAPE FEATURE. AT MULTIPLE VALVE BOX GROUPS, EACH BOX SHALL DE AN EQUAL DISTANCE FROM THE WALK, CURB, ETC. AND EACH BOX SHALL DE 12" APART. SHORT SIDE OF VALVE BOX SHALL BE PARALLEL TO WALK, CURB LAWN, ETC.
- 15. THE SPRINKLER SYSTEM DESIGN IS BASED ON THE MINIMUM OPERATING PRESSURE SHOWN ON THE IRRIGATION DRAWINGS. THE IRRIGATION CONTRACTOR SHALL VERIFY WATER PRESSURE PRIOR TO CONSTRUCTION. REPORT ANY DIFFERENCE BETWEEN THE WATER PRESSURE INDICATED ON THE DRAWINGS AND THE ACTUAL PRESSURE READING AT THE IRRIGATION POINT OF CONNECTION TO THE OWNER'S AUTHORIZED REPRESENTATIVE.
- 16. OPERATE IRRIGATION CONTROLLER(S) BETWEEN THE HOURS OF 10:00 PM AND 7:00 AM.
- 17. IRRIGATION CONTRACTOR TO NOTIFY ALL LOCAL JURISDICTIONS FOR INSPECTION AND TESTING OF INSTALLED BACKFLOW PREVENTION DEVICE.
- 18. PRIOR TO TRENCHING, CALL UNDERGROUND SERVICE ALERT, (1–800) 642-2444 FOR NORTHERN CALIFORNIA
- 19. WHEN VERTICAL OBSTRUCTIONS (STREET LIGHTS, TREES, FIRE HYDRANTS, ETC.) INTERFERE WITH THE PATTERN OF THE DRIP TUBING LAYOUT SO AS TO PREVENT PROPER COVERAGE, THE IRRIGATION CONTRACTOR SHALL FIELD ADJUST THE DRIP SYSTEM AT THE LOCATION OF THE OBSTRUCTION SO AS TO PROVIDE PROPER COVERAGE. ALL ADJUSTMENTS SHALL BE MADE AT NO ADDITIONAL COST TO THE OWNER.

### **IRRIGATION LEGEND**

SYMBOL	MODEL NUMBER	DESCRIPTION	PSI	PSI GPM		RADIUS						
	оств16	PEPCO OCTA BUBBLER-SHRUBS	30	2 GPH	-	+						
•	RWS-B-C-1401	TREE BUBBLERS IN TURF- ONE RAINBIRD BUBBLER IN DEEP WATERING TUBE PER TREE	.25 EACH	-	-							
₽	M64/AP100	SPEARS FLUSHING END PLUG - LOCATE AT END OF LONG DRIP LINES										
٥	P-220-27	TORO REMOTE CONTROL VALVE										
H	T-113-K	NIBCO GATE VALVE (LINE SIZE) WITH CROSS HANDLE INSIDE ROUND VALVE BOX										
•	33-DLRC	RAIN BIRD 3/4" QUICK COUPLING VALVE										
<b>X</b>	825Y-BV-SBBC-30SS	FEBCO BACKFLOW PREVENTOR WITH STRONG BOX ENCLOSURE										
	1-1201-1151-8130 PMR-MF-30-1"	AMIAD 1" FILTER WITH 130 MESH SCREEN WITH SENNINGER 1" IN-LINE PRESSURE REDUCING VALVE (1-22 GPM)										
<b>(A)</b>	RME24EG RS1000	RAINMASTER ET BASED CONTROLLER WALL MOUNTED INSIDE METAL ENCLOSURE WITH IRRITROL SYSTEMS WIRELESS RAIN SENSOR										
		IRRIGATION INSIDE DASHED OUTLINE AREA: TORO DL2000 DRIPLINE DRIP EMITTER TUBING PART NUMBER: RGP-412-10 - 1.0 GPH EMITTERS 12" ON CENTER DRIPLINE PIPE WITH TORO LOC-EZE FITTINGS (OR EQUAL) INSTALLED 4" COVER BELOW SOIL LEVEL AND 8" FROM EDGE OF SIDEWALK OR CURB. INSTALL DRIPLINE PER INSTALLATION DETAILS SHEET L-8										
A-1	-	STATION NUMBER GALLONS PER MINUTE VALVE SIZE  MAINLINE: SCHEDULE 40 PVC PLASTIC PIPE WITH SCHEDULE 40 PVC SOLVENT WELD FITTINGS. 18" COVER.										
-	=======================================	LATERAL LINE: 1120-CLASS 200 PVC PLASTIC PIPE WITH SCHEDULE 40 PVC SOLVENT WELD FITTINGS. 12" COVER.										
-	= ==	SLEEVE:1120-200 PSI PVC PLASTIC PIPE W/SCHEDULE 40 PVC PLASTIC FITTINGS. 24" COVER. SIZE NOTED ON PLANS.										

**ATTACHMENT R** 

GATES +ASSOCIATES

LANDSCAPE ARCHITECTURE LAND PLANNING · URBAN DESIGN

2671 CROW CANYON RD. SAN RAMON, CA 94583

AMARAL PROPERTY

HAYWARD, CA

ISSUE: DESCRIPTION
ISSUE I SITE REVIEW

ISSUE 1 SITE REVIEW
ISSUE 2 SITE REVIEW

DATE: 05/27/2015 08/06/2015



PROJECT NUMBER:

DRAWN: CHECK: DATE:

SCALE:


MNO DG 05/27/2014



IRRIGATION NOTES & LEGEND

L-9

Page 16 of 37

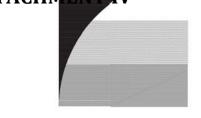

GATES +ASSOCIATES

LAND SCAPE ARCHITECTURE LAND PLANNING • URBAN DESIGN

2671 CROW CANYON RD. SAN RAMON, CA 94583 T. 925.736.8176 .vww.dgates.com

AMARAL PROPERTY

HAYWARD, CA

ISSUE: DESCRIPTION

ISSUE I SITE REVEW

PROJECT NUMBER:

CHECK:

DATE:

SCALE:

ISSUE 2 SITE REVIEW

DATE:

MNO

05/27/2015

PRISHED SURFACE
OF MILCH
TRENCH WIDTH

FRISHED GRADE

UARNING TAPE

NATIVE TRENCH
BACKFILL

PFIT ZONE AND
BEDDING BACKFILL


SEE OFFICE.

LATERAL PIPE SEE
PER INNIGATION
PLAN

DIRECT BURIAL LOW VOLTAGE
CONTROL WIRES TAPED AND
BENCILED EVENT OF CONTON
TRENCHED WITH PLANLINE

MAIN LINE SIZE PER
INNIGATION FLAN

TYPICAL COMBINATION TRENCH

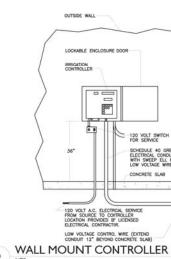

WALL MOUNT CONTROLLER

WAS MOUNT CONTROLLER

NTS

RAIN SENSOR DETAIL

O" ROND PLASTIC VALVE BOX WITH BOLT DOWN LID.

FINISH GRADE

FRUSH GRADE

FLUSH IN LAIM OR I" ABOVE PRISH GRADE IN SHRUB OR GROUND COVER AREA

3" PVC PIPE

PRA GRAVEL 4" DEEP

NO SOIL IN BOX)

GATE VALVE

DRICK-2 TOTAL

PVC MAIN LINE

PVC MAILE ADAPTER

5 GATE VALVE INSTALLATION


LOCATE BACKFLOW PREVENTOR WITHIN 24" OF WATER METER OR AS CLOSE AS FIELD CONDITIONS WILL ALLOW.


800° 300 B

**BACKFLOW ASSEMBLY** 

PVC MAINLINE


BACKFLOW FREEZE PROTECTION GOVER BY POLAR PARKA (OR EQUAL)

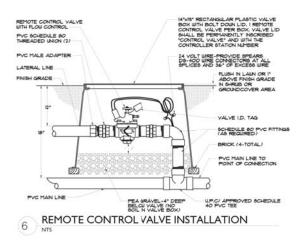

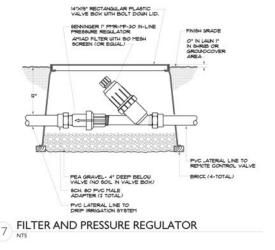



CONTROLLER ENCLOSURE


LOCATE ON SIDE OF CONTROLLER ENCLOSURE PER MANUFACTURERS RECOMMENDATIONS.

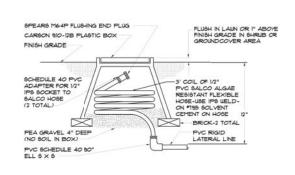


8 FLUSHING END PLUG INSTALLATION

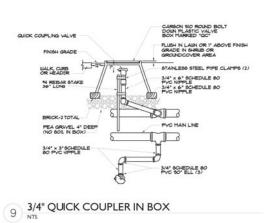


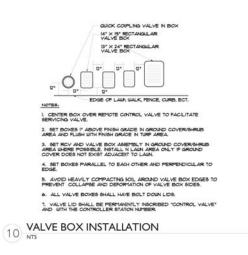

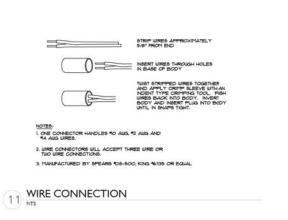

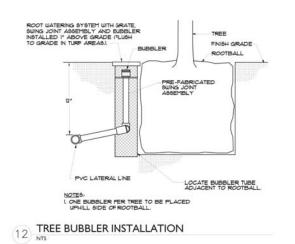


IRRIGATION DETAILS

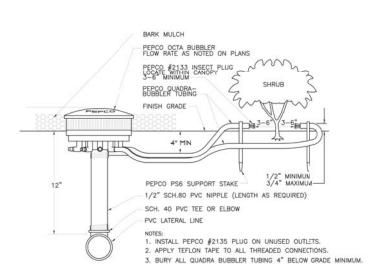


OCTA-BUBBLER IN ACCESS BOX DETAIL

PEPCO DRIP BUBBLER SEE PLAN FOR SIZE PVC LATERAL LINE OUTLET WITH PEPCO BUG PLUG I GALLON SHRUBS..... ...... I OUTLET PER SHRUB 5 GALLON SHRUBS ...... 2 OUTLETS PER SHRUB 15 GALLON SHRUBS......4 OUTLETS PER SHRUB

14 TYICAL DRIP BUBBLER LAYOUT

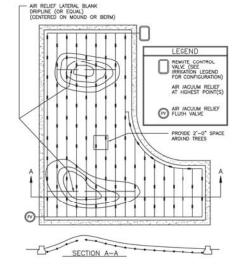

TYPICAL DRIP LAYOUT ON MOUNDS

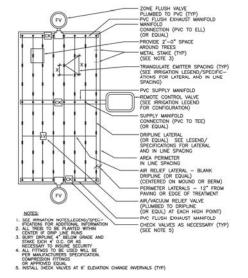

TYPICAL CENTER FEED DRIP SYSTEM LAYOUT

# **AMARAL PROPERTY**

**GATES** 

+ASSOCIATES

LANDSCAPE ARCHITECTURE LAND PLANNING . URBAN DESIGN 2671 CROW CANYON RD. SAN RAMON, CA 94583

**ATTACHMENT** 

HAYWARD, CA

SUBSURFACE IRRIGATION INSTALLATION NOTES: ASSEMBLE AND INSTALL FILTER, REMOTES CONTROL VALVE AND PRESSURE REGULATING VALVE ASSEMBLIES ACCORDING TO DETAILS.

ASSEMBLE AND INSTALL SUPPLY HEADERS ACCORDING TO DETAIL. TAPE OR PLUG OPEN CONNECTIONS TO PREVENT DEBRIS CONTAMINATION

ASSEMBLE AND INSTALL EXHAUST HEADERS IN ACCORDANCE WITH DETAILS. TAPE OR FLUG ALL OPEN CONNECTIONS TO PREVENT DEBRIS CONTAMINATION

4. INSTALL DRIP LATERALS, TAPE OR PLUG OPEN ENDS WHILE INSTALLING TO PREVENT DEBRIS CONTAMINATION.


INSTALL AIR VACUUN RELIEF VALVES AT HIGHEST POINTS OF THE IRRIGATION ZONES IN ACCORDANCE WITH DETAILS.

THOROUGHLY FLUSH DRIPLINE LATERALS AND CONNECT TO EXHAUST HEADERS OR INTERCONNECTING LATERALS WHILE FLUSHING.

7. THOROUGHLY FLUSH EXHAUST HEADERS AND INSTALL LINE FLUSHING VALVES ACCORDING TO DETAILS.

THOROUGH FLUSHING OF EACH INSTALLATION SEGMENT IS NECESSARY TO ENSURE THAT NO DEBRIS CONTAMINATION OCCURS.

LOCATE AND INSTALL CHECK VALVE(S) AS NEEDED AND AS SHOWN IN INSTALLATION DETAILS.

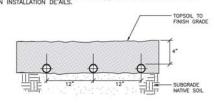

TYPICAL DRIPLINE SUBGRADE INSTALLATION

# ISSUE: DESCRIPTION ISSUE I SITE REVEW

ISSUE 2 SITE REVIEW



DATE:

MNO

05/27/2015

PROJECT NUMBER

CHECK: DATE:

05/27/2014

SCALE:



IRRIGATION DETAILS

# 2. ALL TREES TO BE PLANTED WITHIN CENTER OF DRIP LINE RUNS BURY DRIPLINE 4" BELOW GRADE AND STAKE EACH 36" O.C. LOCATED AT EMITTER AND AS NECESSARY TO INSURE SECURITY.


ALL FITTINGS TO BE USED WILL BE PER MANUFACTURERS SPECIFICATION. COMPRESSION FITTINGS OR APPROVED EQUAL.

1. SEE IRRIGATION NOTES, LEGEND/SPECIFICATIONS FOR ADDITIONAL INFORMATION

ZONE FLISH VALVE PLUMBED TO DRIPLINE (TYP - ISLAN) PERIMETER (TYP) -PVC SUPPLY MANIFOLD


REMOTE CONTROL
VALVE (SEE IRRIGATION
LEGEND FOR CONFIGURATOR

MANIFOLD FOR MULTIPLE PLANTERS

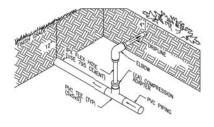


ALL FITTINGS TO BE PER MANUFACTURERS SPECIFICATION. USE COMPRESSION FITTINGS ONLY OR APPRIVED EQUAL.

DRIPLINE TO PVC INSTALLATION

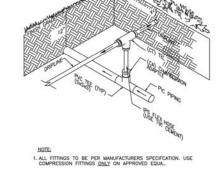


DRIPLINE TO PVC INSTALLATION

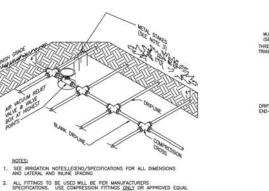


 IF DRIP TUBING HAS BEEN HAND DUG IN, STAKE DRIPLINE AT 4" O.C. AND AS NECESSARY TO INSURE SECURITY 4" BELOW GRADE. IF DRIP TUBING HAS BEEN PLOWED IN. NO STAKING IS WECESSARY. 22 AIR VACUUM RELIEF VALVE LOCATION

SEE IRRIGATION NOTES, LEGEND/SPECIFICATIONS FOR ALL DIMENSI AND LATERAL AND INLINE SPACING

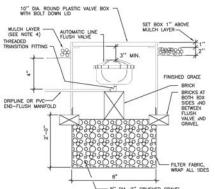

Page 18 of 37

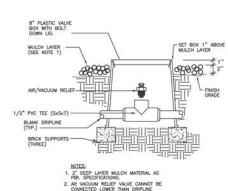

24 AIR/VACUUM RELIEF VALVE

SEE IRRIGATION NOTES, LEGEND/SPECIFICAT AND LATERAL AND INLINE SPACING

 ALL FITTINGS TO BE USED WILL BE PER MANUFACTURERS
SPECIFICATIONS. USE COMPRESSION FITTINGS ONLY OR APPROVED EQUAL IF DRIP TUBING HAS BEEN HAND DUG IN, STAKE DRIPLINE AT 4" O.C. AND AS NECESSARY TO INSURE SECURITY 4" BELOW GRADE. IF DRIP TUBING YAS BEEN PLOWED IN. NO STAKING IS NECESSARY.

DRIPLINE TO PVC HEADER INSTALLATION



PLAN 2 (STANDARD) CRAFTSMAN 1938 SQ. FT. PLAN 1 (REVERSE) MONTEREY 1891 SQ. FT. PLAN 3 (STANDARD) CAPE COD 2043 SQ. FT. PLAN 2 (STANDARD) MONTEREY 1938 SQ. FT. PLAN 3 (STANDARD) CRAFTSMAN 2043 SQ. FT.

STREET SCENE SCALE: 3/16" = 1'-0"


Amaral


City of Hayward September 28, 2015


KBHome


5000 Executive Parkway, San Ramon, Ca 94583 925.983.4500




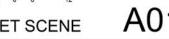

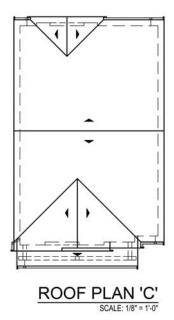

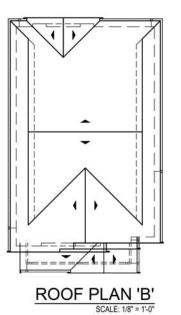

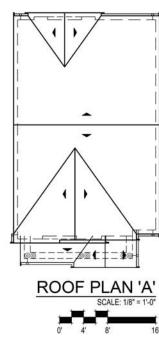

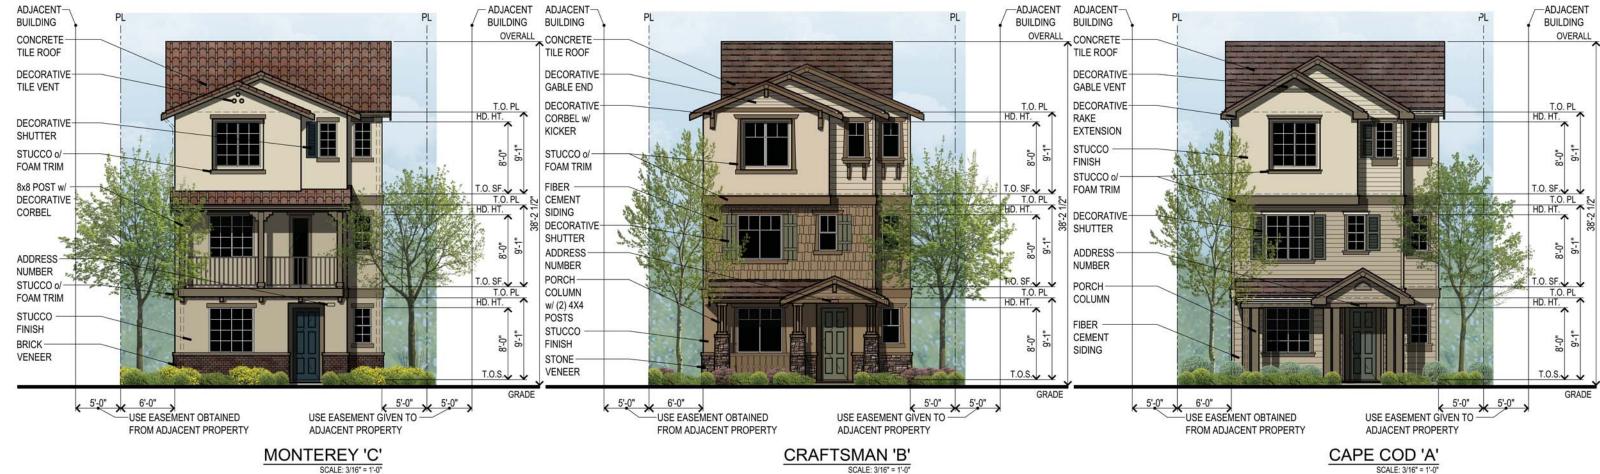



Amaral City of Haywa


City of Hayward September 28, 2015

PLAN 1 FRONT ELEVATIONS & ROOF PLANS

A02

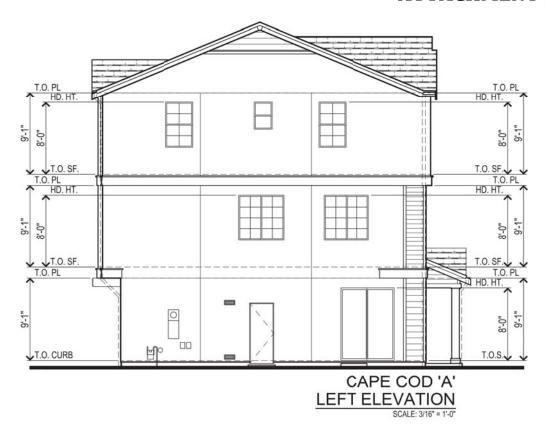

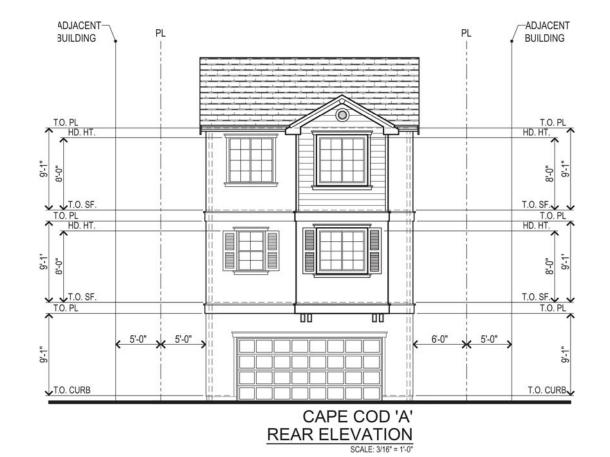

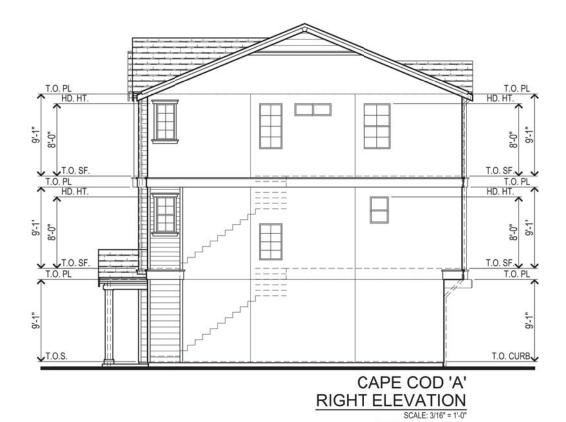



Amaral


City of Hayward September 28, 2015

PLAN 1 'A' ELEVATIONS AT INTERIOR LOTS

A03

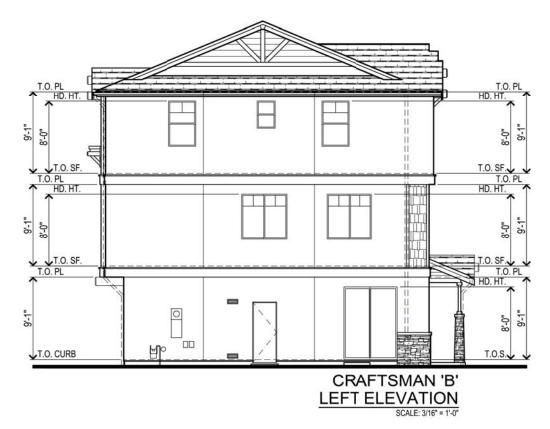

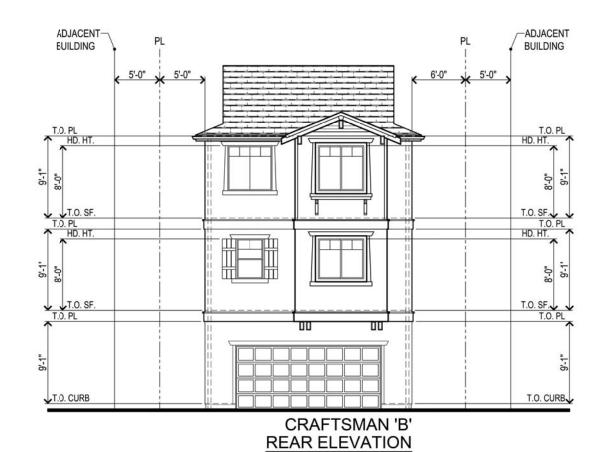

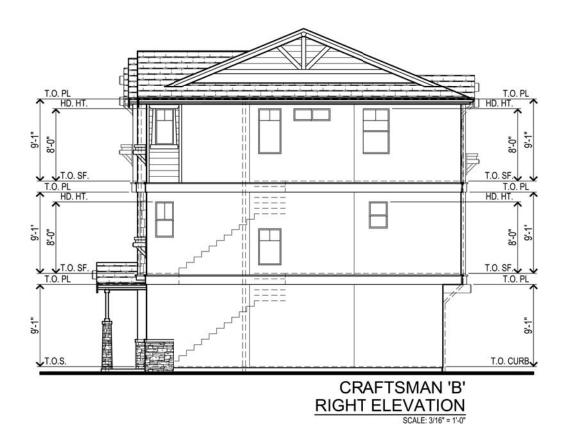


Amaral


City of Hayward September 28, 2015

PLAN 1 'B' ELEVATIONS AT INTERIOR LOTS

A04



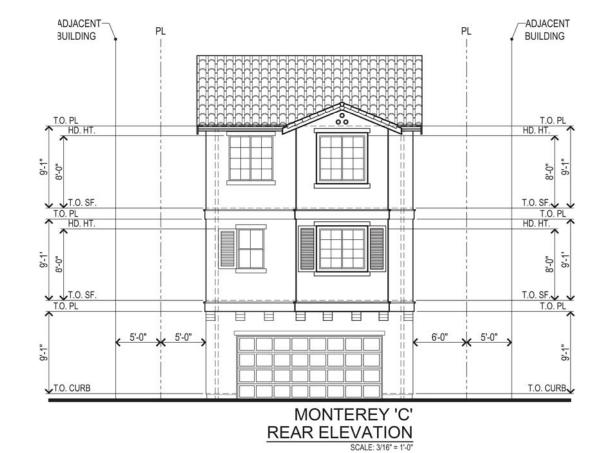

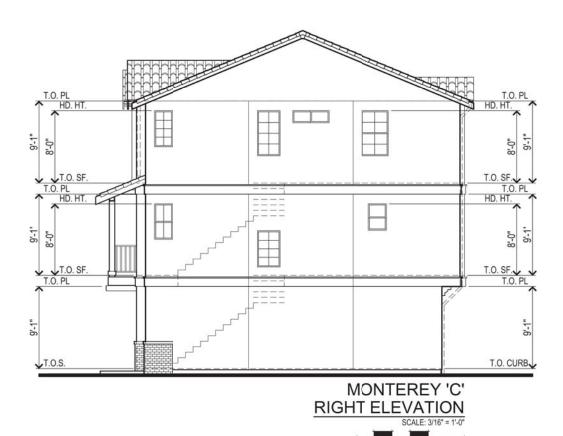

Amaral


City of Hayward September 28, 2015


PLAN 1 'C' ELEVATIONS AT INTERIOR LOTS

A05



CRAFTSMAN 'B'
ENHANCED LEFT ELEVATION
SCALE: 3/16" = 1'-0"

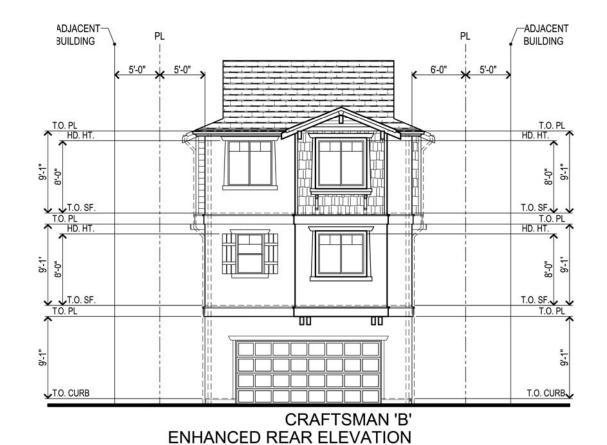

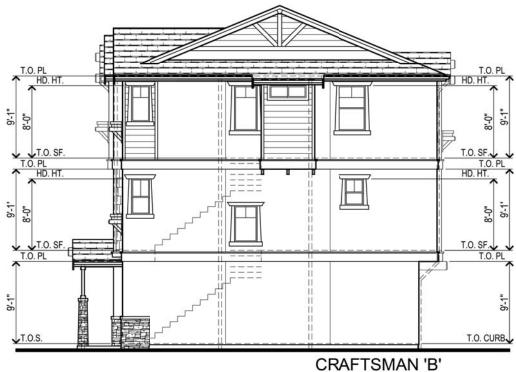

ENHANCED RIGHT ELEVATION

SCALE: 3/16" = 1'-0"


PLAN 1 'B' ENHANCED ELEVATIONS

A06

SDG Architects, Inc.

City of Hayward September 28, 2015


Amaral

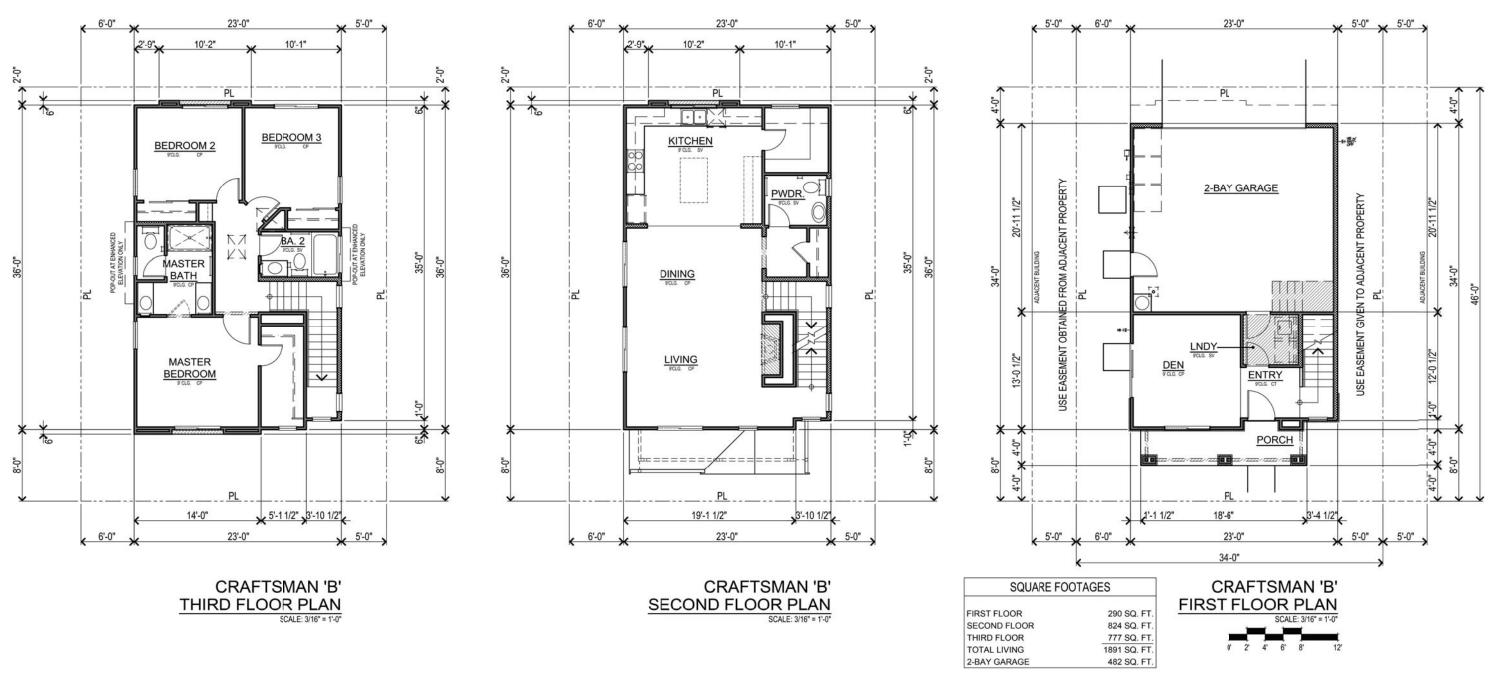



Amaral City of Hayward September 28, 2015

PLAN 1 FLOOR PLANS

A07

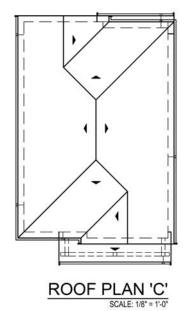


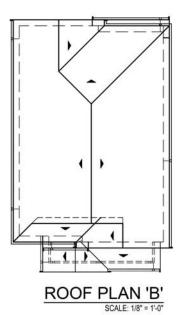

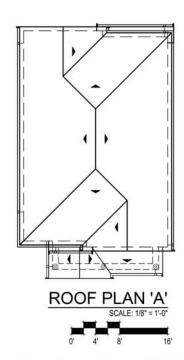



MONTEREY 'C'

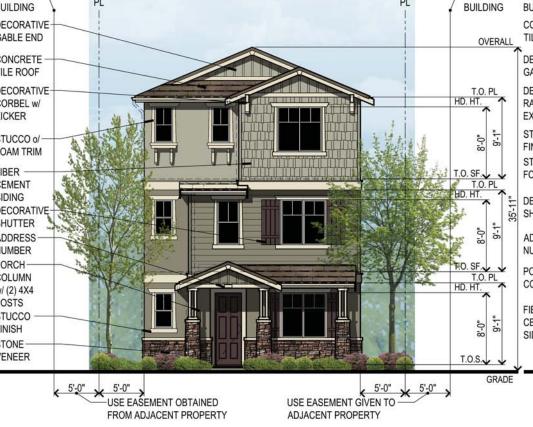



CAPE COD 'A' CRAFTSMAN 'B' SCALE: 3/16" = 1'-0"

-ADJACENT

Amaral City of Hayward September 28, 2015

KBHome

5000 Executive Parkway, San Ramon, Ca 94583 925.983.4500


3361 Walnut Blvd. Suite 120 Brentwood, CA 94513


ADJACENT PROPERTY

SCALE: 3/16" = 1'-0"

www.straussdesign.com SDG Architects, Inc.

FROM ADJACENT PROPERTY

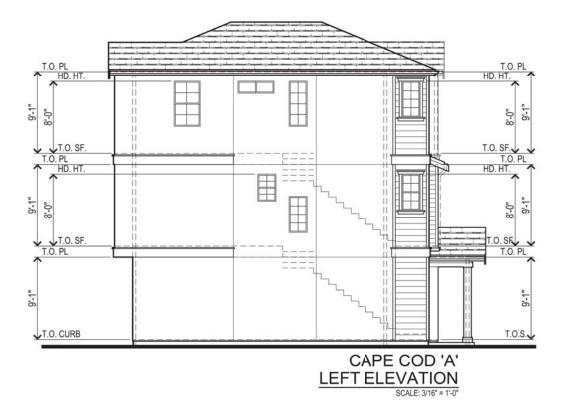

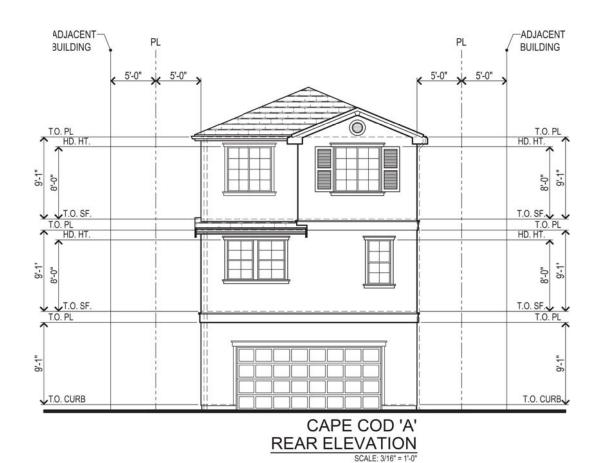




Amaral


City of Hayward September 28, 2015

PLAN 2 'A' ELEVATIONS AT INTERIOR LOTS



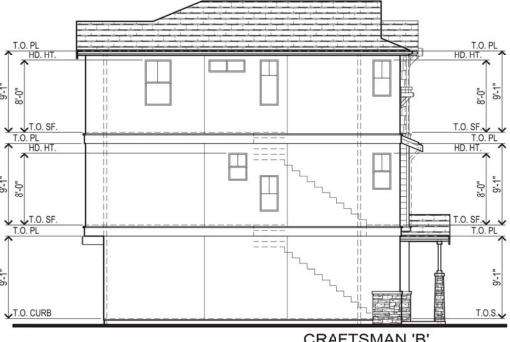

CRAFTSMAN 'B' LEFT ELEVATION SCALE: 3/16" = 1'-0"

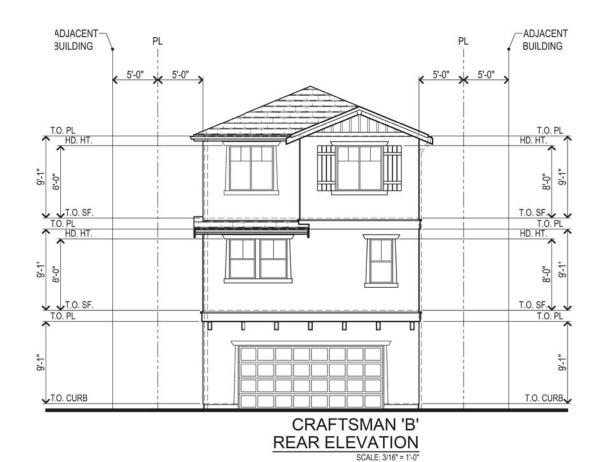




CRAFTSMAN 'B' RIGHT ELEVATION SCALE: 3/16" = 1'-0"


PLAN 2 'B' ELEVATIONS AT INTERIOR LOTS

A10

SDG Architects, Inc.

Amaral City of Hayward September 28, 2015

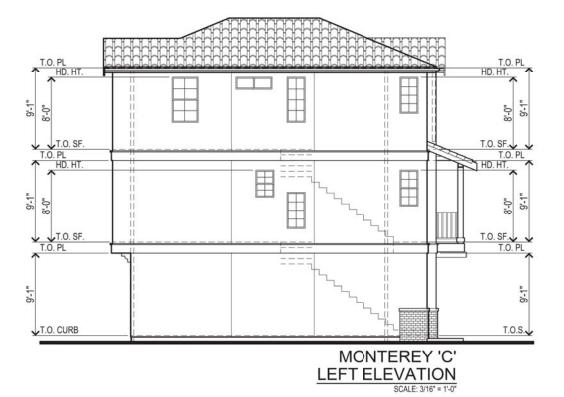

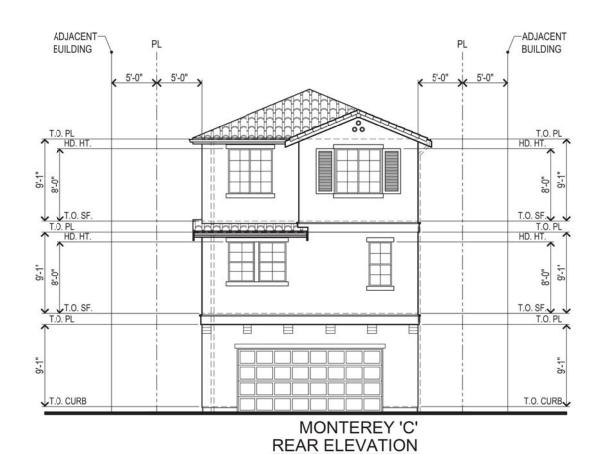



Amaral

City of Hayward September 28, 2015


PLAN 2 'C' ELEVATIONS AT INTERIOR LOTS





ENHANCED LEFT ELEVATION

SCALE: 3/16" = 1'-0"

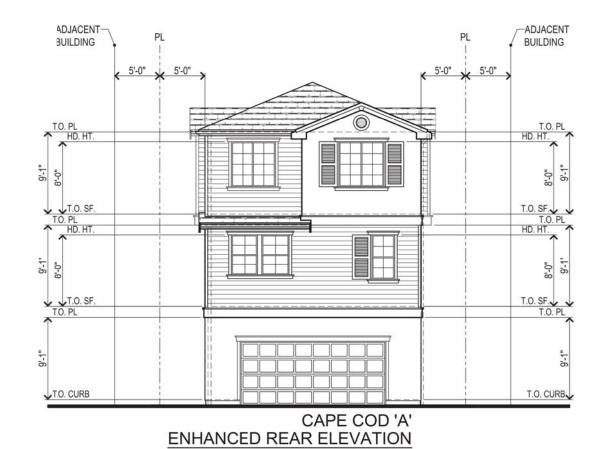



CAPE COD 'A'
ENHANCED RIGHT ELEVATION
SCALE: 3/16" = 1'-0"


PLAN 2 'A' ENHANCED ELEVATIONS

A12

SDG Architects, Inc.

September 28, 2015


Amaral City of Hayward

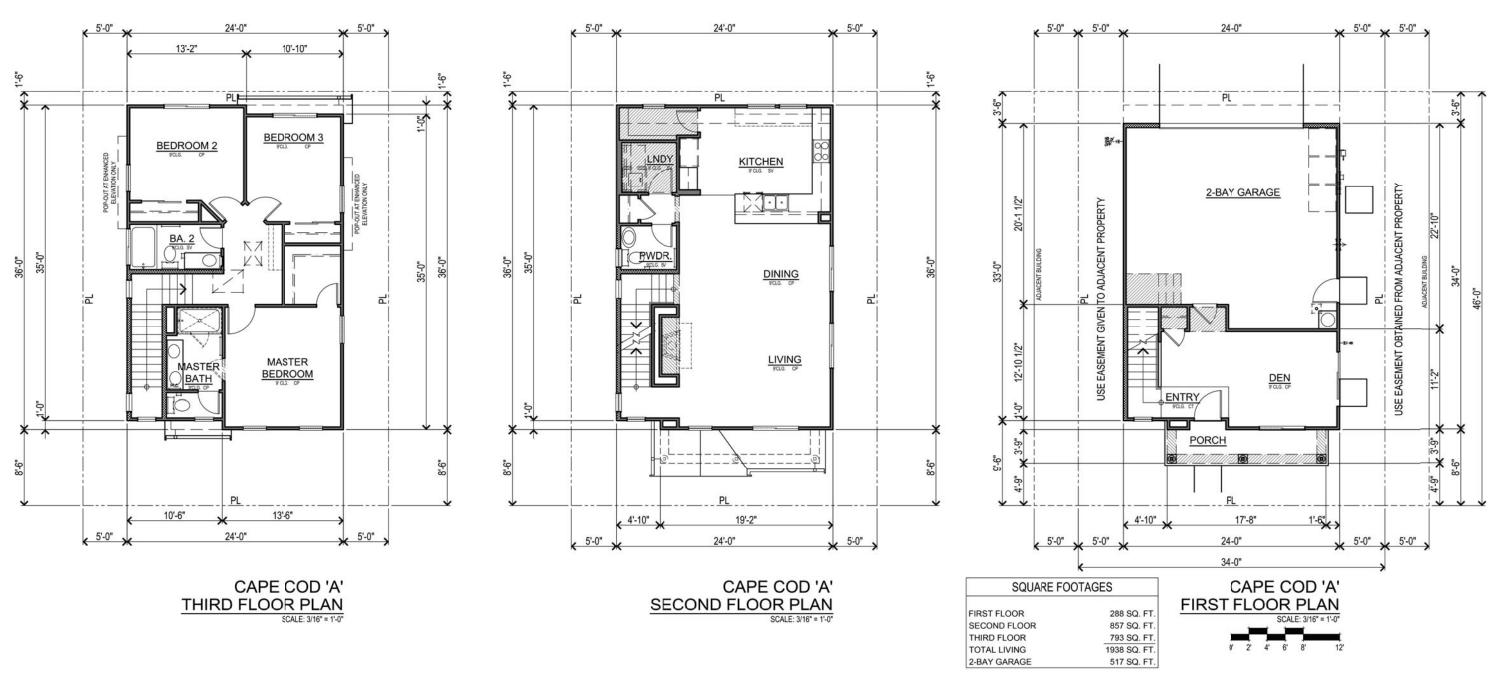



Amaral City of Hayward September 28, 2015

PLAN 2 FLOOR PLANS

A13

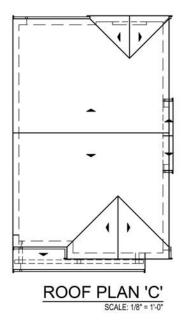

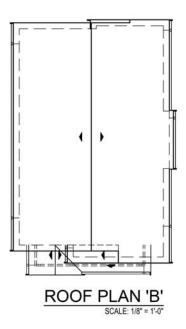

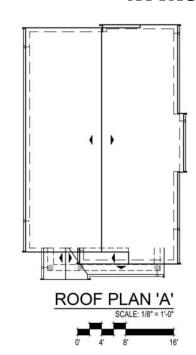



FROM ADJACENT PROPERTY

SCALE: 3/16" = 1'-0"

MONTEREY 'C'



ADJACENT

ADJACENT-

**OVERALL** DECORATIVE GABLE VENT DECORATIVE T.O. PL HD. HT. \_ ↑ **EXTENSION** 9-1" WOOD TRIM DECORATIVE-SHUTTER ADDRESS: 9'-1" T.O.S. . . USE EASEMENT GIVEN TO 5'-0" \* 5'-0" > -USE EASEMENT OBTAINED ADJACENT PROPERTY FROM ADJACENT PROPERTY

Amaral City of Haywar

City of Hayward
September 28, 2015

PLAN 3 FRONT ELEVATIONS & ROOF PLANS

A14

ADJACENT

BUILDING


CAPE COD 'A'


SCALE: 3/16" = 1'-0"

ADJACENT PROPERTY

CRAFTSMAN 'B'

SCALE: 3/16" = 1'-0"

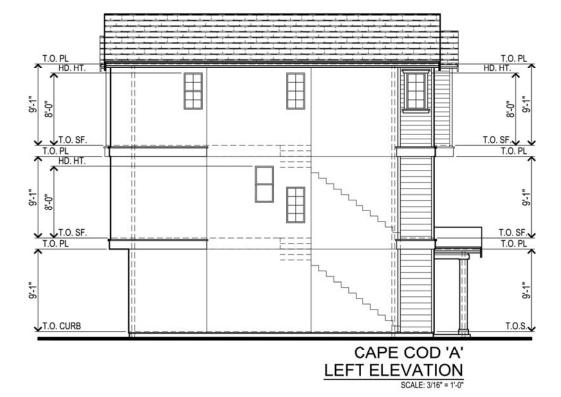

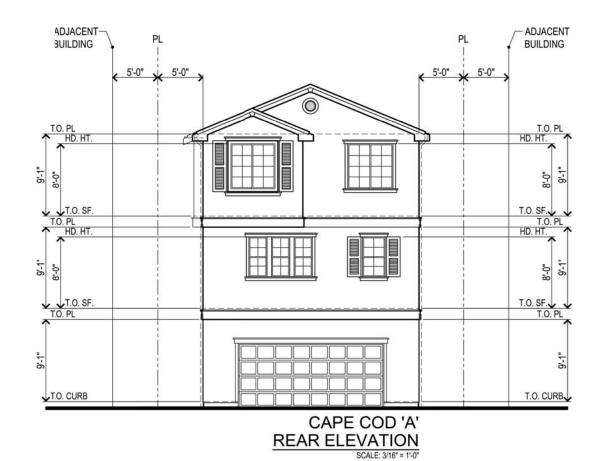




Amaral City of Hayward

September 28, 2015

PLAN 3 'A' ELEVATIONS AT INTERIOR LOTS

SDG Architects, Inc.

SCALE: 3/16" = 1'-0"

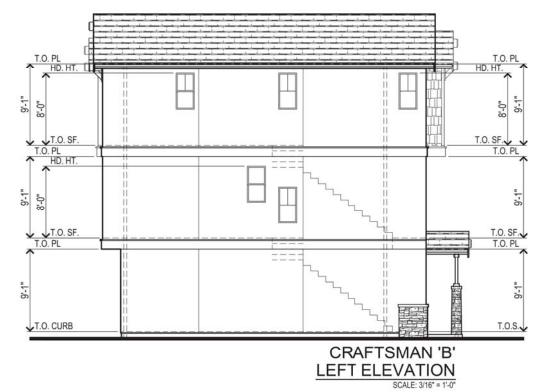

ADJACENT-- ADJACENT BUILDING BUILDING 5'-0" 3 5'-0" K 5'-0" X 5'-0" T.O. PL HD. HT. T.O. PL T.O. SF. T.O. PL HD. HT. T.O. PL T.O. SF. T.O. PL

CRAFTSMAN 'B'

SCALE: 3/16" = 1'-0"

REAR ELEVATION

T.O. CURB

T.O. PL T.O. PL

HD. HT. T.O. SF. T.O. PL HD. HT. T.O. SF. T.O. PL T.O. SF. T.O. PL HD. HT. 00 T.O. CURB CRAFTSMAN 'B'


Amaral


City of Hayward September 28, 2015


PLAN 3 'B' ELEVATIONS AT INTERIOR LOTS

RIGHT ELEVATION

T.O. CURB

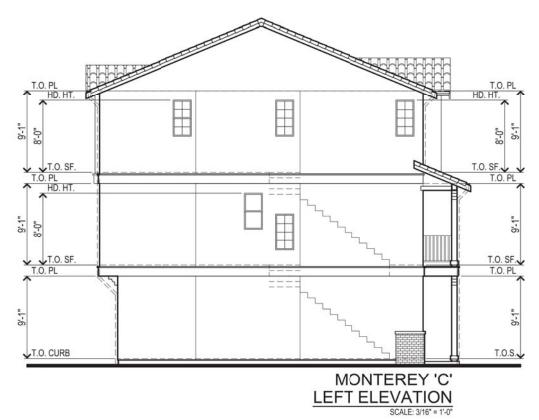

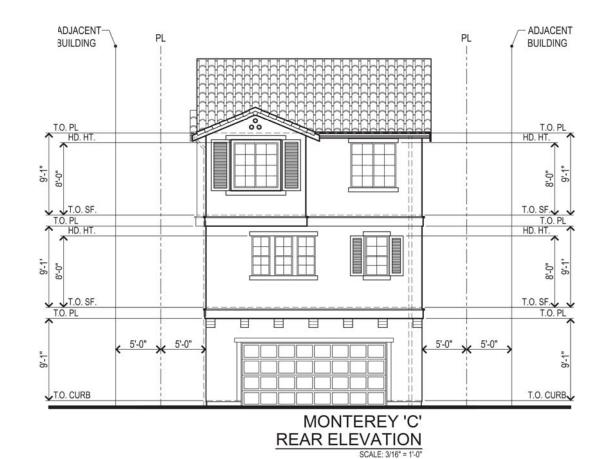

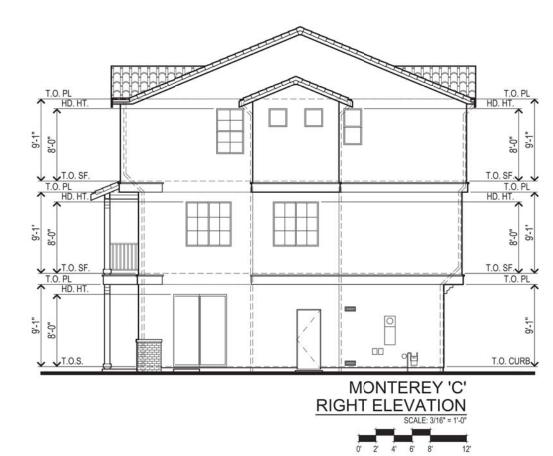

Amaral


City of Hayward September 28, 2015

PLAN 3 'C' ELEVATIONS AT INTERIOR LOTS

A17



MONTEREY 'C' ENHANCED LEFT ELEVATION SCALE: 3/16" = 1'-0"

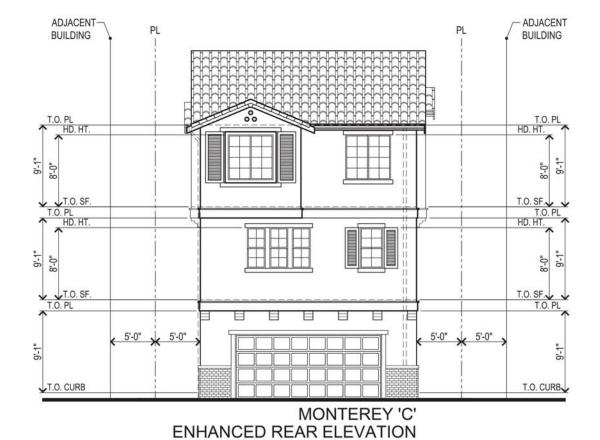

T.O. PL
HD. HT.

1.O. SF.
T.O. PL
HD. HT.

1.O. SF.
T.O. PL
HD. HT.


1.O. SF.
T.O. PL
T.O. CURB
MONTEREY 'C'

PLAN 3 'C' ENHANCED ELEVATIONS

**ENHANCED RIGHT ELEVATION** 

A18

Amaral City of Hayward September 28, 2015

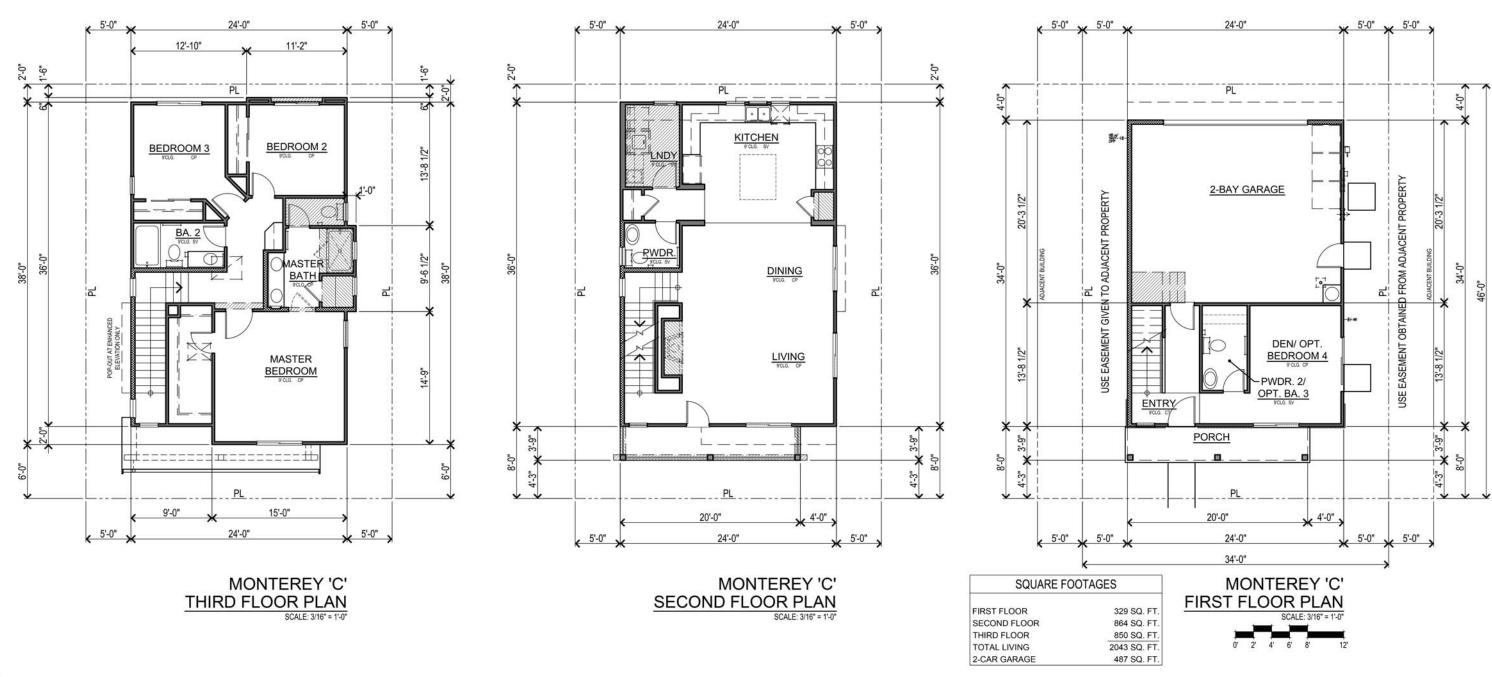

Amaral City of Hayward September 28, 2015

PLAN 3 FLOOR PLANS

A19