
ABBREVIATIONS

& < @	And Angle At	MACH. MAX. MECH.	Machine Maximum Mechanical
@ C ⊘	Centerline Diameter or Round	MEMB. MET.	Membrane Metal
I	Penny (nail size)	MFR.	Manufacturer
/	Pound or Number Feet	MIN. MIR.	Minimum Mirror
	Inches	MISC.	Miscellaneous
.COUS.	Acoustic	MTD. MTG.	Mounted Mounting
DJ.	Adjustable	MUL.	Mullion
LUM.	Aluminum Alternate		Manda
_T. PPROX.	Approximate	N (N)	North New
RCH.	Architect(ural)	Ň.Í.C.	Not in Contract
D.	Board	NO. NOM.	Number Nominal
TUM.	Bituminous Building	N.T.S.	Not to Scale
LDG. LK.	Building Block	0.0	On Conton
LKG. M.	Blocking Beam	0.C. 0.D.	On Center Outside Diameter (Dim
OT.	Bottom	OFF.	Office
AB.	Cabinet	OPER. OPNG.	Operable Opening
.C.	Center to Center	OPP.	Opposite
EM. ER.	Cement Ceramic	PL.	Plate, Property Line
LG.	Ceiling	P. LAM.	Plastic Laminate
LO. LR.	Closet Clear	PLAS. PLYWD.	Plaster Plywood
OL.	Column	PR.	Pair
ONC.	Concrete Connection	PROJ. PROP.	Projection Property
ONN. ONSTR.	Contruction	PT.	Point
ONT(IN).	Continuous Ceramic Tile	PTN. P.V.C.	Partition Poly-vinyl Chloride
Τ. ΓR.	Center		
TSK. W.	Countersunk Cold Water	Q.T. QTY.	Quarry Tile Quantity
			· - y
BL.	Depth Double	R.	Riser
EPT.	Department	RAD.	Radius
ET. IA.	Detail Diameter	R.D. RECESS.	Roof Drain Recessed
IM.	Dimension	RECP.	Reptor
N. .O.	Down Door Opening	RECT.	Rectangular
.o. R.	Door	REF.	Reference
WG.	Drawing Drawer	reinf. Req.	Rienforced Required
OWR.		RESIL.	Resilient
Ξ)	East Existing	R.H. RM.	Robe Hook Room
4 .	Each	R.O.	Rough Opening
LEV. LEC.	Elevation Electrical	R.W.L.	Rain Water Leader
NCL.	Enclosure	S.	South
Q. XIST.	Equal Existing	S.C. SCHED.	Solid Core Schedule
XP.	Expansion	SECT.	Section
XT.	Exterior	SERV. S.G.	Service Safety Glass
B.O.	Furnished by Owner	SHT.	Sheet
DN. N.	Foundation Finish	SHT'G. SIM.	Sheeting Similar
	Floor	SL.	Slope
LASH. LUOR.	Flashing Fluorescent	S.M. SP.	Sheet Metal Special
O.C.	Face of Concrete	SPEC.	Specifications
0.S. Г.	Face Of Stud Foot or Feet	SPR. SQ.	Spring Square
ΓG.	Footing	S.ST.	Stainless Steel
JRR. JT.	Furring Future	STA.	Station
<i>)</i>	ו ענעוס	STAG. STD.	Staggered Standard
۹.	Gauge	STL.	Steel
ALV.	Galvanized Grab Bar	STOR. STRUC.	Storage Structural
.B. L.	Glass	SUSP.	Suspended
ND.	Ground Grade	SYM.	Symmetrical
R. .S.M.	Galvanized Sheet Metal	(T)	Toilet
YP.	Gypsum	Ť.B. TEL.	Towel Bar Telephone
WB (G.W.B.)	Gypsum Wall Board	(T)	Tempered
.B.	Hollow Core	Ť. & G. TH.	Tongue and Groove Threshold
.C. DWD.	Hollow Core Hardwood	THK.	Thick
DWRE.	Hardware	T.O. T.O.P.	Top of Payement
.M. ORIZ.	Hollow Metal Horizontial	T.O.W.	Top of Pavement Top of Wall
R.	Hour	T.P.D. T.V.	Toilet Paper Dispenser Television
T. W.	Height Hot Water	TYP.	Television Typical
).).	Inside Diameter	UNF.	Unfinished
ISUL.	Insulation	U.O.N.	Unless Otherwise Note
IT. IV.	Interior Invert	UTIL.	Utility
		V.C.T.	Vinyl Composition Tile
Т.	Joint	VERT V.I.F.	Vertical Verify in Field
IT.	Kitchen	VIN.	Vinyl
AM.	Laminate	W.	West or Width
١V.	Lavatory	W/. W.C.	With
OC. 「.	Location Light	WD.	Water Closet Wood
LT.	<u> </u>	W.H. W/O.	Water Heater Without
		W.P.	Waterproof
		W.R. W.S.	Water Receptacle Weather Stripping
		WT.	Weight
		W.W.M.	Welded Wire Mesh

SYMBOLS

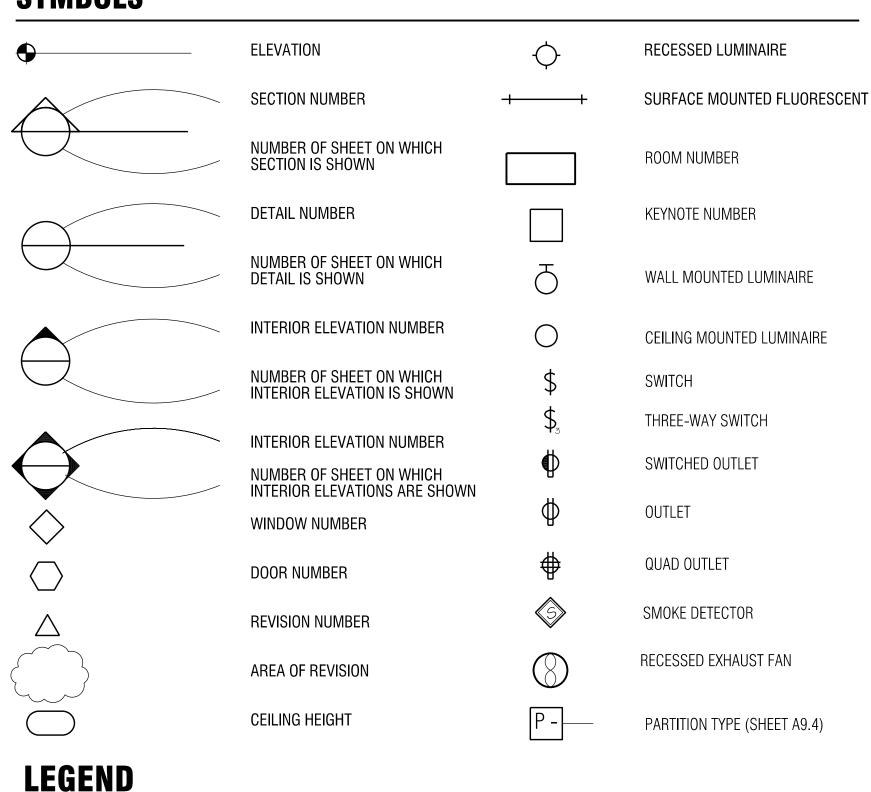

INSULATION

PLYWOOD

Always On Time Consulting

Robert Remiker

ARCHITECT

1943 Napa Avenue Berkeley CA 9470

Ren. 8-1-2023
No. C-15111

Conditional Use Permit

Project Description

ALTERATIONS OF EXISTING TENANT SPACE FOR CANNABIS RELATED ENTERPRISE - DELIVERY, DISTRIBUTION, AND MANUFACTURING.

Owner:
Always On Time Consulting
8 North San Pedro St
Suite 200
San Jose, CA 95110
Contact: Doug Chloupek
P: 408.667.9727


INDEX

A0.0 General Notes, Index to the Drawings, Symbols Abbreviations, Project Description, Legend, Location Map, and Site Plan

A1.1 Site Plan - ExistingA2.1 Site Plan & Floor Plan - Proposed

A3.1 Elevations / Site Photos

LOCATION MAP

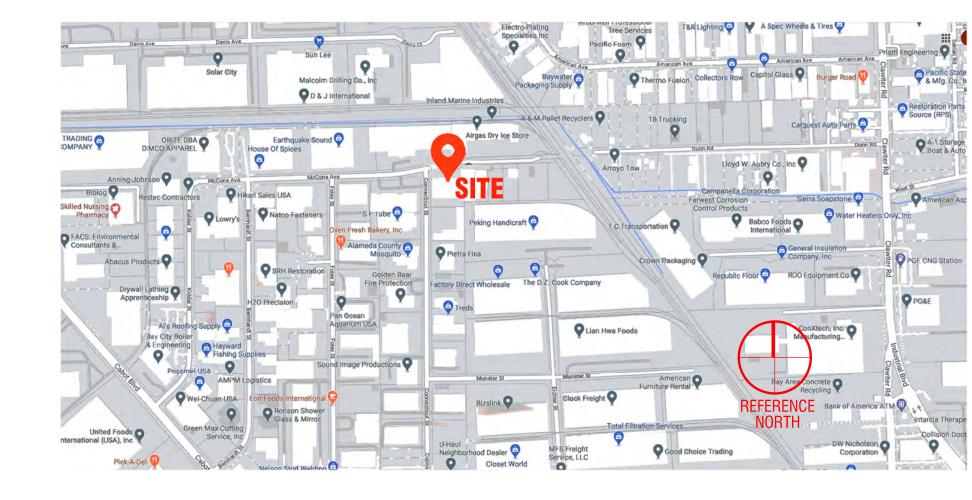

Alterations for:

Always On Time

23000 Connecticut St Unit #5 Hayward, CA 94545

Rev # Description Date:

Plan Check #1 11-16-202

GENERAL NOTES

CONCRETE

EARTH

GLASS

- 1. All architectural, structural, and electrical work is shown, described or specified in the Architectural, Structural, Mechanical, and Electrical Drawings indexed on this Sheet and as noted in this Drawing Set. All work shall be carried out in accordance with the following:
- a. 2019 California Building Code (CBC) based on the International Building Code
 b. 2019 California Plumbing, Electrical, and Mechanical Codes (CPC,CEC, CMC)
 c. 2019 California Energy Code and all current local codes and ordinances.
- d. 2019 California Fire Code (Title 24, part 9)
 Designs represented by these drawings are the property of the architect and are developed for use on this project only. These drawings and the designs they represent shall not be used by or disclosed to any person or firm outside the scope of this project without written permission from Robert Remiker Architect.
 3. 3The general conditions of the contract for the construction of buildings, published by the American Institute
- bound herein, is available for review at the office of the Architect.

 4. All framing dimensions are to face of finish unless otherwise noted. Do not scale drawings. Written dimensions take precedence. All dimensions shall be field verified. It is the Construction Manager and/or Contractor's responsibility to field verify all dimensions and conditions before commencing construction. Notify the architect of any discrepancies between site conditions and these drawings for clarification and correction by Architect. Construction Manager and/or Contractor shall be responsible for all costs incurred due to his failure

of Architects shall apply to and govern the work of this contract. A copy of the general conditions, although not

- to do so.
 5. Do not notch, bore or cut members for pipes, ducts or other reasons except as shown on drawings, or with
- specific approval in advance by Architect.

 6. Verify all dimensions where work involves framing for cabinets, windows, doors, or skylights.

 7. All exterior doors shall be weather stripped.
- 8. Scope of Work: The scope of work for each division shall include all labor, materials, appliances, equipment and facilities necessary to do all of the work indicated in the drawings and specifications. Work shall include all demolition, patching and repair required to accommodate new construction. Construction Manager and/or Contractor shall supply all labor, materials, equipment and services of every kind, including water and power, necessary for the. Proper execution of the work shown on the drawings. Only work identified as not in contract (N.I.C.) or by Owner shall not be included in the scope of work.
- 9. Shop drawings: Construction Manager and/or Contractor and subcontractors shall be responsible for submitting shop drawings to the architect for approval prior to proceeding with fabrication. Construction Manager and/or Contractor shall submit samples of all new finish materials to the architect for approval prior to installation or
- execution.

 Permits and inspections: the tenant shall pay for plan checking fees and building permits. Each contractor shall secure and pay for permits required for their work and for all inspections which may also be required. Testing and inspections: Construction Manager and/or Contractor shall arrange and pay for all testing and inspections required by applicable building codes, ordinances or directives of governing Building officials. The owner or architect may require testing of materials for conformance with the contract documents. The owner shall pay all costs for such testing if the tests indicate conformance. Construction Manager and/or Contractor shall pay costs when the testing indicates non-conformance.

CONSTRUCTION NOTES

WOOD (FINISH)

WALL OR PARTITION

WALL TO BE DEMOLISHED

ONE-HOUR FIRE-RATED WALL

- The existing conditions in the construction documents are based on site observation, and partial original plans supplied by Owners, building owners, and prior Architect to Robert Remiker Architect. Any discrepancies between these documents and the actual field conditions shall be brought to the attention of the Architect before proceeding with any work.
- 2. When Construction Manager and/or Contractor accepts delivery of all items noted on plans whether in contract or not in contract, the Contractor shall be responsible for loss and/or Damage to these items.
- 3. The Construction Manager and/or Contractor shall maintain, for the entire duration of the work, all exits, exit lighting, fire protection devices, and alarms in conformance with all applicable Codes and ordinances.
- 4. Construction Manager and/or Contractor shall assess at time of bid, the condition of existing construction to remain. Any necessary upgrades, repairs, or replacement shall be included in the scope of work at that time. Wth prior approval of Owner and return of proper credit, existing Work scheduled for removal or replacement, which can be incorporated into the new scope, may be re-used.
- 5. Demolition: remove all interior partitions, casework, storefronts, ceiling, finished flooring and all other items not used in new scheme.
- All saw cutting, coring and anchoring locations shall be reviewed in field by the Construction Manager and/or Contractor and coordinated with the landlord prior to the work. DO NOT CUT REBAR. If rebar is encountered, the work is to be relocated.
- 'Typ.' should mean that the condition is representative for similar conditions throughout, unless otherwise noted.
- Floor plan by Architect supersedes other plans. All dimensions marked 'clear' shall be maintained and shall allow for thickness of all finishes including carpet, pad, ceramic tile, v.c.t., etc.
- Provide portable fire extinguisher(s) with U.L. label and a rating of not less than 2-a with 75 ft. travel distance to all positions of space or as directed by the fire department field inspector.
- 10. Construction Manager and/or Contractor to coordinate all millwork, lighting and flooring shipments directly with Vendors.

11. Construction Manager and/or Contractor to label electrical switches and thermostats as shown on elec, & mech,

- dwgs. 3/8" high letters min., vvhite typeface typ. All label text styles to match.
 Construction Manager and/or Contractor shall be responsible for all costs required by these contract documents
- or by Government agencies with regard to inspections and testing.

 Construction Manager and/or Contractor shall provide and be responsible for all costs for public protection as

required by the contract documents and local government agencies.

- 14. Construction Manager and/or Contractor shall make no revisions, alterations, or changes to the work as shown in the contract documents without the prior written approval of the Architect.
- 15. Construction Manager and/or Contractor shall provide the building official with a certificate of construction compliance and with energy conservation standards upon final building department inspection.
- 16. Construction Manager and/or Contractor shall provide access panels for all trades as required by code. Locations to be approved by Architect prior to execution of work.
- . Combustible materials used for construction in this space must be stamped as fire-rated. Field applied treatments to combustible materials are not permitted.
- 18. Construction Manager and/or Contractor will provide an on-site superintendent for the duration of the project19. All work, materials, and equipment shall be guaranteed for a minimum period of one year from date of final
- and operating instructions upon final acceptance.

 The Construction Manager and/or Contractor shall be responsible for coordinating with landlord on all work to be performed by the landlord. Any potential conflicts or delays caused by the landlord's subContractors must be documented in writing to the Architect and the tenant before the delay is actually incurred for it to be considered. Otherwise the Construction Manager and/or Contractor will be responsible for meeting the schedule as

acceptance. Construction Manager and/or Contractor shall provide the tenant with all equipment manuals, warranties

21. Construction Manager and/or Contractor shall supply all materials. Labor and coordination required for the installation of all tenant supplied items as described in the documents.

outlined in the contract.

- Construction Manager and/or Contractor shall clean the site of all unnecessary debris prior to starting construction, and shall keep the site neat and clean at all times. Construction Manager and/or Contractor shall clean all doors, window glass, interior and exterior walls, ceiling and floors, as well as all installed items (fixtures) before vacating the premises and tenant move-in. Construction Manager and/or Contractor hall provide 'white glove'professional cleaning prior to opening and be available to provide "touch-up" work.
- 28. Construction Manager and/or Contractor shall patch and repair existing surfaces as necessary before applying new finishes. All soft, porous, flaking or otherwise defective finishes will be removed before application of new materials. Openings, voids, or unfinished surfaces created by removal or modification of existing work shall be filled or patched and finished as necessary to match existing continuous surfaces of new finishes required. Specifically, floor surfaces at entry shall be leveled to assure smooth surface for finish floor installation.

GREEN BUILDING NOTES

- 1. Construction Waste Management: Contractor to comply with the City of Hayward Construction and
- Demolition Debris Waste Managament Plan
 2. Recycling by Occupants: Provide adequate space and equal access for storage, collection and loading of compostable, recyclable and landfill materials per CGC 5.410.1
- 3. Acoustical Control: Floor to Ceiling Assembly consists of 4" to 5" concrete slab with carpet tile.

 4" Slab provided = STC 49. Minimum Required = STC 40. (National Bureau of Standards Test #808)

 Windows at storefront glazing have >1/4" thick monolithic glass=31 STC(Riverbank Acoustical Laboratories
- Test No. TL 85-169).
 4. Carpets where used to meet NSF/ANSI 140 at the Gold level.

Medium density fiberboard 0.11

- Carpet proposed is a Modular Carpet product. No carpet pad proposed.

 5. Third party commissioning of HVAC and Lighting Systems to be performed as directed/contracted by Owner/Tenant.
- 6. Paint products to be Zero VOC Cal Green Title 24 Part II compliant non-flat finish latex.7. VCT and LVT products where used to comply with FloorScore® Indoor Air Quality
- Certified to SCS-EC10.2-2007

 8. Composite wood products to comply with CA Air Resources Board TABLE 5.504.4.5 Formaldahyde PPM Emission limits as follows:
- Emission limits as follows:

 Hardwood plywood veneer core 0.05

 Hardwood plywood composite core 0.05

 Particle board 0.09
- Thin medium density fiberboard0.13

 9. Indoor Water Efficiency: All Plumbing Fittings and Fixtures to comply with State, City and County of Alameda Green Building Measures PRESCRIPTIVE Approach Flow Rates.
- County of Alameda Green Building Measures PRESCRIPTIVE Approach Flow Rates.

 10. All Adhesives, Sealants and Caulks to comply with South Coast Air Quality Management District Rule 1168 VOC limits and California Code of Regulations Title 17 for aerosol paints (13C.5.504.4.3), including the following:

Carpet Adhesive, VOC limit (g/L less water =50)
Ceramic Tile Adhesive, VOC limit (g/L less water =65)
VCT Adhesive, VOC limit (g/L less water =50)
Drywall Adhesive, VOC limit (g/L less water =50)
Multipurpose Construction Adhesive, VOC limit (g/L less water =70)

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Sheet Title:
Index, Green Building
Notes, Construction
Notes, Symbols,
Abbreviations and
General Notes

Date: 02-21-2020
Scale: AS NOTED
Drawn: RR

Job: 2011
Sheet

AU.

f Sheets



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23000 Connecticut St. Unit #5 Hayward, CA 94545

Rev # Description Date:

Plan Check #1 11-16-2020

Plan Revisions 9-21-2022

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Sheet Title:


Site Plan - Existing

Date:	02-21-2020
Scale:	1/16" = 1'-0"
Drawn:	RR
Job:	2011
Sheet	

A1.1

of Sheets

24 x 36 @ 1/8 " Scale

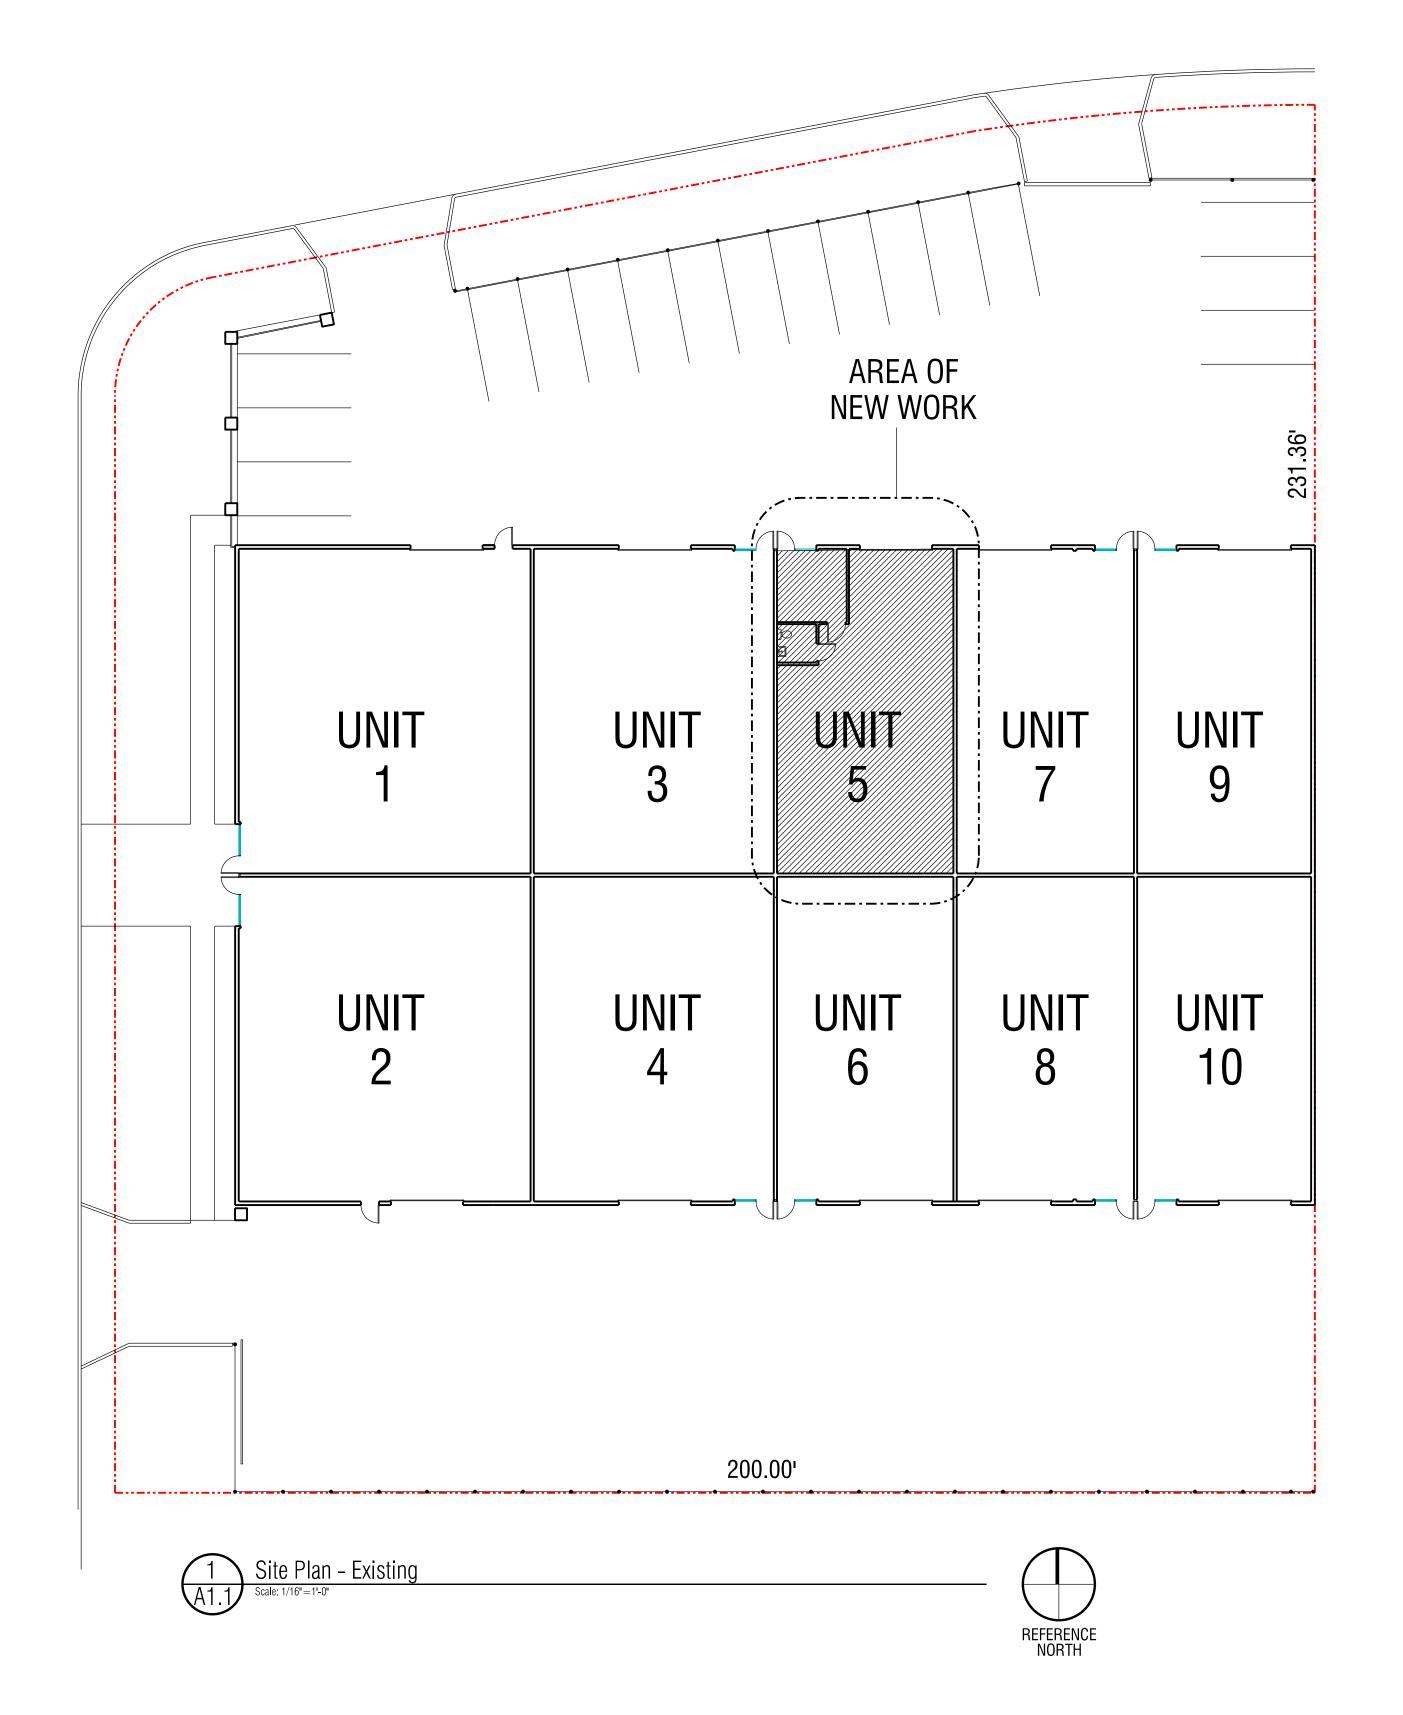





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23000 Connecticut St. Unit #5 Hayward, CA 94545

 Rev # Description
 Date:

 1
 Plan Check #1
 11-16-2020

 2
 Plan Revisions
 9-21-2022

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Sheet Title:

Site Plan & Floor Plan -Proposed

Date: 02-21-2020

Scale: AS NOTED

Drawn: RR

A2.1

Sheets

Unit 5- Building Occupancy ENTRY / SECURITY MANUFACTURING F-1 (100 s.f. / occupant) 153.6 S.F. BUSINESS GROUP B-1 (100 s.f. / occupant) 923.5 s.f. ASSEMBLY (CALCULATED AS ASSEMBLY BUT CLASSIFIED AS B-1) (15 s.f. / occupant) CIRCULATION / RESTROOMS 225.2 s.f. TOTAL GROSS S.F. 1626.8 s.f. **RESTROOM** MANUFACTURING 332.0 S.F. OFFICE 148.0 S.F. DISTRIBUTION 145.8 S.F. 8'-0" 4'-4 1/2" 16'-3" DELIVERY 424.2 S.F. 29'-5" Floor Plan - Proposed

Scale: 1/4"=1-0"


Waste Management Legend


GREEN: CULTIVATION, LAB EXPENT MATERIAL, PRE-ROLL WASTE - CANNABIS PLANT MATERIAL ONLY


YELLOW: DAMAGED OIL PRODUCTS (VAPE BATTERIES, OIL+BATTERY, ANY OIL CONTAINING PRODUCT WASTE)

RED: ETHANOL OR OTHER SOLVENT WASTE


GREEN: CULTIVATION, LAB EXPENT MATERIAL, PRE-ROLL WASTE - CANNABIS PLANT MATERIAL ONLY

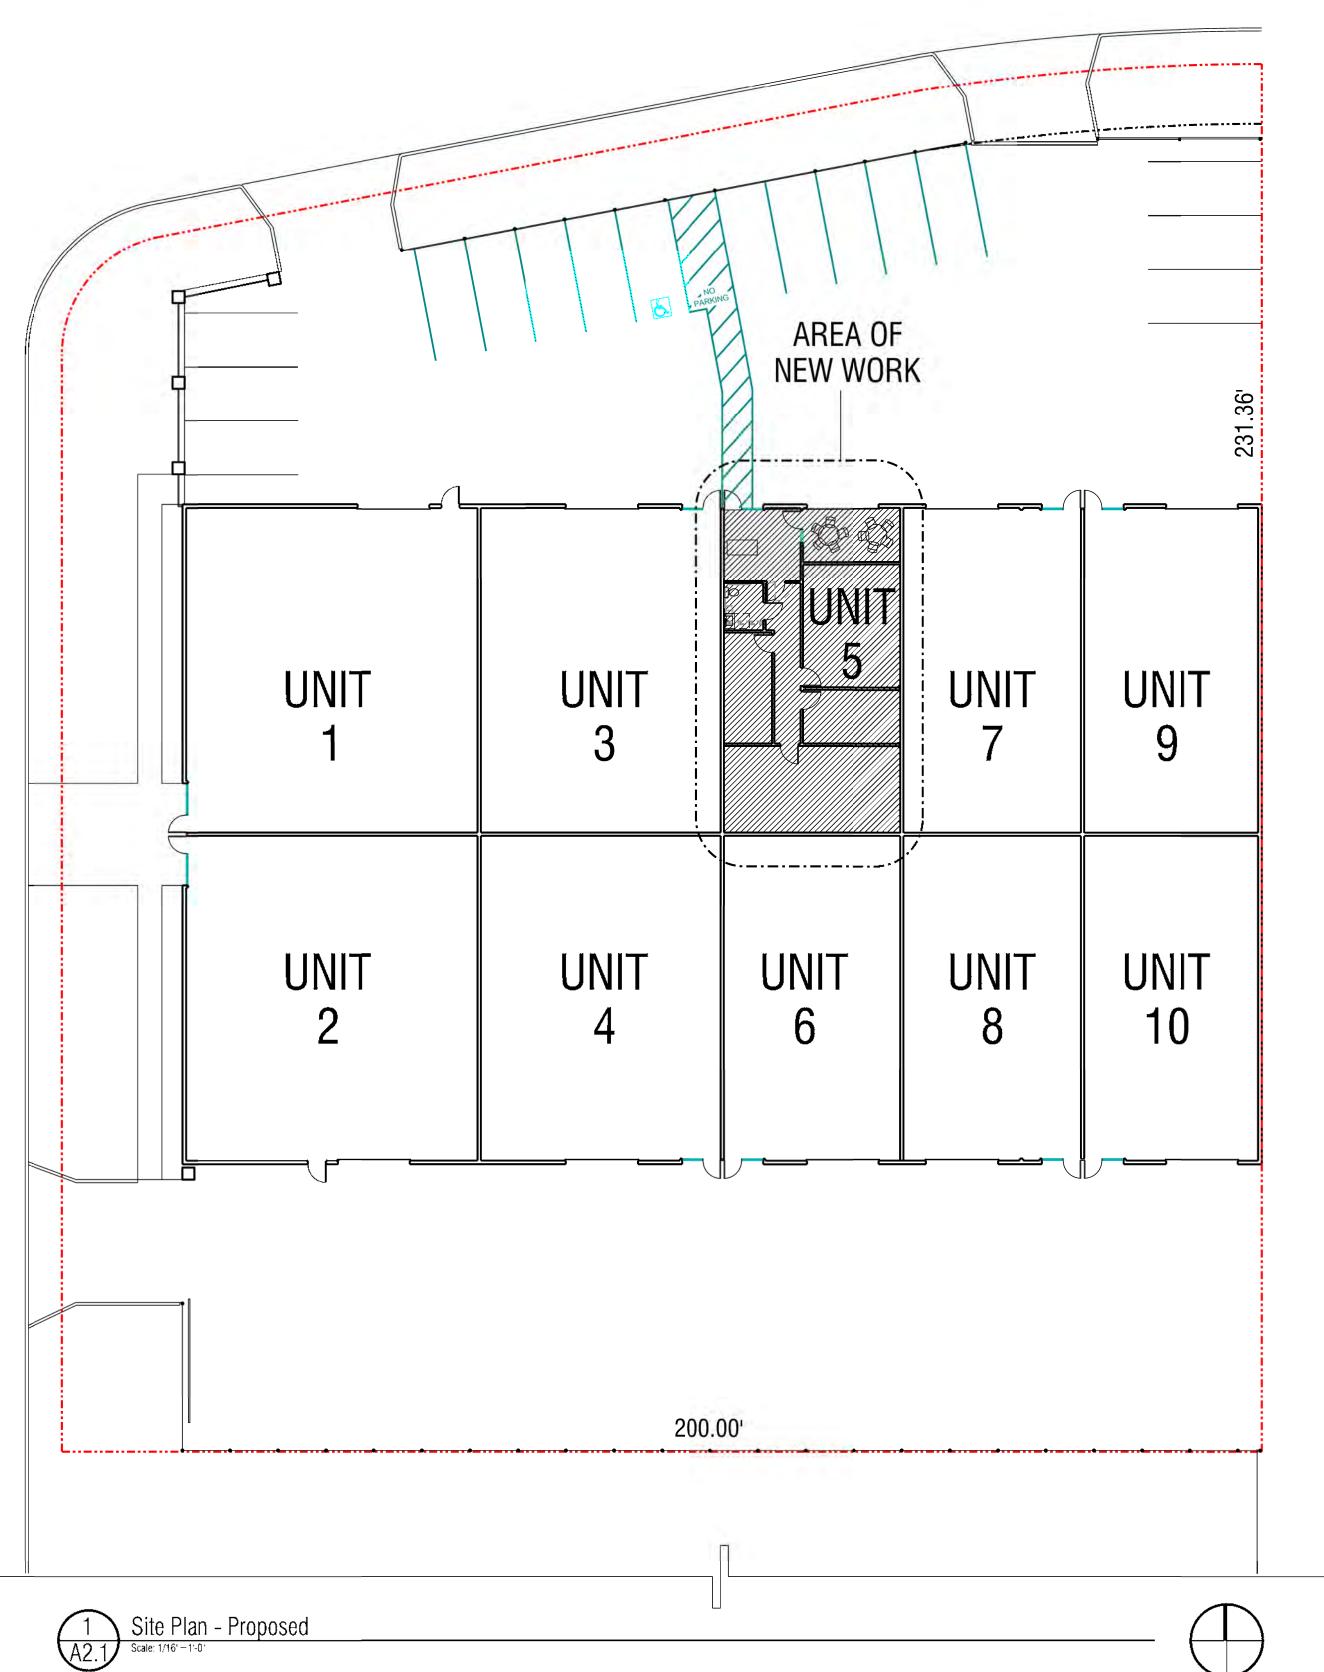

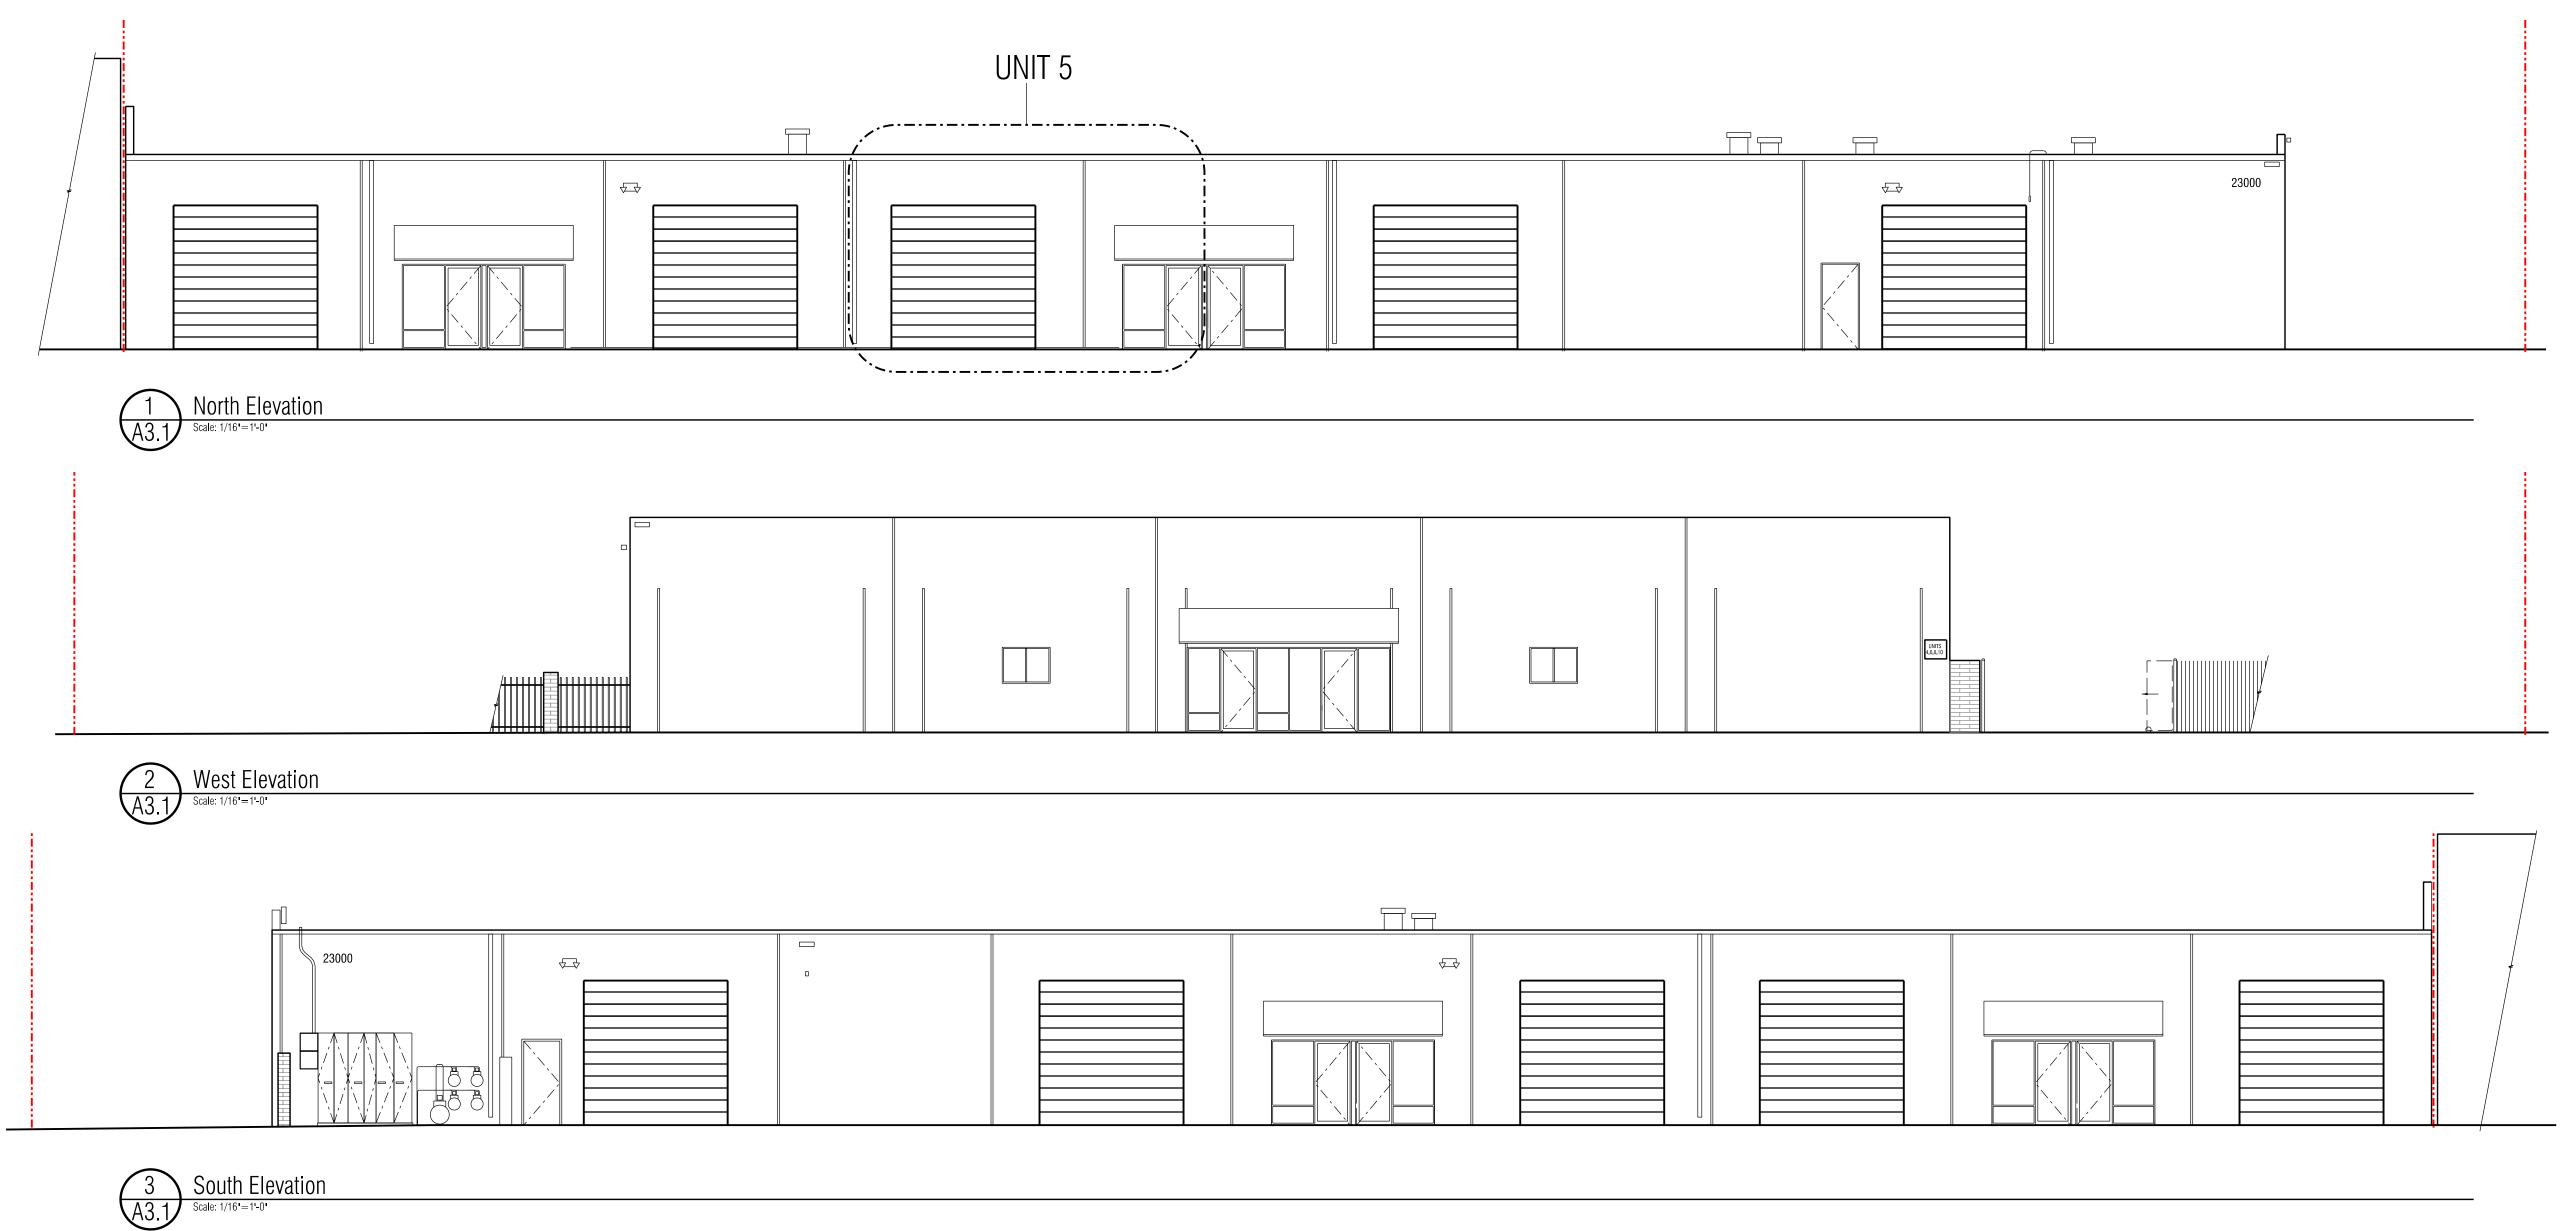

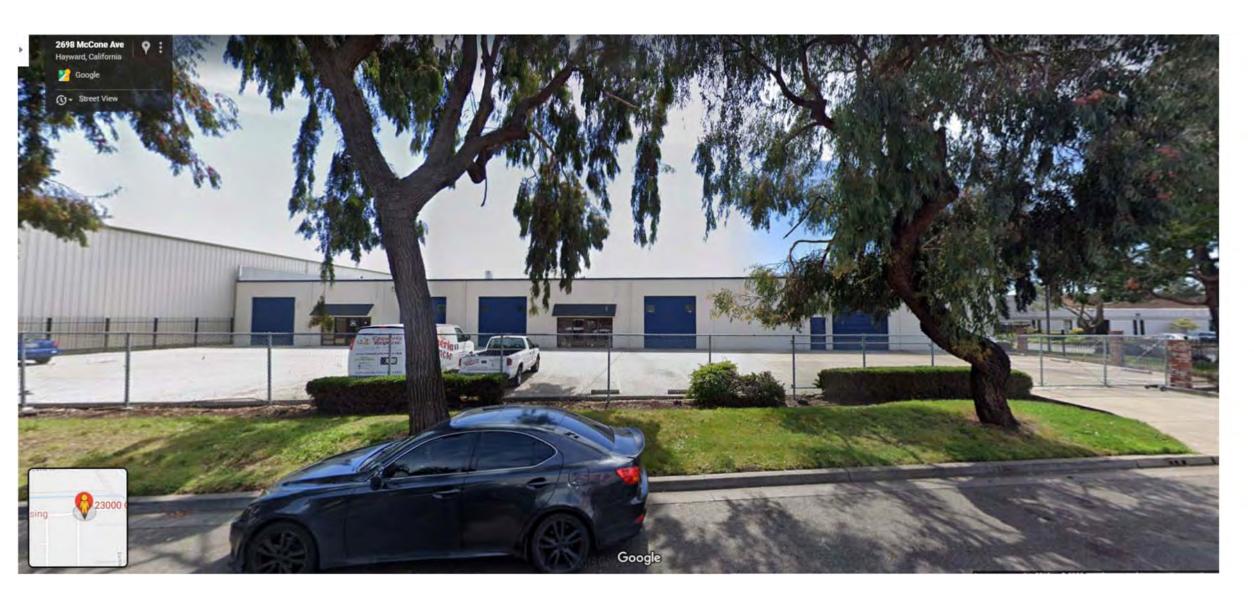



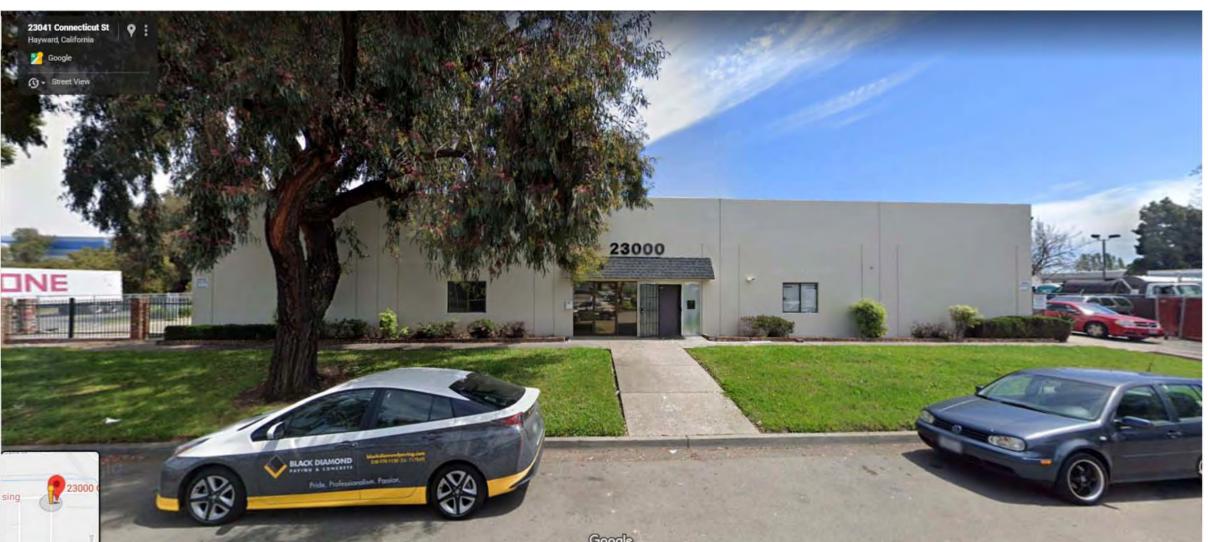

West Elevation Google Maps Photo
A3.1 Scale: NTS

NOTE: NO EXTERIOR WORK. EXISTING EXTERIOR ELEVATIONS TO REMAIN UNCHANGED



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Sheet Title: Exterior Elevations and Photos

02-21-2020 1/16" = 1'-0" Drawn: RR

Job:

Sheets